A NEW HOME BY ZERO LATITUDE:

THE WAVERLY

SOUTH HARBOR DRIVE - LOT 5 VERO BEACH, INDIAN RIVER COUNTY, FLORIDA A MERIDIAN HOMES CONSTRUCTION PROJECT



SHEET INDEX	GENERAL N	IOTES	APPLICABLE CODE:		
COVER SHEET & DATA SITE PLAN PLUMBING/SLAB PLAN DIMENSIONED 1ST FLOOR DETAILED 1ST FLOOR DETAILED 2ND FLOOR COUNTY COUNTY DETAILED 2ND FLOOR	 IT IS THE INTENT OF THE DESIGNER/ENGINEER THAT THIS WORK BE IN CONFORMANCE WITH ALL REQUIREMNENTS OF THE BUILDING AUTHORITIES HAVING JURISDICTION OVER THIS TYPE OF CONSTRUCTION AND OCCUPANCY. ALL CONTRACTORS SHALL DO THEIR WORK IN CONFORMANCE WITH ALL APPLICABLE CODES AND REGULATIONS. THE CONTRACTOR SHALL VERIFY ALL CONDITIONS AND CONDITIONS AT THE JOBSITE PRIOR TO COMMENCING WORK. CONTRACTOR SHALL REPORT ALL DISCREPANCIES IN THE DRAWING AND EXISTING CONDITIONS TO THE DESIGNER/ENGINEER PRIOR TO COMMENCING WORK. CONTRACTOR SHALL SUPPLY, LOCATE AND BUILD IN THE WORK ALL INSERTS, ANCHORS, ANGLES, PLATES, OPENINGS, SLEEVES, HANGERS, SLAB DEPRESSIONS, AND PITCHES AS MAY BE REQUIRED TO ATTACH AND ACCOMODATE OTHER WORK. THESE DOCUMENTS, AS INSTRUMENTS OF SERVICE, ARE THE PROPERTY OF THE DESIGNER/ENGINEER AND MAY NOT BE USED OR REPRODUCED WITHOUT EXPRESSED WRITTEN CONSENT OF THE DESIGNER/ENGINEER. ALL DETAILS AND SECTIONS SHOWN ON THE DRAWINGS ARE INTENDED TO BE TYPICAL AND SHALL BE CONSTRUED TO APPLY TO ANY SIMILAR SITUATION ELSEWHERE IN THE WORK EXCEPT WHERE A DIFFERENT DETAIL IS SHOWN. SUBSURFACE SOIL CONDITION INFORMATION IS NOT AVAILABLE. FOUNDATIONS ARE DESIGNED FOR A 2000 PSF SOIL 	 15. ALL WIND LOAD CALCULATIONS AND DESIGN CRITERIA ARE BASED ON A "ENCLOSED" STRUCTURE. ANY BREACH OR PENETRATION, SUCH AS WINDOWS, DOORS, GARAGE DOORS, ETC., DURING STORM EVENT WILL COMPROMISE STRUCTURAL INTEGRITY. 16. ALL DOOR AND WINDOW OPENINGS SHALL BE INSTALLED PER MANUFACTURER'S SPECIFICATIONS. 17. ALL SHEAR WALLS MUST TRANSFER LOADS TO FLOOR JOISTS OR FOUNDATION. 18. DIAPHRAGM SYSTEMS MUST BE ATTACHED TO END WALLS AND/OR SIDE WALLS. 19. TRUSSES MUST BE CAPABLE OF TRANSFERRING LATERAL LOADS TO BEARING WALLS. 20. TRUSSES, GIRDERS AND BEAM TIE DOWNS ARE SIZED PER UPLIFT REQUIREMENTS. ANY QUESTION AS TO SIZE, TYPE OR VALUE OF A NAIL, STRAP OR CLIP SHOULD BE VERIFIED BY STRUCTURAL ENGINEER. 21. ALL WINDOWS TO COMPLY WITH THE 2020 FLORIDA BUILDING CODE 139 MPH WIND LOAD REQUIREMENT. 22. SUBCONTRACTORS SHALL VERIFY ALL APPLICABLE DIMENSIONS AND FIXTURE LOCATIONS. 	SINGLE FAMILY RESIDENCE FLORIDA BUILDING CODE, 7TH EI (2020), BUILDING (FBCB) WITH SUPPLEMENTS FLORIDA BUILDING CODE, 7TH EI (2020), PLUMBING (FBCP) FLORIDA BUILDING CODE, 7TH EI (2020), MECHANICAL (FBCM) NATIONAL ELECTRICAL CODE, 20 ASCE7-16	SANFORD, FL 32771 (239) 682-2210 IDITION GENERAL CONTRACTOR: Meridian Homes 1810 Chippewa Trail	
1 GENERAL STRUCTURAL NOTES 2 STRUCTURAL DETAILS 3 FOUNDATION PLAN 4 LINTEL PLAN 5 LOWER TRUSS FRAMING PLAN 6 UPPER TRUSS FRAMING PLAN	BEARING CAPACITY. CONTRACTOR SHALL REPORT ANY DIFFERING CONDITIONS TO THE DESIGNER/ENGINEER PRIOR TO COMMENCING WORK 7. CONTRACTOR WILL INCORPORATE ALL NECESSARY LOCAL/STATE/FEDERAL BUILDING, FIRE AND HANDICAP CODES INTO THE DESIGN AND BASE PROPOSAL FOR A COMPLETE TURN-KEY PROJECT. 8. PROJECT SHALL BE TURNED OVER TO OWNER IN CLEAN CONDITION WITH ALL TRASH AND DEBRIS REMOVED FROM SIT, ALL WINDOWS AND GLASS CLEAN, ALL FLOORS CLEAN, ALL HORIZONTAL SURFACES DUSTED AND CLEANED, AND ALL TOILET AND	23. ALL INTERIOR SLABS TO HAVE STEEL TROWEL FINISH. ALL EXTERIOR SLABS TO HAVE MEDIUM BROM FINISH. 24. REFER TO TUB/SHOWER MANUFACTURER FOR DRAIN LOCATION, PER OWNER'S SELECTION. 25. ALL PLUMBING TO MEET LOCAL PLUMBING CODES. 26. PROVIDE STUB-OUT FOR ICE MAKER AT REFRIGERATOR LOCATION.	BUILDING DATA - LO	OT 5 3620 Bobbi Lane P.O. Box 5366 Titusville, FL. 32783-5366	
7 STRUCTURAL DETAILS	 CONTRACTOR SHALL HAUL ALL RUBBISH FROM SITE ON A REGULAR BASIS. DO NOT ALLOW TO ACCUMULATE. CONTRACTOR TO OBTAIN ALL PERMITS AND TO PAY ALL FEES AND TAXES. DIMENSIONS INDICATED ON THE DRAWINGS IN REFERENCE TO EXISTING CONDITIONS ARE THE BEST AVAILABLE DATA OBTAINABLE, BUT ARE NOT GUARANTEED. BEFORE PROCESSING WITH ANY WORK DEPENDENT UPON THE DATA INVOLVED, THE CONTRACTOR SHALL FIELD CHECK AND VERIEY ALL DIMENSIONS, GRADES, LINES, LEVELS OR OTHER CONDITIONS OF LIMITATIONS AT THE SITE TO AVOID CONSTRUCTION ERRORS. IF ANY WORK IS PERFORMED BY THE THE CONTRACTOR OR ANY OF HIS SUBCONTRACTORS PRIOR TO ADEQUATE VERIFICATION OF APPLICABLE DATA, ANY RESULTANT EXTRA COST FOR ADJUSTMENT OF WORK AS REQUIRED TO CONFORM TO EXISTING LIMITATIONS, SHALL BE ASSUMED BY THE CONTRACTOR WITHOUT REIMBURSEMENT OR COMPENSATION BY THE OWNER. A DESIGNATED LOCATION FOR STORAGE OF CONSTRUCTION MATERIAL AND EQUIPMENT SHALL BE DETERMINED BY OWNER AND IDENTIFIED AT THE PRECONSTRUCTION MEETING. CONTRACTOR PERSONNEL ARE CONFINED TO AREAS OF BUILDING NECESSARY FOR COMPLETING THE WORK. FREE ACCESS TO ALL PARTS OF THE BUILDING IS NOT ALLOWED. ALL CONTRACTOR TOOL BOXES, CONTAINER, ETC., ARE SUBJECT TO OWNER'S INSPECTION. CONTRACTOR IS RESPONSIBLE FOR SCHEDULING DELIVERY, RECEIVING, UNLOADING, UNCRATING, STORING, SETTING IN PLACE, AND PROTECTING FROM DAMAGE ALL NEW EQUIPMENT FURNISHED BY THE CONTRATOR. THIS SHALL ALSO APPLY TO ITEMS FURNISHED TO OWNER BY THE CONTRACTOR. 	27. REFER TO DOOR & WINDOW SCHEDULE FOR DOOR & WINDOW HEIGHTS 28. WINDOWS AND EXTERIOR DOORS SHALL COMPLY WITH FBC WIND LOAD REQUIREMENTS. (WINDOWS MUST MEET R-30) 29. USE GREENBOARD AT WET WALLS 30. PROVIDE BLOCKING AT 33*-36° AFF IN BATHROOM WALLS ABOVE WATER CLOSET, TUB/SHOWER FAUCETS AND TUB SOAP DISH FOR FUTURE GRAB BARS. 31. CONTRACTOR TO PROVIDE SITE ADDRESS PER SECTION R-319 OF 2020 FLORIDA BUILDING CODE RESIDENTIAL. 32. FOAM PLASTIC MATERIALS TO MEET THE REQUIREMENTS OF THE 2020 FLORIDA BUILDING CODE RESIDENTIAL. 33. PROTECTION OF WOOD DECAY TO MEET THE REQUIREMENTS OF THE 2020 FLORIDA BUILDING CODE RESIDENTIAL. 34. PROVIDE HANDICAP ACCESSIBILITY PER SECTION R-320 OF THE 2020 FLORIDA BUILDING CODE RESIDENTIAL. 35. THIS STRUCTURE MEETS THE REQUIREMENTS OF THE 2020 FLORIDA BUILDING CODE RESIDENTIAL. 36. TERMITE TREATING AND PROTECTION TO MEET THE REQUIREMENT OF SECTION R-318 OF THE FBC. 37. FINISHED FLOOR TO MINIMUM 12° ABOVE GROWN OF ROAD. 51NISHED FLOOR TO MINIMUM 12° ABOVE GRADE.	SECOND FLOOR TOTAL AC AREA GARAGE ENTRY PORCH LANAI WIDOW-WALK BALCONY REAR BALCONY TOTAL OTHER AREAS	1.684 SF 2.018 SF 3.702 SF 499 SF 79 SF 416 SF 325 SF 203 SF 1.522 SF ENGINEERING: ALBA ENGINEERING P.O. BOX 547774 ORANDO, FL. 32854 (407) 421-4866 DANIEL SOUTER, P.E. FL PE #63901	

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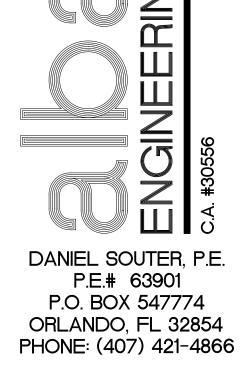
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Date	08/17/23				
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Revisions	STAIR WINDOW CHANGE				

A NEW HOME BY ZERO LATITUDE HOMES

WAVERLY SPEC HOME

OT 5 - SOUTH HARBOR DR., VERO BEACH, F

MERIDIAN CUSTOM HOMES






Date	02-20-23
Project #	22-026
Drawn by	FVC
Checked by	JH/DS
Reviewed by Interior Design & Owner	YES





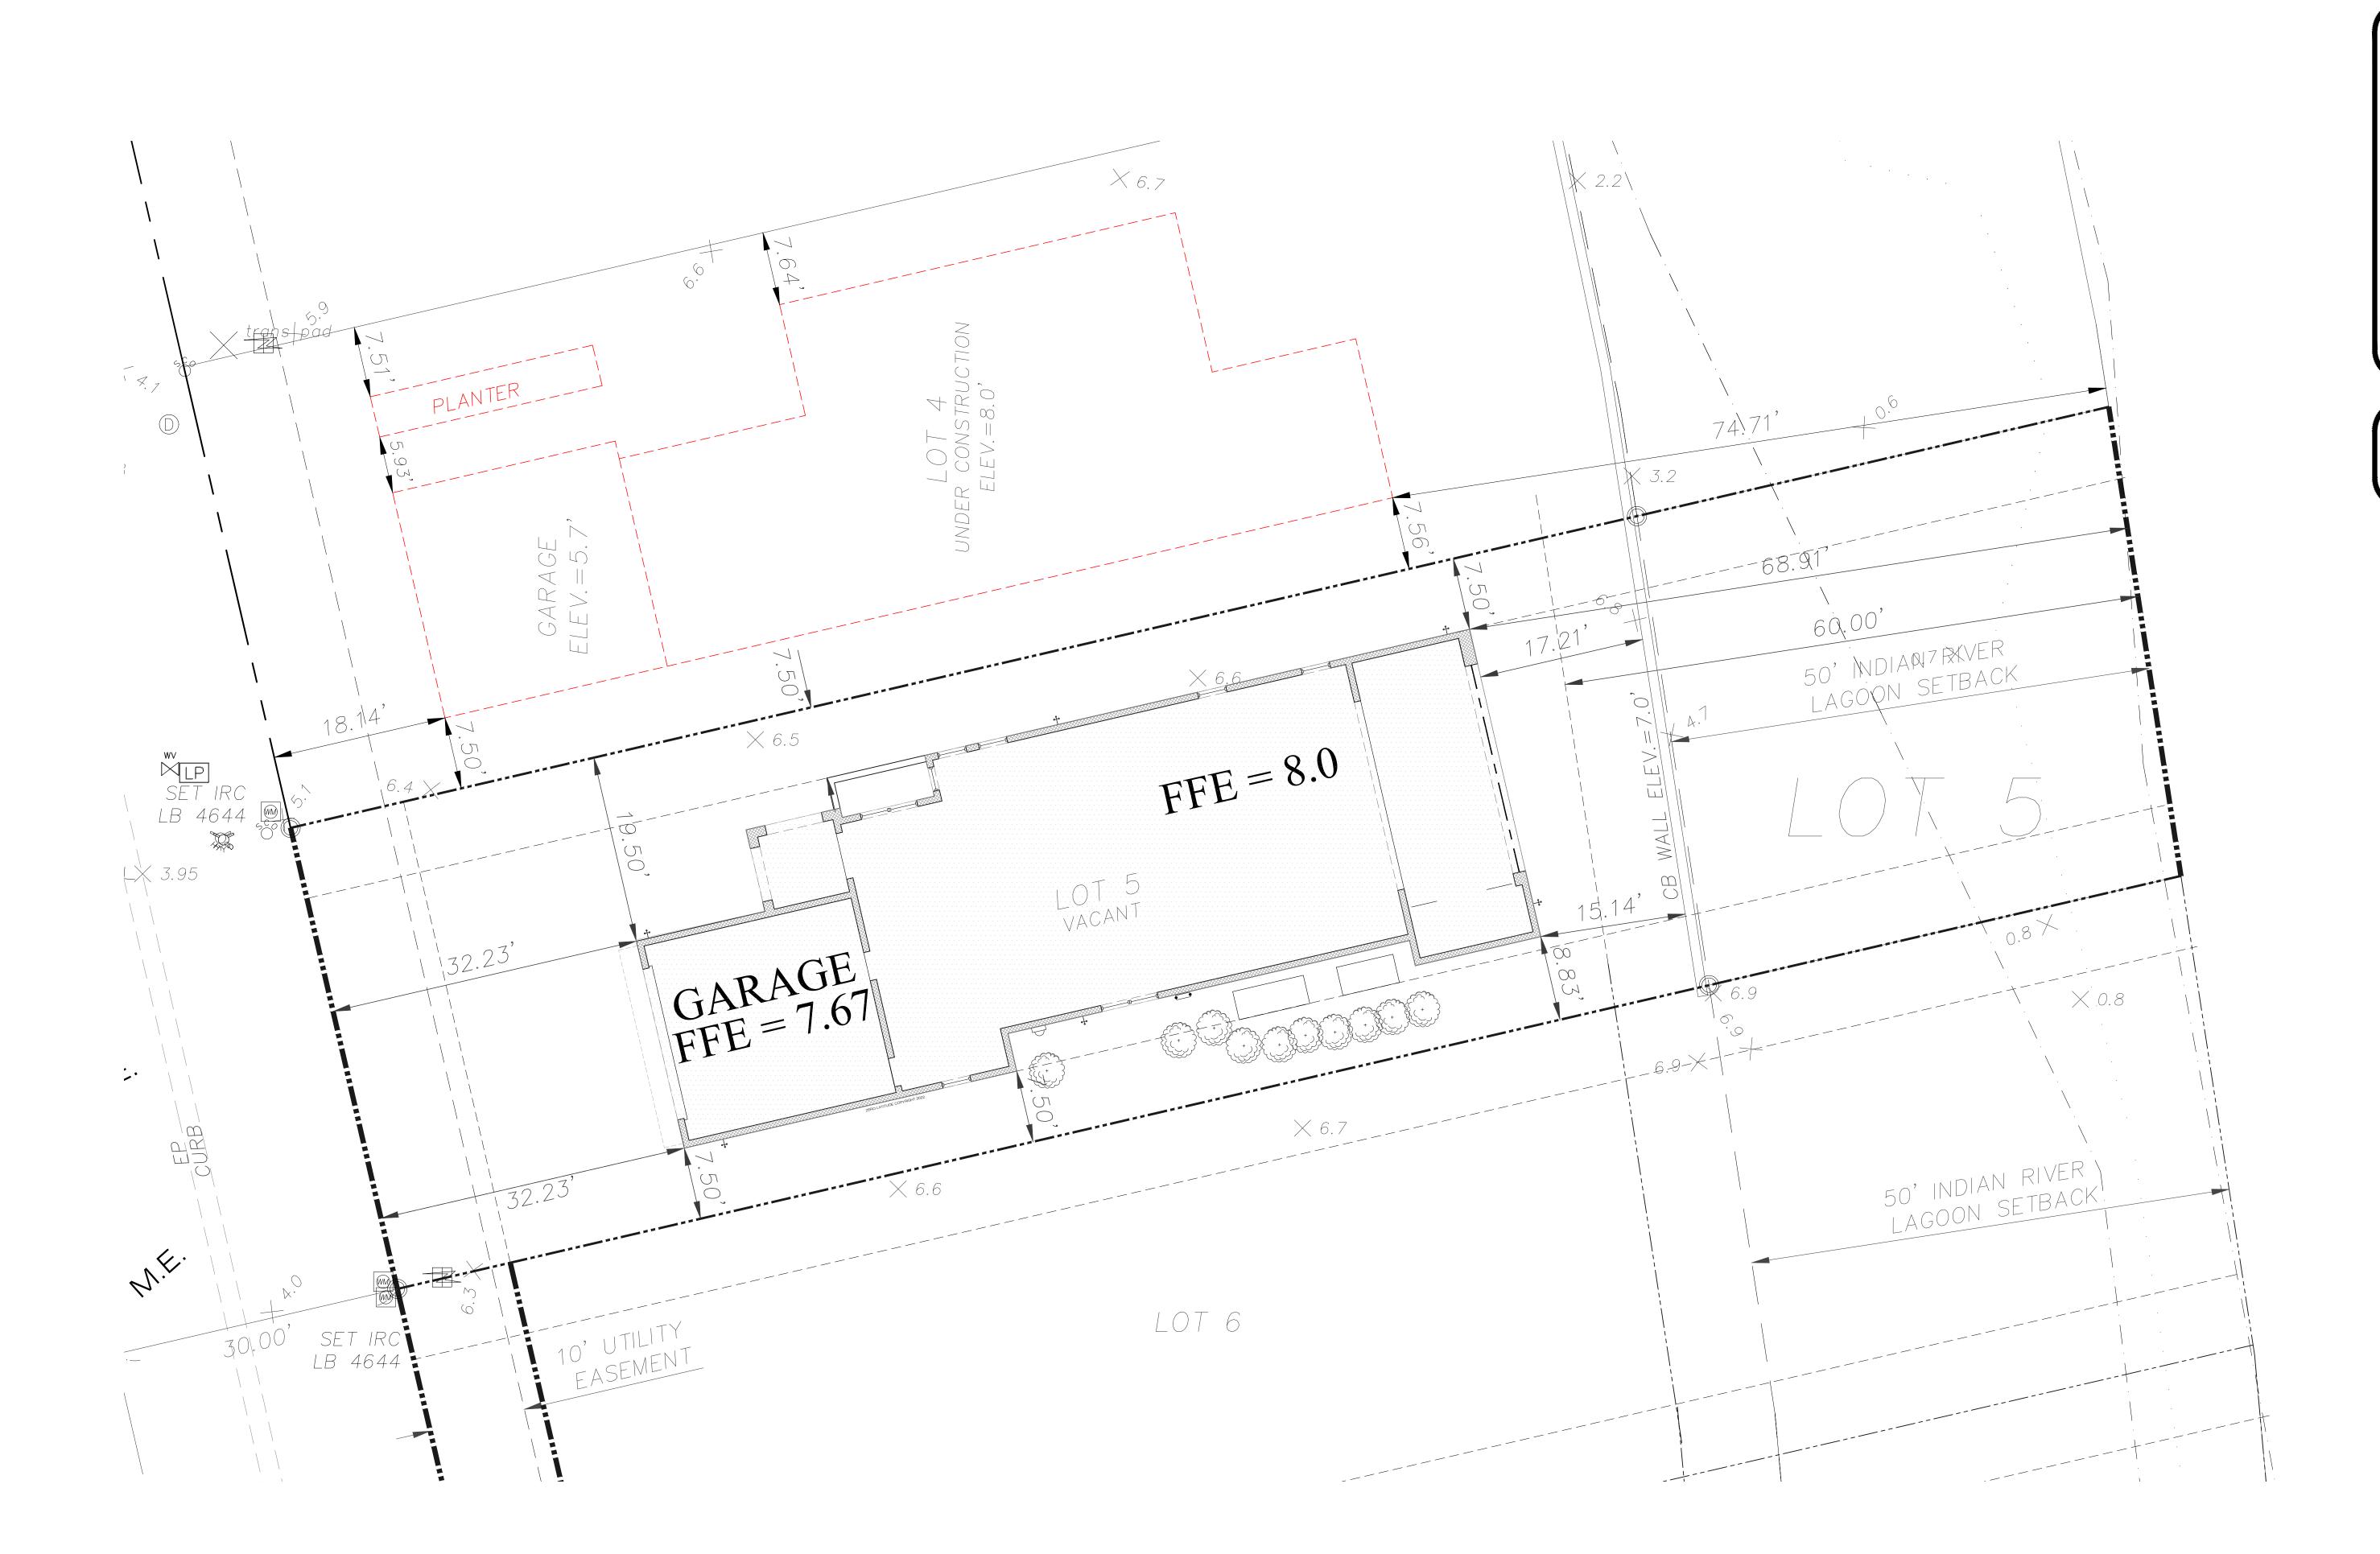

THIS IS NOT A SURVEY

THIS IS NOT A SURVEY
SITE PLAN BASED ON
BOUNDARY SURVEY BASED
ON OCCUPATION AND
MONUMENTATION.

Site Plan Notes

This is not a survey. Zero Latitude Inc. assumes no responsibility for its accuracy. The Owner and Contractor are totally responsible for placing the building on the property.

Pool Design and location, if shown, are only suggested.

Landscaping design by others.

Zero Latitude Inc. assumes no responsibilty for septic design or location. Septic ,if shown, on plan is per builder or owner requirements. Septic systems are to be designed and located per Dept. of Health requirements or as per governing codes.

Site Plan

1/8"=1'-0"

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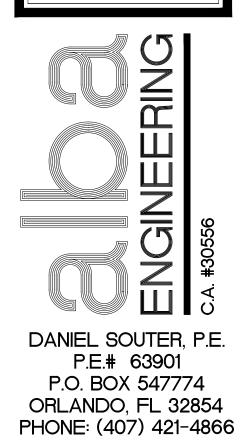
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A NEW HOME BY ZERO LATITUDE HOMES

WAVERLY SPEC HOME

DT 5 - SOUTH HARBOR DR., VERO BEACH, FL

MERIDIAN CUSTOM HOMES





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91'-4" 10'-9 1/4" 13'-8" 9'-0" 45'-2 3/4" 12'-8" 5'-11 1/4" 3'-8 1/2" CMU & FOOTING TYPE D -| --- --- --- --- ---STEP DOWN TO GRADE PLANTER --(1H)---OPENING G.C. TO VERIFY LOCATION OF FLOOR OUTLETS PRIOR TO POURING OF SLAB **ELEVATOR PIT** FRONT PORCH ELEV -0'-4" A.F.F. PIT DEPTH PER 34'-10" 5'-5" MANUFACTURER'S -LANAI SLAB ELEV -0'-4" A.F.F. SPECIFICATIONS PROVIDE RECESS FOR EXT. DOOR PER GC PROVIDE RECESS — FOR EXT. DOOR PER GC ELEVATOR PIT PER SLOPE 1":10' MANUFACTURER'S SPECIFICATION L______ 20'-4 1/16" 14'-3 1/2" 3'-4" CONTRACTOR TO VERIFY LOCATION OF REFRIGERATION LINES PRIOR TO CONTRACTOR TO VERIFY (LAV) NSTALLATION PER APPLIANCES LOCATION OF SUMMER KITCHEN CHOSEN BY OWNER MAIN FIN. FLR. ELEV -0'-0" A.F.F. LINES PRIOR TO INSTALLATION PER APPLIANCES CHOSEN BY 9'-4 1/8" GARAGE SLAB ELEV -0'-4" A.F.F. UNDER COUNTER LOW WALL PROVIDE RECESS FOR EXT. DOOR PER GC SLOPE 1":10' - PROVIDE RECESS SINK W/ FOR EXT. DOOR PER GC -DISPOSAL 9'-9 3/4" SLAB TO STEP GAS CONNECTION DOWN TO LANAI FOR COOKTOP 4" CONCRETE SLAB, SEE GENERAL STRUCTURAL NOTES. INSTA-HOT METER WALL WATER HEATER TABE V PROVIDE PROVIDE 3'-6" 2'-4" ____ ZERO LATITUDE COPYRIGHT 2022 PROVIDE (2) 4" CONCRETE MECHANICAL PADS, EQUIPMWNT PAD SIZE OF PAD

91'-4"

SIZE OF PADE DETERMINED BY G.C. PER

MANUFACTURER SPECIFICATIONS

CONTRACTOR TO VERIFY LOCATION

OF A/C CONDENSER DRAIN

42'-8"

DETERMINED BY G.C. PER

MANUFACTURER SPECIFICATIO

EQUIPMENT WATER CCONNECTIONS

CONTRACTOR TO VERIFY LOCATION OF POOL

13'-4"

TERMITE NOTES:

TREATMENT IS IN ACCORDANCE WITH RULES AND LAWS ESTABLISHED BY FLORIDA DEPARTMENT OF AGRICULTURE AND CONSUMER SERVICES."

METHODS.

TREATMENT SHALL BE PROTECTED FROM RAINFALL BY 6 MIL VAPOR BARRIER. IF RAINFALL OCCURS BEFORE

TREATMENT AROUND EXTERIOR OF FOUNDATION SHALL BE DONE AFTER REMOVAL OF CONCRETE OVER POURS OR ACCUMULATED MORTAR.

IRRIGATION/SPRINKLER INSTALLATION.)

ALL BUILDINGS SHALL HAVE PRE-CONSTRUCTION TREATMENT PER RULES AND LAWS ESTABLISHED FLORIDA DEPARTMENT OF AGRICULTURE AND CONSUMER SERVICES.

PROTECTIVE SLEEVES AROUND METALLIC PIPING PENETRATING CONCRETE SLAB-ON-SLAB GRADE FLOORS SHALL NOT BE CELLULOSE-CONTAINING MATERIALS AND RECEIVE AN APPLICATION OF TERMITICIDE IN ANNULAR SPACE BETWEEN SLEEVE

R-318 TERMITE PROTECTION SHALL BE PROVIDED BY REGISTERED TERMTICIDES, INCLUDING SOIL APPLIED PESTICIDES, BAITING SYSTEMS, AND PESTICIDES INCLUDING SOIL APPLIED PESTICIDES, BAITING SYSTEMS, AND PESTICIDES APPLIED TO WOOD, OR OTHER APPROVED METHODS OF TERMITE PROTECTION LABELED FOR USE AS A PREVENTATIVE TREATMENT TO NEW CONSTRUCTION (SEE SECTION 202, REGISTERED TERMITICIDE). UPON COMPLETION OF THE APPLICATION OF THE TERMITE PROTECTION TREATMENT, A CERTIFICATE OF COMPLIANCE SHALL BE ISSUED TO THE BUILDING DEPARTMENT BY THE LICENSED PEST CONTROL COMPANY THAT CONTAINS THE FOLLOWING STATEMENT: "THE BUILDING HAS RECEIVED A COMPLETE TREATMENT FOR THE PREVENTION OF SUBTERRANEAN TERMITES.

USE REGISTERED TERMITICIDES OR OTHER APPROVED

SOIL TREATMENTS FOR SUBTERRANEAN TERMITES.

PROTECTION TO BE DONE AFTER ALL EXCAVATION, BACKFILLING, AND COMPACTION IS COMPLETE.

DISTURBED SOIL TREATMENT MUST BE RETREATED.

BARRIER PLACEMENT, SOIL MUST BE RETREATED.

TREATMENT APPLIED UNDER ALL EXTERIOR CONCRETE OR GRADE WITHIN 1 FOOT OF PRIMARY STRUCTURE SIDEWALLS. VERTICAL CHEMICAL BARRIER SHALL BE APPLIED PROMPTLY AFTER CONSTRUCTION COMPLETION (INCLUDING LANDSCAPING AND

PLUMBING NOTES

1. REFER TO PLANS FOR SCHEDULES OF EQUIPMENT AND FIXTURES. AMERICAN STANDARD, KOHLER AND CRANE ARE CONSIDERED ACCEPTABLE AS EQUALS.

2. MAINTAIN A MINIMUM CLEARANCE OF 6" BETWEEN PLUMBING PIPING AND EQUIPMENT AND ALL FIRE/SMOKE RATED WALLS.

3. INSTALL EQUIPMENT IN ACCORDANCE WITH MANUFACTURER'S WRITTEN INSTRUCTIONS. INSTALL UNITS LEVEL AND PLUMB, FIRMLY ANCHORED IN LOCATIONS INDICATED. MAINTAIN MANUFACTURER'S CLEARANCES. SUPPORT ALL EQUIPMENT AS REQUIRED TO PROVIDE A RIGID, VIBRATION FREE INSTALLATION.

4. POTABLE WATER PIPING SHALL BE AS FOLLOWS: A. BELOW GRADE: TYPE 'K', ANNEALED TYPE TEMPERED COPPER TUBE FOR PIPE SIZES 2 INCHES AND SMALLER. BRAZE ALL JOINTS. B. ALL OTHER: TYPE 'L' DRAWN COPPER TUBE WITH WROUGHT COPPER FITTINGS AND 95-5

5. PIPING OF DISSIMILAR METALS SHALL BE DI-ELECTRICALLY SEPARATED.

TIN-ANTIMONY SOLDER.

6. FIELD VERIFY EXACT CONNECTION POINTS PRIOR TO SUBMITTING BID AND NOTIFY ENGINEER IF CONDITIONS ARE NOT AS SHOWN ON THE PLANS OR AS STATED IN THE SPECIFICATIONS. CONTRACTOR SHALL VERIFY THE OPERABILITY OF ENTIRE SYSTEM PRIOR TO TIE-IN AS FOLLOWS:

A. SNAKE SANITARY FOR A DISTANCE OF 100 FEET AND REPORT ANY BLOCKAGE. B. TEST WATER PRESSURE TO INSURE MINIMUM PSI MATCHES MOST DEMANDING EQUIPMENT SUPPLIED.

7. INSULATE ALL HOT AND COLD WATER PIPING WITH 1" THICK (K=0.23 @ 75°F) FIBERGLASS PIPE INSULATION WITH AN ALL SERVICE JACKET TO MEET LOCAL CODES AND UL FLAME SPREAD AND SMOKE DEVELOPED RATING. INSTALL PER MANUFACTURER'S RECOMMENDATIONS.

8. INSULATE THE TRAP, SANITARY AND SUPPLY PIPES UNDER LAVATORIES WITH TRUEBRO MODEL 102W "HANDI LAV GUARD" INSULATION KIT OR EQUAL.

9. INSTALL ALL NECESSARY PIPE HANGERS, SADDLES, AND CARRIERS TO PROPERLY SUPPORT ALL PIPING AND FIXTURES. HANGERS SHALL SUIT TYPE OF PIPING PROVIDED AND BE SPACED AT A MAXIMUM SPAN OF 5 FEET.

10. STERILIZE WATER SYSTEM IN ACCORDANCE WITH LOCAL CODES.

11. TEST ENTIRE PLUMBING SYSTEM IN ACCORDANCE WITH 2020 FLORIDA PLUMBING CODE.

12. PROVIDE WATER METER AND REMOTE READER PER LOCAL UTILITIES REQUIREMENT, IF APPLICABLE.

13. CONDENSATE DRAIN: PROVIDE POLYVINYL CHLORINE (PVC) SCHEDULE 40 PLASTIC PIPE (TYPE (DWV) IN CONFORMANCE WITH STANDARD ASTM D2665.

14. VALVES: PROVIDE BALL VALVE NIBCO SERIES 585-70 FOR SHUT-OFF

15. PROVIDE ACCESS PANELS WHERE REQUIRED FOR OPERATION, MAINTENANCE AND BALANCING OR PLUMBING EQUIPMENT.

16. PROVIDE WATER HAMMER ARRESTORS AT EACH **BRANCH LINE**

GAS LINES

1. FURNISH AND INSTALL A COMPLETE GAS PIPING SYSTEM.

2. GAS LINES SHALL BE BLACK STEEL, SCHEDULE 40, ASTM A-53, WITH MALLEABLE THREADED FITTINGS FOR 2" AND SMALLER, AND WITH WELDED JOINTS FOR 2-1/2" AND LARGER.

3. FURNISH AND INSTALL A GAS COCK, DIRT LEG, AND UNION CONNECTION AT EACH PIECE OF EQUIPMENT.

4. PITCH PIPING AT A UNIFORM GRADE OF 1/4" IN 15 FEET UPWARD IN DIRECTION OF FLOW. SUPPORT PIPING EVERY 5 FEET, AS DETAILED ON DRAWINGS, OR BY STANDARD INDUSTRY PRACTICE, WHICHEVER IS MORE STRINGENT.

5. GAS PIPING EXPOSED ON ROOF SHALL BE PAINTED WITH RUST-INHIBITING PAINT.

6. GAS PIPING INSTALLED IN RETURN AIR PLENUMS SHALL BE SLEEVED AND VENTED OR WELDED IN ACCORDANCE WITH THE LOCAL GAS COMPANY, LOCAL CODE AND APPLICABLE NFPA 54 CODES.

7. TESTING AND PURGING OF GAS PIPING SHALL BE DONE PER THE REQUIREMENTS OF THE LOCAL GAS COMPANY, LOCAL CODES AND APPLICABLE NFPA CODES.

8. CONTACT AND COORDINATE GAS SERVICE, METER AND REGULATOR REQUIREMENTS WITH THE LOCAL GAS COMPANY PRIOR TO BID. INCLUDE INSTALLATION COST OF GAS METER AND REGULATOR IN BID.

GAS WATER HEATER

CLEARANCES REQUIRED:


1. GREATER THAN 4'-0" FROM AN OPENING, OPERABLE WINDOW, DOOR AND FRESH AIR OPENING OR ADJACENT WALL.

2. 5'-0" FROM A NATURAL GAS METER OR REGULATOR.

PERMIT SET

FOR CONSTRUCTION



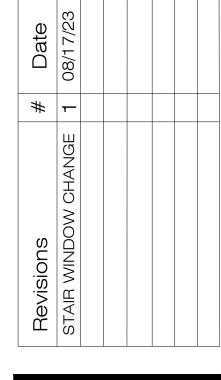


DANIEL SOUTER, P.E. P.E.# 63901 P.O. BOX 547774 ORLANDO, FL 32854 PHONE: (407) 421-4866



Date 02-20-23 Project # 22-026 Drawn by |Checked by | JH/DS Reviewed by Interior Design YES & Owner



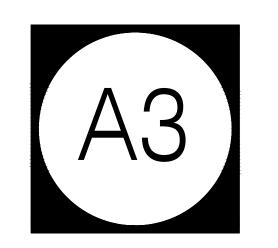

35'-4"

EGRESS WINDOWS

MEAN OF ESCAPE NOTE (EGRESS):

ALL EGRESS WINDOWS TO COMPLY W/F.B.C. R 310.1. AN OUTSIDE WINDOW OR DOOR OPERABLE FROM THE INSIDE WITHOUT THE USE OF TOOLS AND PROVIDING A CLEAR OPENING OF NOT LESS THAN 20" WIDE X 24" HIGH AND 5.7 SF IN AREA. THE BOTTOM OF THE OPENING SHALL NOT BE MORE THAN 44" OF THE FLOOR, THE MODE OF OPERATION MUST NOT REQUIRE THE USE OF A KEY, TOOL OR SPECIAL KNOWLEDGE OR EFFORT TO MAKE AVAILABLE THE REQUIRED CLEAR OPENING, AND NO PART OF THE OPERATION MECHANISM SHALL BE PLACED HIGHER THAN 54" ABOVE THE FINISHED FLOOR.

EVERY CLOSET DOOR LATCH SHALL BE SUCH THAT CHILDREN CAN OPEN THE DOOR FROM INSIDE THE CLOSET, EVERY BATHROOM DOOR SHALL BE DESIGNED TO ALLOW OPENING FROM THE OUTSIDE ENSURING AN EMERGENCY WHEN LOCKED.

FLOOR PLAN NOTES

1. DOOR BETWEEN GARAGE AND LIVING AREA OF HOUSE TO BE MINIMUM 20 MINUTE SOLID CORE

2. WALL BETWEEN GARAGE AND LIVING AREA OF HOUSE TO HAVE 1/2" FINISHED DRYWALL MINIMUM IF WALL IS NOT SOLID BLOCK.

DOOR WITH SELF CLOSING MECHANISM.

 GARAGE CEILING TO BE 1/2" FINISHED DRYWALL MINIMUM AND 5/8" TYPE X DRYWALL IF THERE IS LIVING SPACE ABOVE THE GARAGE.

4. ENCLOSED SPACE UNDER STAIRS THAT IS ACCESSED BY A DOOR OR ACCESS PANEL SHALL HAVE WALLS, UNDER-STAIR SURFACE AND ANY SOFFITS PROTECTED ON THE ENCLOSED SIDE WITH 1/2" INCH GYPSUM BOARD. (FBCR-R302.7)

 ATTIC ACCESS, MINIMUM 30"x22" OPENING. PROVIDE (1) OUTLET, SWITCH AND LIGHT IN ATTIC AT PULL-DOWN STAIRS.

6. PULL DOWN ATTIC ACCESS LADDER, MINIMUM 54"x22" OPENING.

7. AT SECOND FLOOR BALCONIES: FLOORING TO BE TILES OVER PLI-DEK WATERPROOF SYSTEM. CONTRACTOR OPTION WITH OWNER APPROVAL TO USE DUROCK OVER 60 MIL. WATERPROOF MEMBRANE OVER 30# FELT OVER 3/4" PLYWOOD W/ FLASHING (TYP.)


8. CONTRACTOR AND/OR STAIR MANUFACTURER TO VERIFY ALL STAIR HEIGHTS, RISER HEIGHTS AND TREAD DEPTHS TO ENSURE THE CORRECT DIMENSIONS WERE PROVIDED.

 CONTRACTOR TO VERIFY ALL WINDOW AND DOOR SIZES PRIOR TO ORDERING TO ENSURE ELEVATIONS PORTRAY THE CORRECT WINDOW AND DOOR HEIGHTS.

10. ALL RAILINGS ABOVE 24" A.F.F. SHALL BE 42 INCH HIGH GUARDRAILS UNLESS OTHERWISE SPECIFIED.

11. ALL SHOWERS TO BE 4 INCH RECESSED, WHERE APPLICABLE, IN FIRST FLOOR SLAB AND IN TRUSSES AT ALL OTHER FLOORS.

12. ALL TRAY CEILINGS TO BE 8 INCHES DEEP UNLESS OTHERWISE NOTED ON DRAWINGS.

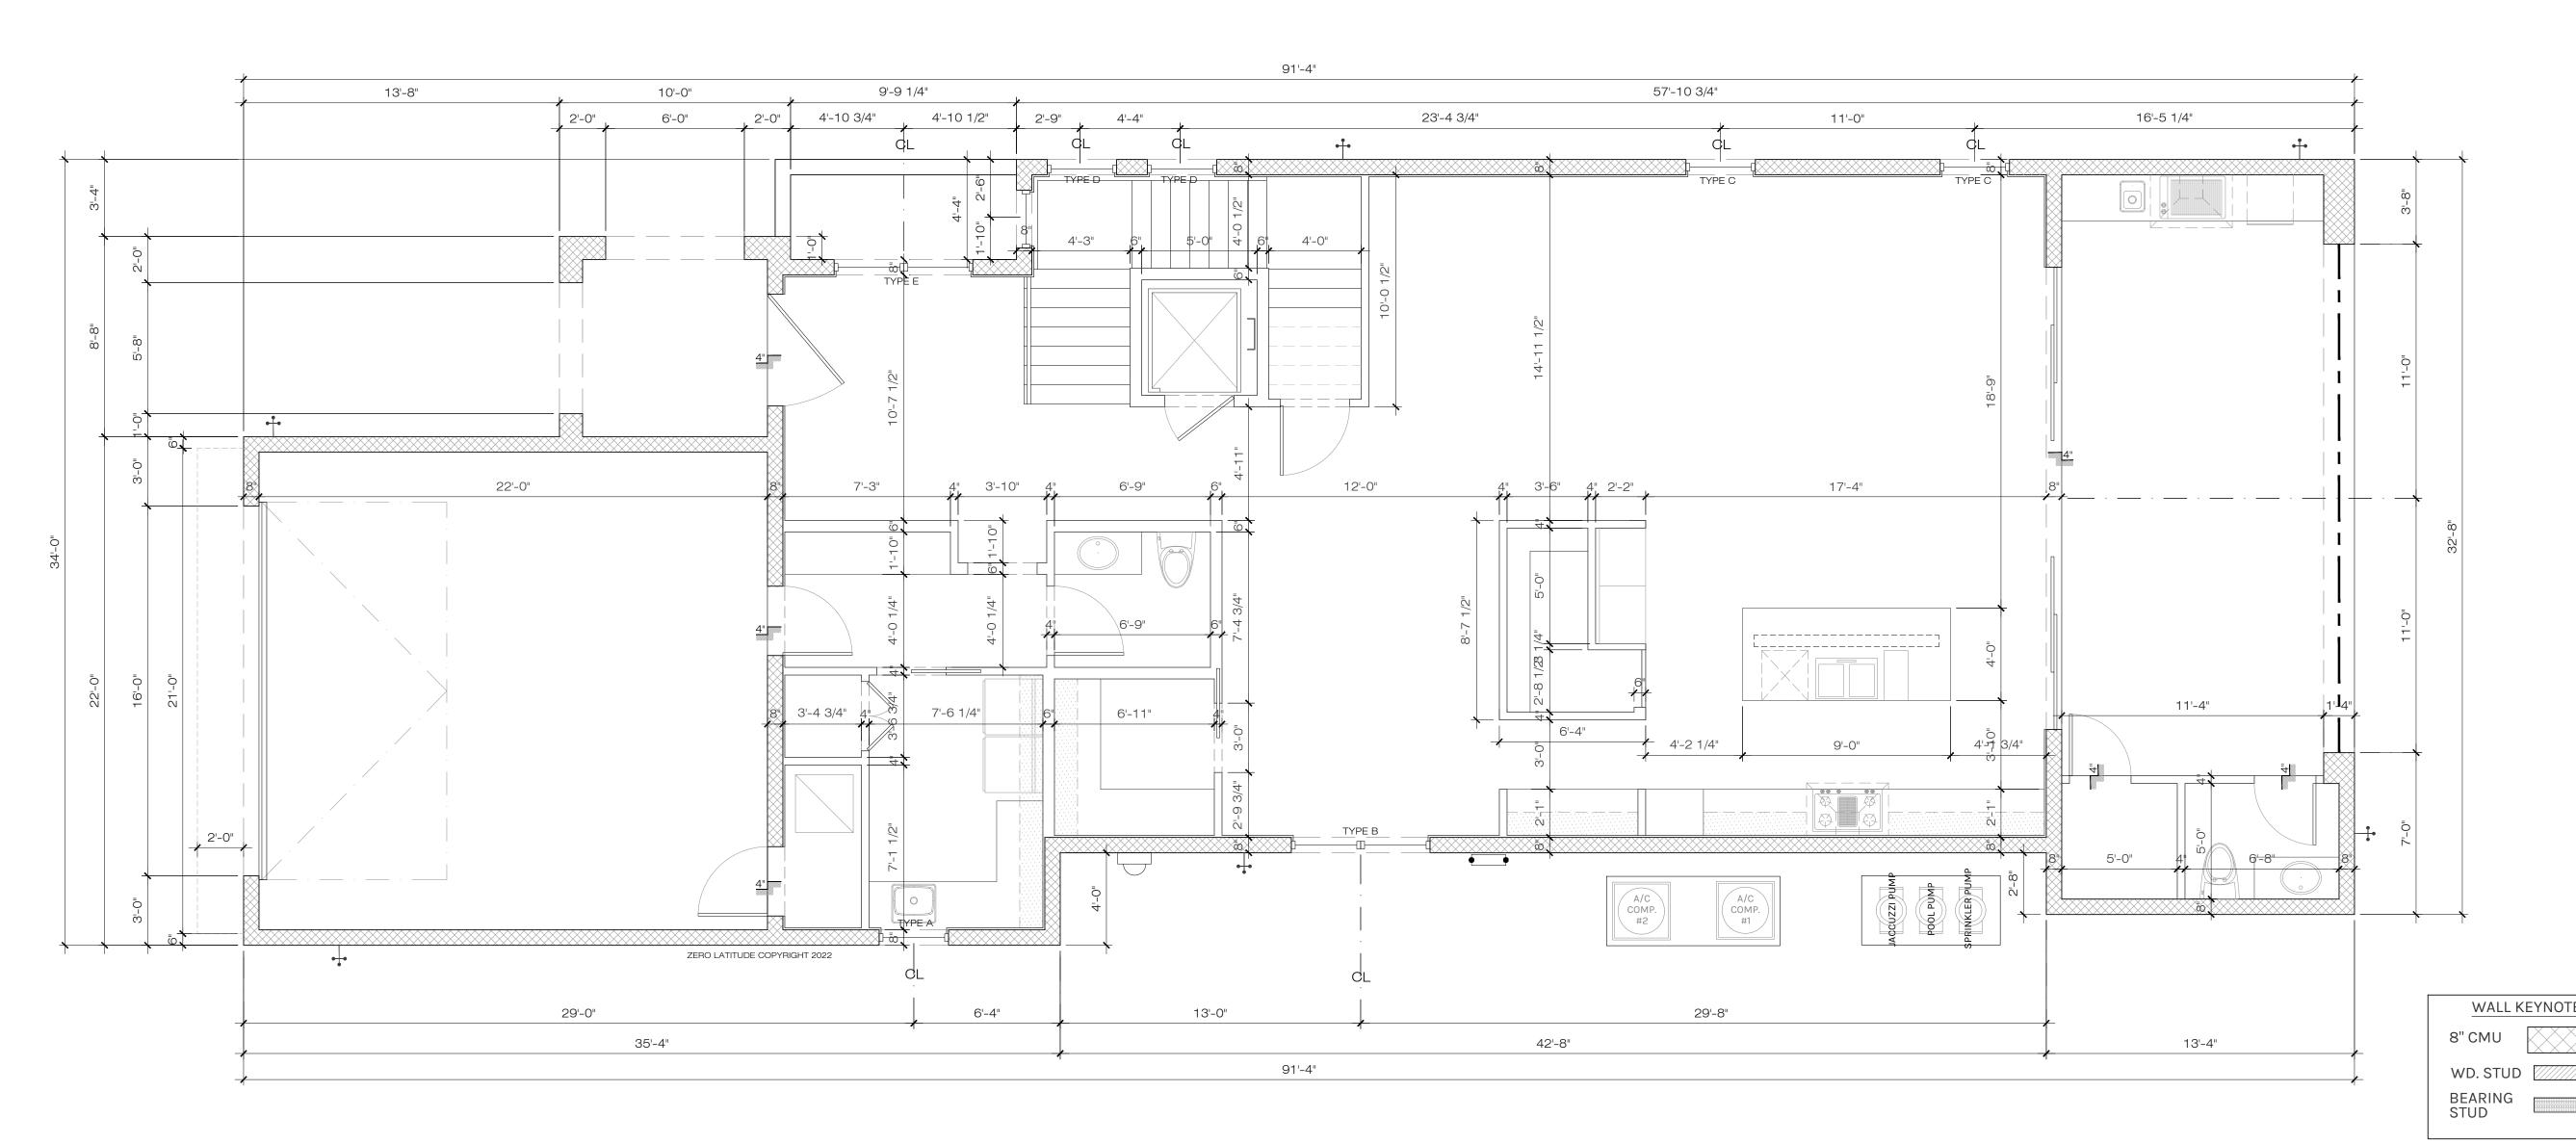

DIM 1ST FLOOR PLAN

SCALE: 1/4" = 1'-0"

PERMIT SET FOR CONSTRUCTION

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HIS PLAN IS PROTECTED UNDER THE FEDERAL COPPIGHTS LAWS. THE ORIGINAL PURCHASER IS LAVIN IS PROFINED.


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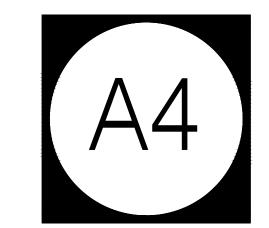


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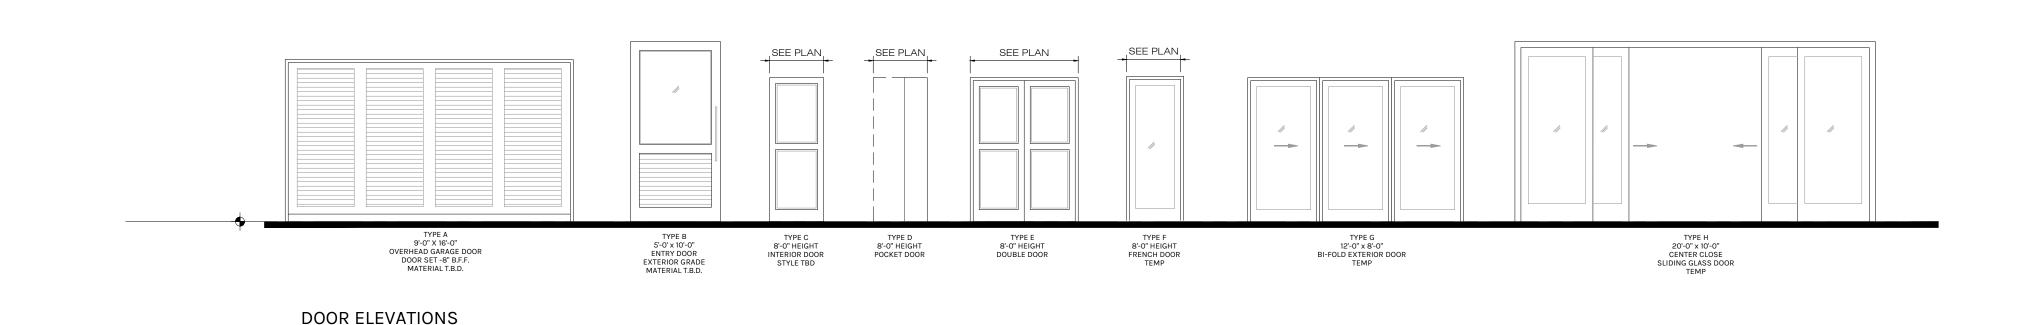
	WAVERLY - WINDOW SCHEDULE										
UNIT #.	UNIT SIZE	TYPE	TOP OF WINDOW	LOCATION	EGRESS	REMARKS					
FIRST FLOOR											
1A	36" x 72"	Α	8' -0" A.F.F.	LAUNDRY		FIXED					
1B	(2)36" x 84"	D	10' -0" A.F.F.	DINING ROOM		FIXED - MULLED					
1C	36" x 84"	В	10' -0" A.F.F.	LIVING ROOM		FIXED					
1D	36" x 84"	В	10' -0" A.F.F.	LIVING ROOM		FIXED					
1Ě Ť	(2)36' x 202" (MIXED)	Č	22' -8" A.F.F.	STAIRCASE		SEE WINDOW ELEVATIONS					
1F	(2)36' x 202" (MIXED)	С	22' -8" A.F.F.	STAIRCASE		SEE WINDOW ELEVATIONS					
1G	(2)36' x 202" (MIXED)	С	22' -8" A.F.F.	STAIRCASE		SEE WINDOW ELEVATIONS					
1H	(2)36" x 84"		10' -0" A.F.F.	ENTRY VESTIBULE		FIXED - MULLED					


36 36"×72" FIXED 36"×84" FIXED	36 36" × 83" FIXED TEMP 36" × 108" FIXED TEMP	FIXED FIXED TEMP	48 48"×24" FIXED TEMP	30 30" x 84" CASMNT 80 0 27 27 27 27 27 27 27 27 27 27 27 27 27	72 36 36 36" x 72" CASMNT CASMNT EGRESS EGRESS	30 84 87 88 87 88 88 88 88 88 88 88	48" x 60" FIXED TEMP	36 36" x 36" FIXED TEMP	27 CASMNT 02 L 27 27 27 27 27 27 27 27 27 27 27 27 27	72 36 36 36" x 72" FIXED TEMP 36" x 72" FIXED TEMP
TYPE A TYPE B FIXED W/ TRANSOM	TYPE C FIXED 3 WINDOW PATTERN	TYPE D FIXED (DOUBLE) MULLED UNIT	TYPE E FIXED - TRANSOM TEMPERED	TYPE F CASEMENT EGRESS	TYPE G DOUBLE CASEMENT EGRESS - MULLED NO MULLIONS	TYPE H FIXED TEMPERED	TYPE J FIXED TEMPERED	TYPE K FIXED TEMPERED	TYPE L CASEMENT EGRESS	TYPE M FIXED (DOUBLE) MULLED UNIT

WINDOW	ELEVATIONS

- FOR EXACT SILL HEIGHT ABOVE FINISHED FLOOK (A.F.F.), SEE ELEVATIONS. FLOOK PLANS ONLY SHOW ALPHABETICAL NOTATION. SEE WINDOW SCHEDULE FOR FULL WINDOW INFORMATION.
- 2. ALL WINDOWS THAT HAVE A SILL LOWER THAN 24 INCHES A.F.F. WILL HAVE TEMPERED
- 3. ALL WINDOWS/GLASS SHALL MEET OR EXCEED THE FLORIDA BUILDING CODE (MIAMI-DADE COUNTY) AND LOCAL ORDINANCES FOR HURRICANE REQUIREMENTS.

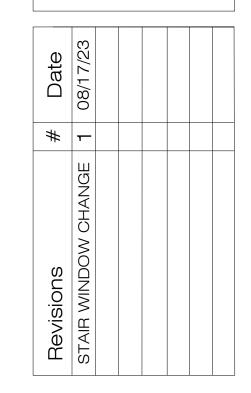				WAVERLY -	DOOR SCHED	ULE		
UNIT #.	WIDTH	HEIGH'	THKS.	MATERIALS		DOOR	LOCATION	NOTES
				DOOR	FRAME	TYPE		
FIRST FI	LOOR							
1	5'-0"	10'-0"	1 1/2"	WOOD/GLASS	WOOD	В	ENTRY DOOR	EXTERIOR GRADE PIVOT DOOR
2	16'-0"	9'-0"	1 1/2"	WOOD	WOOD	Α	GARAGE	OVERHEAD GARAGE DOOR
3	3'-0"	8'-0"	1 1/2"	SC	WOOD	С	GARAGE - ENTRY HOUSE	
4	3'-0"	8'-0"	1 1/2"	SC	WOOD	С	GARAGE - STORAGE	
5	3'-0"	8'-0"	1 1/2"	SC	WOOD	D	LAUNDRY	POCKET DOOR
6	(2)1'-8"	9'-0"	1 1/2"	WOOD	WOOD	E	LAUNDRY - CLOSET	DOUBLE DOOR
7	3'-0"	8'-0"	1 1/2"	SC	WOOD	С	POWDER	POCKET DOOR
8	3'-0"	8'-0"	1 1/2"	SC	WOOD	С	ELEVATOR	PER ELEVATOR MANUF. SPECS.
9	3'-0"	8'-0"	1 1/2"	SC	WOOD	С	WINE ROOM	
10	3'-0"	8'-0"	1 1/2"	SC	WOOD	D	FLEX SPACE	POCKET DOOR
11	(4)4'-0"	10'-0"	1 1/2"	ALUMINUM/GLASS	ALUMINIUM	Н	LIVING ROOM - LANAI	FLODING GLASS DOORS - TEMP
12	2'-8"	8'-0"	1 1/2"	SC	WOOD	С	POOL STORAGE	EXTERIOR GRADE
13	2'-8"	8'-0"	1 1/2"	sc	WOOD	С	POOL BATH	EXTERIOR GRADE



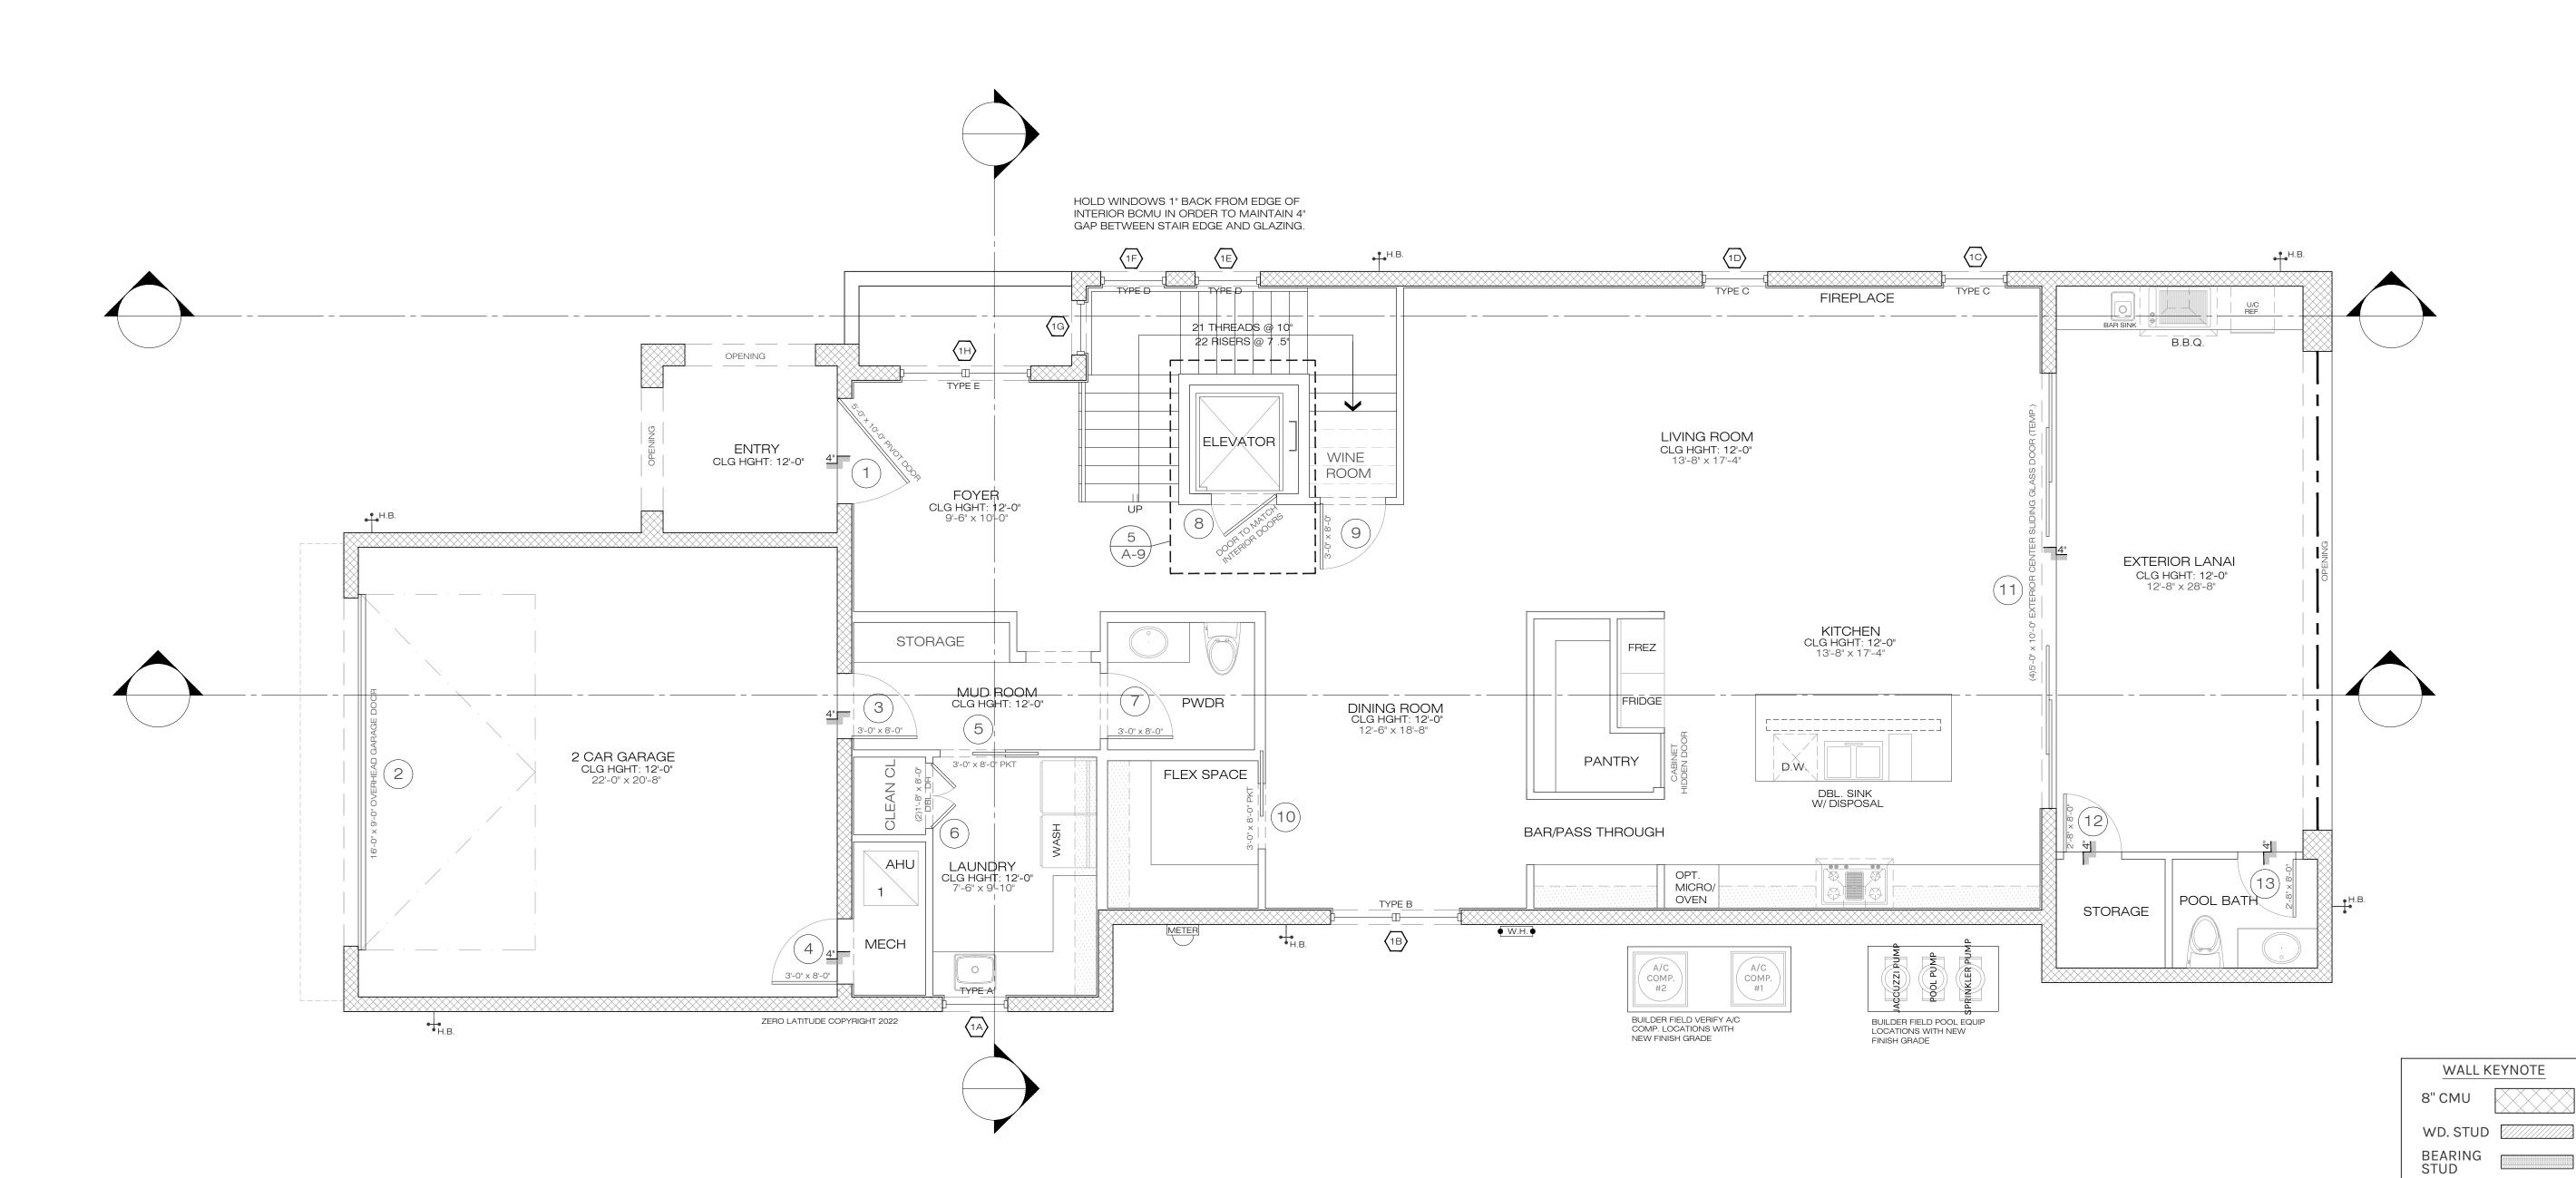

DETAIL 1ST FLOOR PLAN

A5 SCALE: 1/4" = 1'-0"

Va	COMPONENTS AND CLADDING WINDOW AND DOOR WIND PRESSURE SCHEDULE Vasd VALUES (EXP C. 160mph Vult)							
	AREA	PRESSURE (PSF)						
1ST STORY	10 S.F. 20 S.F. 50 S.F. 100 S.F.	+33.4, -44.8 +31.9, -41.7 +30.0, -37.8 +28.4, -34.7						
2ND STORY	10 S.F. 20 S.F. 50 S.F. 100 S.F.	+35.6, -47.7 +34.1, -44.5 +32.0, -40.2 +30.3, -37.0						

- 1. DOOR BETWEEN GARAGE AND LIVING AREA OF HOUSE TO BE MINIMUM 20 MINUTE SOLID CORE
- 2. WALL BETWEEN GARAGE AND LIVING AREA OF HOUSE TO HAVE 1/2" FINISHED DRYWALL
- 3. GARAGE CEILING TO BE 1/2" FINISHED DRYWALL MINIMUM AND 5/8" TYPE X DRYWALL IF THERE IS
- 4. ENCLOSED SPACE UNDER STAIRS THAT IS ACCESSED BY A DOOR OR ACCESS PANEL SHALL HAVE WALLS, UNDER-STAIR SURFACE AND ANY SOFFITS PROTECTED ON THE ENCLOSED SIDE
- 5. ATTIC ACCESS, MINIMUM 30"x22" OPENING. PROVIDE (1) OUTLET, SWITCH AND LIGHT IN ATTIC AT PULL-DOWN STAIRS.
- 6. PULL DOWN ATTIC ACCESS LADDER, MINIMUM 54"x22" OPENING.
- 7. AT SECOND FLOOR BALCONIES: FLOORING TO BE TILES OVER PLI-DEK WATERPROOF SYSTEM. USE DUROCK OVER 60 MIL. WATERPROOF MEMBRANE OVER 30# FELT OVER 3/4" PLYWOOD
- VERIFY ALL STAIR HEIGHTS, RISER HEIGHTS AND TREAD DEPTHS TO ENSURE THE CORRECT DIMENSIONS WERE PROVIDED.
- SIZES PRIOR TO ORDERING TO ENSURE ELEVATIONS PORTRAY THE CORRECT WINDOW AND DOOR HEIGHTS.
- APPLICABLE, IN FIRST FLOOR SLAB AND IN TRUSSES AT ALL OTHER FLOORS.
- 12. ALL TRAY CEILINGS TO BE 8 INCHES DEEP UNLESS

EGRESS WINDOWS

MEAN OF ESCAPE NOTE (EGRESS):

ALL EGRESS WINDOWS TO COMPLY W/F.B.C. R 310.1. AN OUTSIDE WINDOW OR DOOR OPERABLE FROM THE INSIDE WITHOUT THE USE OF TOOLS AND PROVIDING A CLEAR OPENING OF NOT LESS THAN 20" WIDE X 24" HIGH AND 5.7 SF IN AREA. THE BOTTOM OF THE OPENING SHALL NOT BE MORE THAN 44" OF THE FLOOR, THE MODE OF OPERATION MUST NOT REQUIRE THE USE OF A KEY, TOOL OR SPECIAL KNOWLEDGE OR EFFORT TO MAKE AVAILABLE THE REQUIRED CLEAR OPENING, AND NO PART OF THE OPERATION MECHANISM SHALL BE PLACED HIGHER THAN 54" ABOVE THE

EVERY CLOSET DOOR LATCH SHALL BE SUCH THAT CHILDREN CAN OPEN THE DOOR FROM INSIDE THE CLOSET, EVERY BATHROOM DOOR SHALL BE DESIGNED TO ALLOW OPENING FROM THE OUTSIDE ENSURING AN EMERGENCY WHEN LOCKED.

FLOOR PLAN NOTES

- DOOR WITH SELF CLOSING MECHANISM.
- MINIMUM IF WALL IS NOT SOLID BLOCK.
- LIVING SPACE ABOVE THE GARAGE.
- WITH 1/2" INCH GYPSUM BOARD. (FBCR-R302.7)
- CONTRACTOR OPTION WITH OWNER APPROVAL TO W/ FLASHING (TYP.)
- 8. CONTRACTOR AND/OR STAIR MANUFACTURER TO
- 9. CONTRACTOR TO VERIFY ALL WINDOW AND DOOR
- 10. ALL RAILINGS ABOVE 24" A.F.F. SHALL BE 42 INCH HIGH GUARDRAILS UNLESS OTHERWISE SPECIFIED.
- 11. ALL SHOWERS TO BE 4 INCH RECESSED, WHERE
- OTHERWISE NOTED ON DRAWINGS.

FINISHED FLOOR.

PERMIT SET

FOR CONSTRUCTION



DANIEL SOUTER, P.E.

| # |--|


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- 1		
	Date	02-20-23
	Project #	22-026
	Drawn by	FVC
	Checked by	JH/DS
	Reviewed by	

Interior Design YES

& Owner



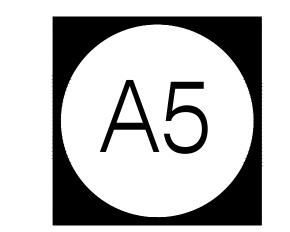

EGRESS WINDOWS

MEAN OF ESCAPE NOTE (EGRESS):

ALL EGRESS WINDOWS TO COMPLY W/F.B.C. R 310.1. AN OUTSIDE WINDOW OR DOOR OPERABLE FROM THE INSIDE WITHOUT THE USE OF TOOLS AND PROVIDING A CLEAR OPENING OF NOT LESS THAN 20" WIDE X 24" HIGH AND 5.7 SF IN AREA. THE BOTTOM OF THE OPENING SHALL NOT BE MORE THAN 44" OF THE FLOOR, THE MODE OF OPERATION MUST NOT REQUIRE THE USE OF A KEY, TOOL OR SPECIAL KNOWLEDGE OR EFFORT TO MAKE AVAILABLE THE REQUIRED CLEAR OPENING, AND NO PART OF THE OPERATION MECHANISM SHALL BE PLACED HIGHER THAN 54" ABOVE THE FINISHED FLOOR.

EVERY CLOSET DOOR LATCH SHALL BE SUCH THAT CHILDREN CAN OPEN THE DOOR FROM INSIDE THE CLOSET, EVERY BATHROOM DOOR SHALL BE DESIGNED TO ALLOW OPENING FROM THE OUTSIDE ENSURING AN EMERGENCY WHEN LOCKED.

1. DOOR BETWEEN GARAGE AND LIVING AREA OF HOUSE TO BE MINIMUM 20 MINUTE SOLID CORE DOOR WITH SELF CLOSING MECHANISM.

FLOOR PLAN NOTES

2. WALL BETWEEN GARAGE AND LIVING AREA OF HOUSE TO HAVE 1/2" FINISHED DRYWALL MINIMUM IF WALL IS NOT SOLID BLOCK.

3. GARAGE CEILING TO BE 1/2" FINISHED DRYWALL MINIMUM AND 5/8" TYPE X DRYWALL IF THERE IS LIVING SPACE ABOVE THE GARAGE.

4. ENCLOSED SPACE UNDER STAIRS THAT IS ACCESSED BY A DOOR OR ACCESS PANEL SHALL HAVE WALLS, UNDER-STAIR SURFACE AND ANY SOFFITS PROTECTED ON THE ENCLOSED SIDE WITH 1/2" INCH GYPSUM BOARD. (FBCR-R302.7)

5. ATTIC ACCESS, MINIMUM 30"x22" OPENING. PROVIDE (1) OUTLET, SWITCH AND LIGHT IN ATTIC AT PULL-DOWN STAIRS.

6. PULL DOWN ATTIC ACCESS LADDER, MINIMUM 54"x22" OPENING.

7. AT SECOND FLOOR BALCONIES: FLOORING TO BE TILES OVER PLI-DEK WATERPROOF SYSTEM. CONTRACTOR OPTION WITH OWNER APPROVAL TO USE DUROCK OVER 60 MIL. WATERPROOF MEMBRANE OVER 30# FELT OVER 3/4" PLYWOOD W/ FLASHING (TYP.)


8. CONTRACTOR AND/OR STAIR MANUFACTURER TO VERIFY ALL STAIR HEIGHTS, RISER HEIGHTS AND TREAD DEPTHS TO ENSURE THE CORRECT DIMENSIONS WERE PROVIDED.

9. CONTRACTOR TO VERIFY ALL WINDOW AND DOOR SIZES PRIOR TO ORDERING TO ENSURE ELEVATIONS PORTRAY THE CORRECT WINDOW AND DOOR HEIGHTS.

10. ALL RAILINGS ABOVE 24" A.F.F. SHALL BE 42 INCH HIGH GUARDRAILS UNLESS OTHERWISE SPECIFIED.

11. ALL SHOWERS TO BE 4 INCH RECESSED, WHERE APPLICABLE, IN FIRST FLOOR SLAB AND IN TRUSSES AT ALL OTHER FLOORS.


12. ALL TRAY CEILINGS TO BE 8 INCHES DEEP UNLESS OTHERWISE NOTED ON DRAWINGS.

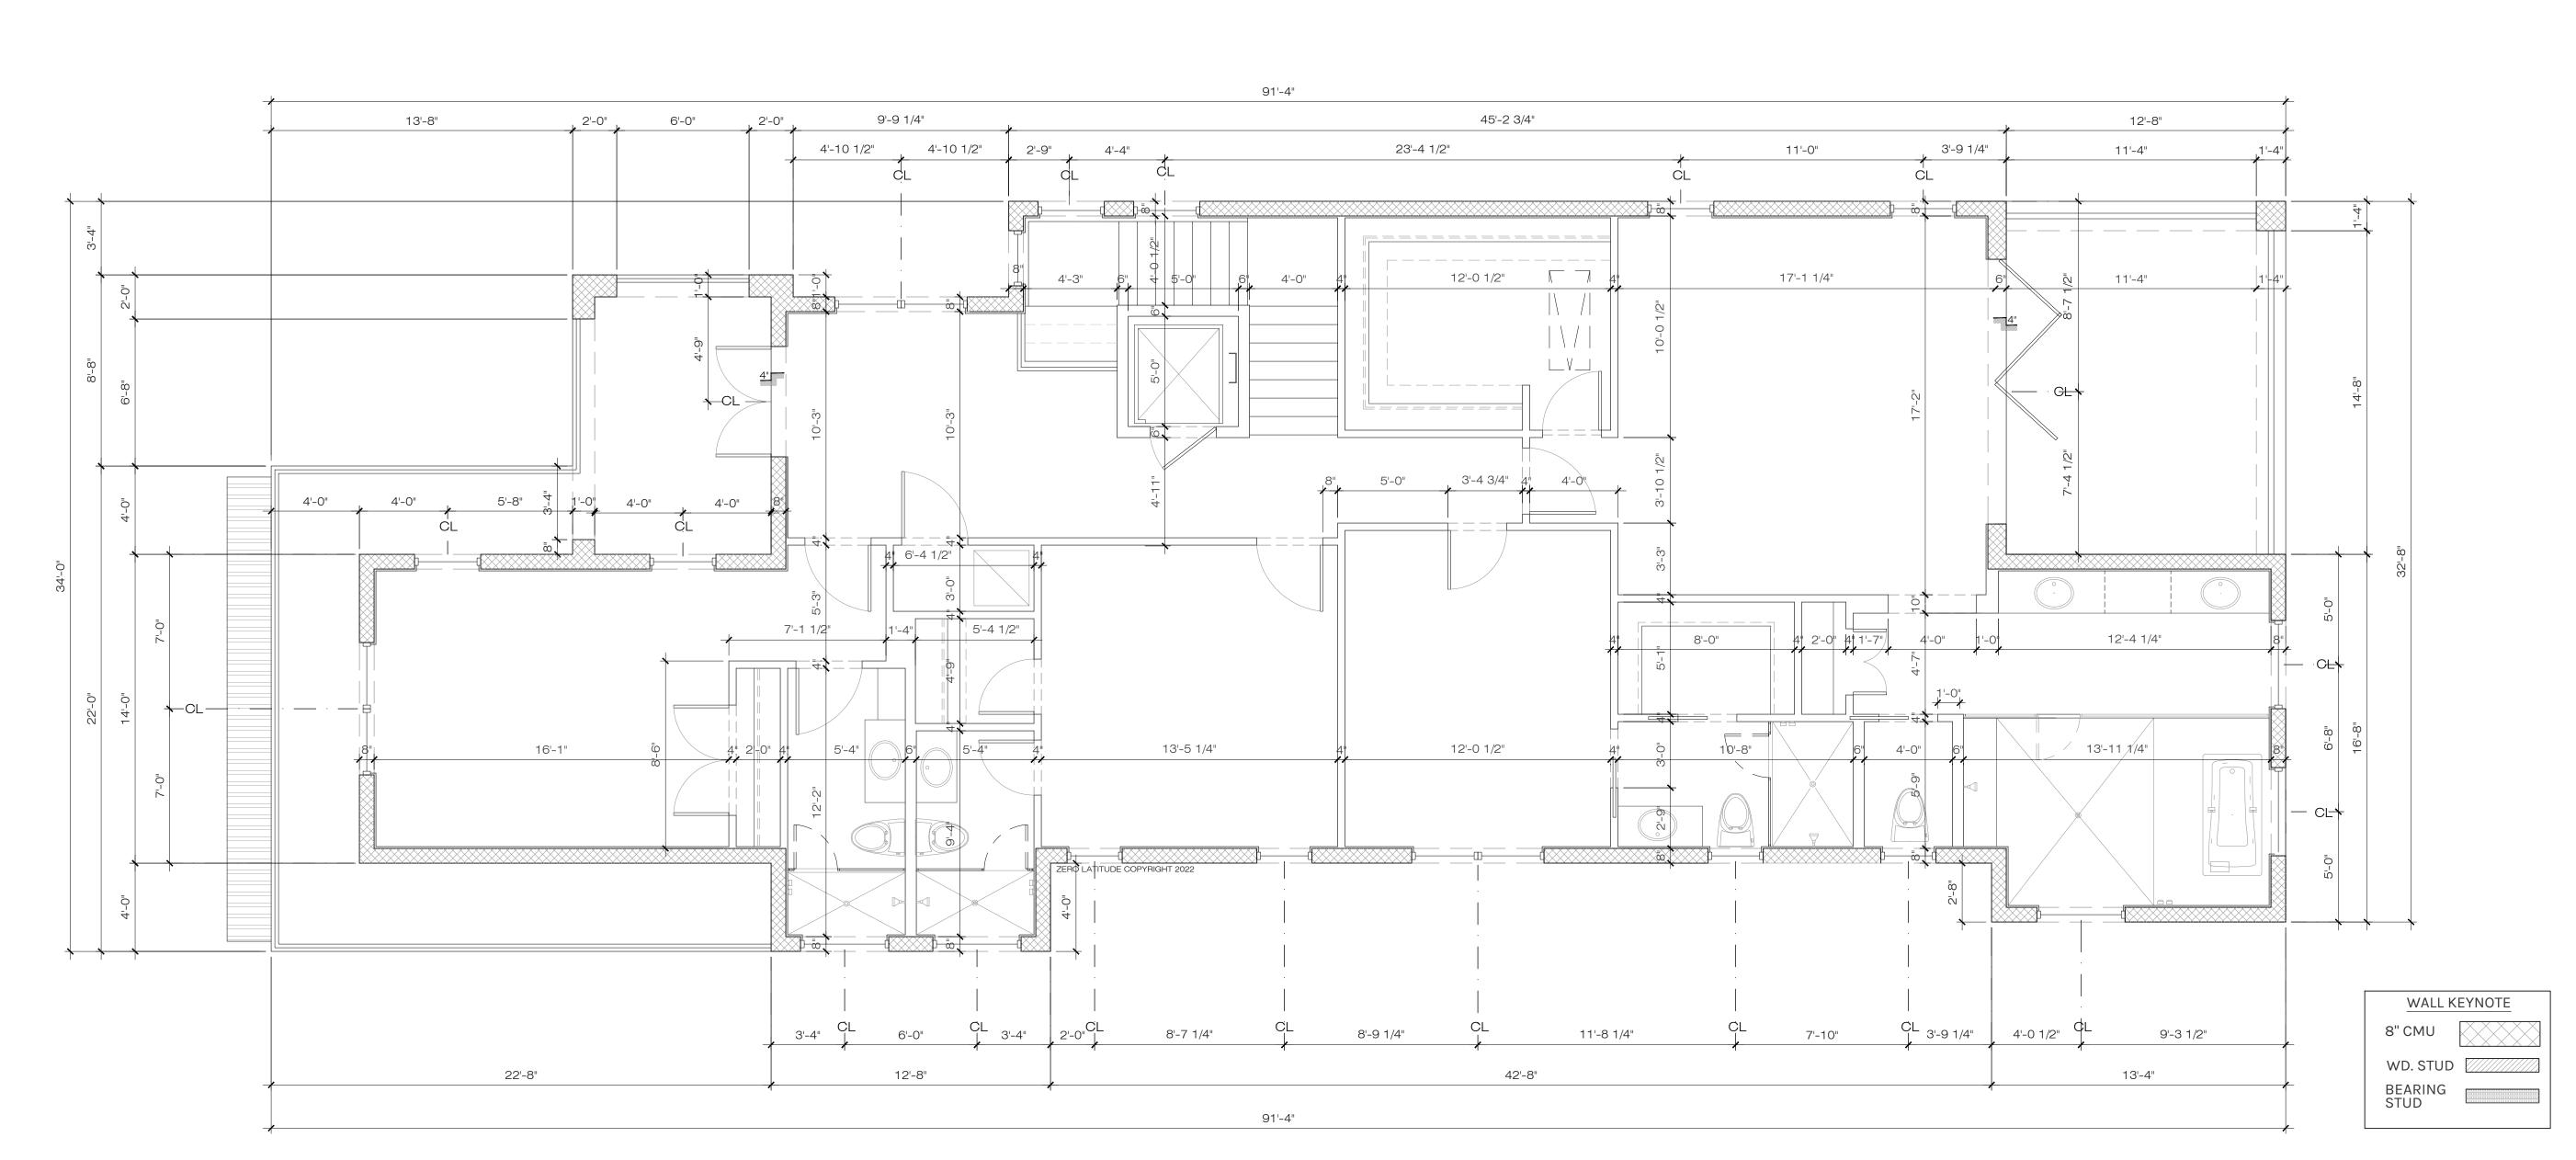

DIM 2ND FLOOR PLAN A6 SCALE: 1/4" = 1'-0"





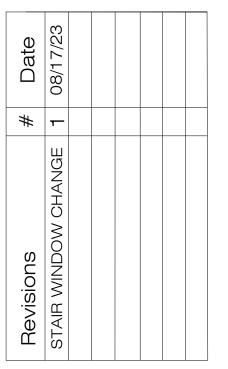


MES ACH,

DANIEL SOUTER, P.E. P.E.# 63901 P.O. BOX 547774 ORLANDO, FL 32854 PHONE: (407) 421-4866



02-20-23 Project # Drawn by Checked by JH/DS Reviewed by Interior Design YES & Owner



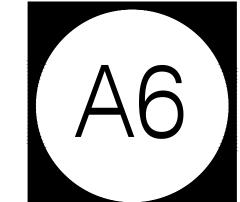


WAVERLY - WINDOW SCHEDULE										
UNIT #.	UNIT SIZE	ТҮРЕ	E TOP OF WINDOW LOCATION		EGRESS	REMARKS				
SECOND	FLOOR									
2A	(2)36" x 72"	М	8' -0" A.F.F.	BEDROOM 4		FIXED - FIXED				
2B	48" x 24"	E	8' -0" A.F.F.	BATH 4		FIXED - TEMP				
2C	48" x 24"	Е	8' -0" A.F.F.	BATH 3		FIXED - TEMP				
2D	30" x 72"	F	8' -0" A.F.F.	BEDROOM 3	YES	CASEMENT				
2E	30" x 72"	F	8' -0" A.F.F.	BEDROOM 3	YES	CASEMENT				
2F	(2)36" x 72"	G	8' -0" A.F.F.	BEDROOM 2	YES	CASEMENT - MULLED UNIT				
2G	30" x 48"	Н	8' -0" A.F.F.	BATH 2		FIXED - TEMP				
2H	30" x 48"	Н	8' -0" A.F.F.	MASTER BATH		FIXED - TEMP				
2J	48" x 24"	Е	8' -0" A.F.F.	MASTER BATH		FIXED - TEMP				
2K	48" x 60"	J	8' -0" A.F.F.	MASTER BATH		FIXED - TEMP				
2L	48" x 60"	J	8' -0" A.F.F.	MASTER BATH		FIXED - TEMP				
2M	36" x 36"	К	8' -0" A.F.F.	MASTER BEDROOM		FIXED				
2N	36" x 36"	К	8' -0" A.F.F.	MASTER BEDROOM		FIXED				
2P	(2)36" x 72"	М	8' -0" A.F.F.	SMALL LLOUNGE		FIXED - MULLED UNIT				
2Q	36" x 72"	L	8' -0" A.F.F.	BEDROOM 4	YES	CASEMENT				
2R	36" x 72"	L	8' -0" A.F.F.	BEDROOM 4	YES	CASEMENT				


8 4 8 8 8 8 8 8 8 8 8 8 8 8 8 8 8 8 8 8	120	120	36" x 84" FIXED	36" x 83" FIXED TEMP 36" x 108" FIXED TEMP	72 36 36 36"x 84" FIXED TEMP 36"x 84" FIXED TEMP		96		30 30"x 48" FIXED TEMP 96 96	48" x 60" FIXED TEMP	96	J. J	72 36 36 36"x72" 36"x72" FIXED TEMP TEMP
TYPE A TYPE B TYPE C TYPE D TYPE B TYPE G TYPE H TYPE J TYPE K TYPE L TYPE M TYPE A FIXED FIXED FIXED CASEMENT DOUBLE CASEMENT FIXED FIXED FIXED CASEMENT FIXED (DOUBLE) FIXED W/ TRANSOM SEMENT EGRESS - MULLED TEMPERED T	Ψ	TYPE A FIXED W/ TRANSOM	TYPE B FIXED	TYPE C FIXED 3 WINDOW PATTERN	TYPE D FIXED (DOUBLE) MULLED UNIT	TYPE E FIXED - TRANSOM TEMPERED	TYPE F CASEMENT EGRESS	TYPE G DOUBLE CASEMENT EGRESS - MULLED NO MULLIONS	TYPE H FIXED TEMPERED	TYPE J FIXED TEMPERED	TYPE K FIXED TEMPERED	TYPE L CASEMENT EGRESS	TYPE M FIXED (DOUBLE) MULLED UNIT

WINDOW ELEVATIONS

- PLANS ONLY SHOW ALPHABETICAL NOTATION. SEE WINDOW SCHEDULE FOR FULL
 - 2. ALL WINDOWS THAT HAVE A SILL LOWER THAN 24 INCHES A.F.F. WILL HAVE TEMPERED
 - (MIAMI-DADE COUNTY) AND LOCAL ORDINANCES FOR HURRICANE REQUIREMENTS.

				WAVERLY -	DOOR SCHED	ULE		
UNIT #.	WIDTH	HEIGHT	THKS.	MATERIALS		DOOR	LOCATION	NOTES
				DOOR	FRAME	TYPE		
SECOND	FLOOR							
14	3'-0"	8'-0"	1 1/2"	SC	WOOD	С	ELEVATOR	PER ELEVATOR MANUF. SPECS.
15	(2)2'-6"	8'-0" 1	1 1/2"	WOOD/GLASS	WOOD	F	SMALL LOUNGE - BALCONY	EXTERIOR FRENCH DOORS
16	3'-0"	8'-0" 1	1 1/2"	SC	WOOD	С	BEDROOM 4	
17	3'-0"	8'-0" 1	1 1/2"	SC	WOOD	С	BATH 4 - ENTRY	FRENCH DOOR
18	(2)2'-6"	8'-0" 1	1 1/2"	SC	WOOD	E	BEDROOM 4 - CLOSET	DOUBLE DOOR
19	3'-0"	8'-0" 1	1 1/2"	SC	WOOD	С	MECAHNICAL	
20	3'-0"	8'-0"	1 1/2"	SC	WOOD	С	BEDROOM 3 - ENTRY	
21	2'-8"	8'-0" 1	1 1/2"	SC	WOOD	С	BEDROOM 3 - W.I.C.	
22	2'-8"	8'-0" 1	1 1/2"	SC	WOOD	С	BATH 3 - ENTRY	
23	2'-8"	8'-0"	1 1/2"	SC	WOOD	С	BEDROOM 2 - ENTRY	
24	2'-8"	8'-0"	1 1/2"	SC	WOOD	С	BATH 2 - ENTRY	
25	2'-8"	8'-0" 1	1 1/2"	SC	WOOD	D	BATH 2 - W.I.C.	POCKET DOOR
26	2'-8"	8'-0" 1	1 1/2"	SC	WOOD	С	MASTER BEDROOM - ENTRY	
27	2'-8"	8'-0" 1	1 1/2"	SC	WOOD	С	MASTER BEDROOM - W.I.C.	
28	2'-8"	8'-0" 1	1 1/2"	SC	WOOD	С	MASTER BEDROOM - LINEN	
29	2'-8"	8'-0"	1 1/2"	SC	WOOD	D	MASTER BATH - ENTRY	POCKET DOOR
30	(4)4'-0"	8'-0"	1 1/2"	ALUMINUM/GLASS	ALUMINIUM	G	GATHERING - BALCONY	FOLDING GLASS DOOR

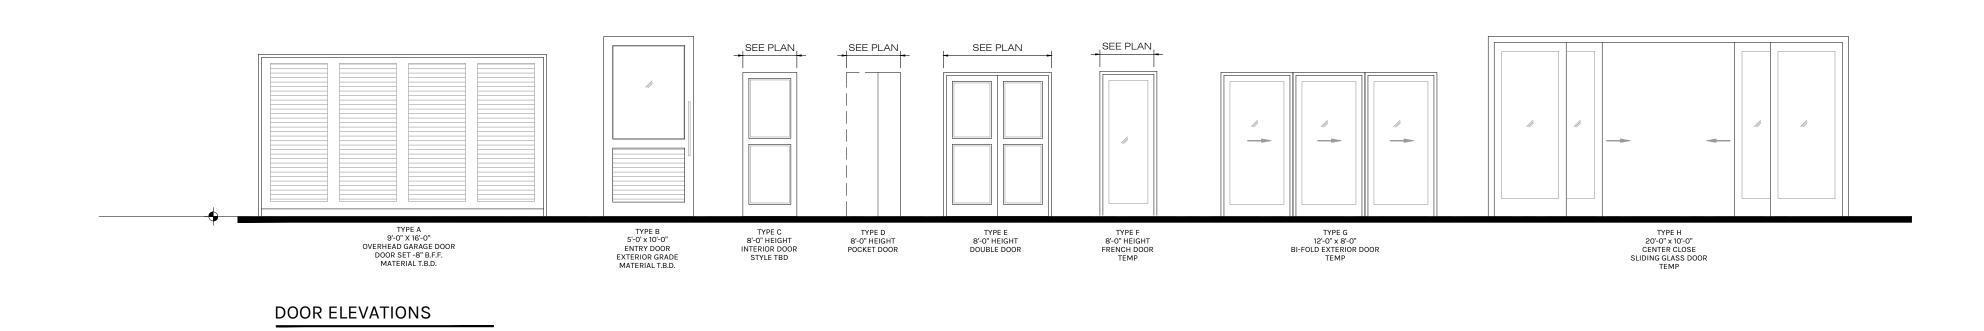

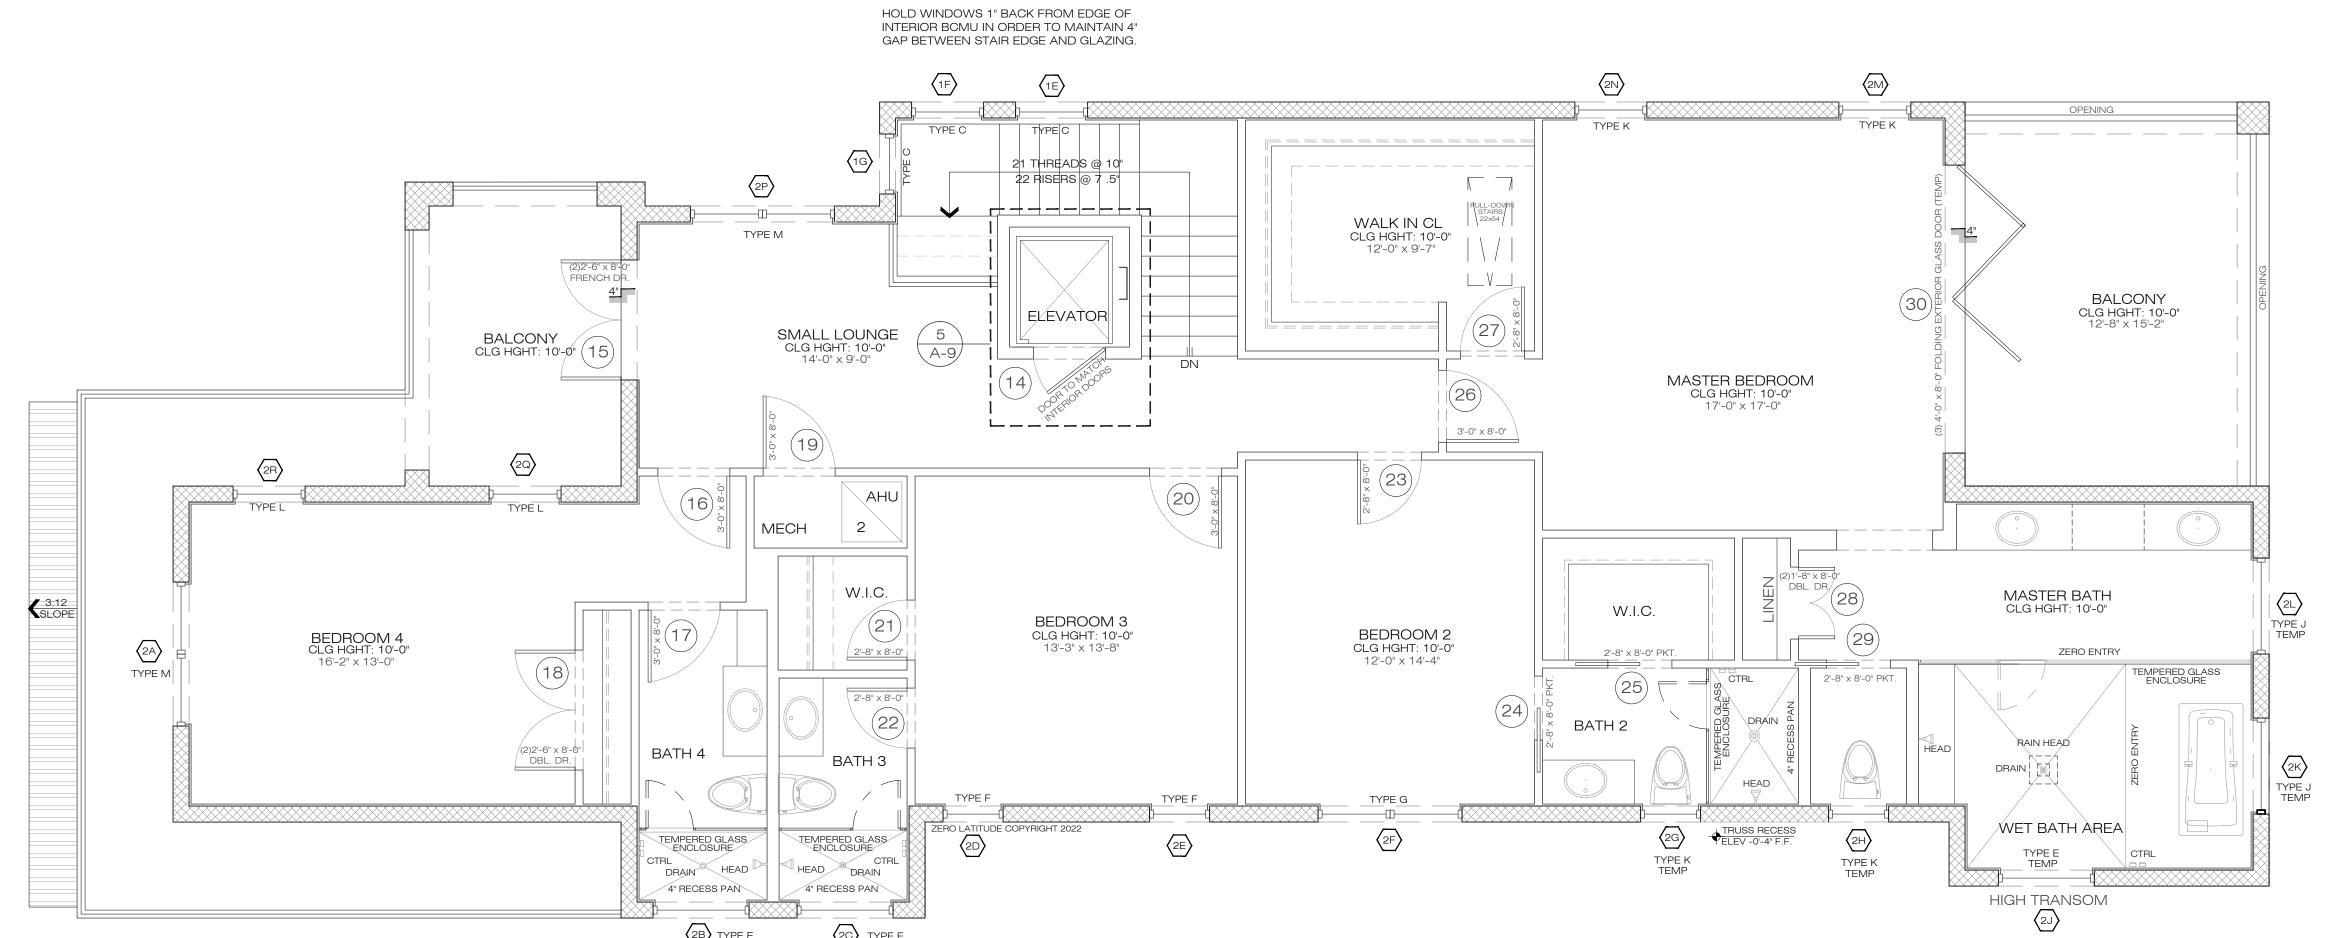

COMPONENTS AND WINDOW AND WIND PRESSURE Vasd VALUES (EXP C. AREA 20 S.F. 50 S.F. 100 S.F. 10 S.F. 20 S.F. 50 S.F.

FLOOR PLAN NOTES

100 S.F.


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- 2. WALL BETWEEN GARAGE AND LIVING AREA OF HOUSE TO HAVE 1/2" FINISHED DRYWALL MINIMUM IF WALL IS NOT SOLID BLOCK.
- 3. GARAGE CEILING TO BE 1/2" FINISHED DRYWALL MINIMUM AND 5/8" TYPE X DRYWALL IF THERE IS LIVING SPACE ABOVE THE GARAGE.
- 4. ENCLOSED SPACE UNDER STAIRS THAT IS ACCESSED BY A DOOR OR ACCESS PANEL SHALL HAVE WALLS, UNDER-STAIR SURFACE AND ANY SOFFITS PROTECTED ON THE ENCLOSED SIDE WITH 1/2" INCH GYPSUM BOARD. (FBCR-R302.7)
- 5. ATTIC ACCESS, MINIMUM 30"x22" OPENING. PROVIDE (1) OUTLET, SWITCH AND LIGHT IN ATTIC AT PULL-DOWN STAIRS.
- 6. PULL DOWN ATTIC ACCESS LADDER, MINIMUM 54"x22" OPENING.
- 7. AT SECOND FLOOR BALCONIES: FLOORING TO BE TILES OVER PLI-DEK WATERPROOF SYSTEM. CONTRACTOR OPTION WITH OWNER APPROVAL TO USE DUROCK OVER 60 MIL. WATERPROOF MEMBRANE OVER 30# FELT OVER 3/4" PLYWOOD W/ FLASHING (TYP.)
- 8. CONTRACTOR AND/OR STAIR MANUFACTURER TO VERIFY ALL STAIR HEIGHTS, RISER HEIGHTS AND TREAD DEPTHS TO ENSURE THE CORRECT DIMENSIONS WERE PROVIDED.
- 9. CONTRACTOR TO VERIFY ALL WINDOW AND DOOR SIZES PRIOR TO ORDERING TO ENSURE ELEVATIONS PORTRAY THE CORRECT WINDOW AND DOOR HEIGHTS.
- 10. ALL RAILINGS ABOVE 24" A.F.F. SHALL BE 42 INCH HIGH GUARDRAILS UNLESS OTHERWISE SPECIFIED.
- 11. ALL SHOWERS TO BE 4 INCH RECESSED, WHERE APPLICABLE, IN FIRST FLOOR SLAB AND IN TRUSSES AT ALL OTHER FLOORS.
- 12. ALL TRAY CEILINGS TO BE 8 INCHES DEEP UNLESS OTHERWISE NOTED ON DRAWINGS.

EGRESS WINDOWS MEAN OF ESCAPE NOTE (EGRESS):


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EVERY CLOSET DOOR LATCH SHALL BE SUCH THAT CHILDREN CAN OPEN THE DOOR FROM INSIDE THE CLOSET, EVERY BATHROOM DOOR SHALL BE DESIGNED TO ALLOW OPENING FROM THE OUTSIDE ENSURING AN EMERGENCY WHEN LOCKED.

WALL K	EYNOTE
8" CMU	
WD. STUD	
BEARING STUD	

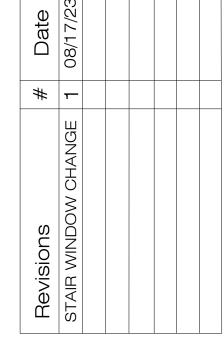

л Signal I



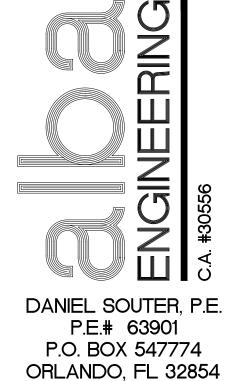

PHONE: (407) 421-4866


Date	02-20-23
Project #	22-026
Drawn by	FVC
Checked by	JH/DS
Reviewed by Interior Design	YES







A7 SCALE: 1/4" = 1'-0"

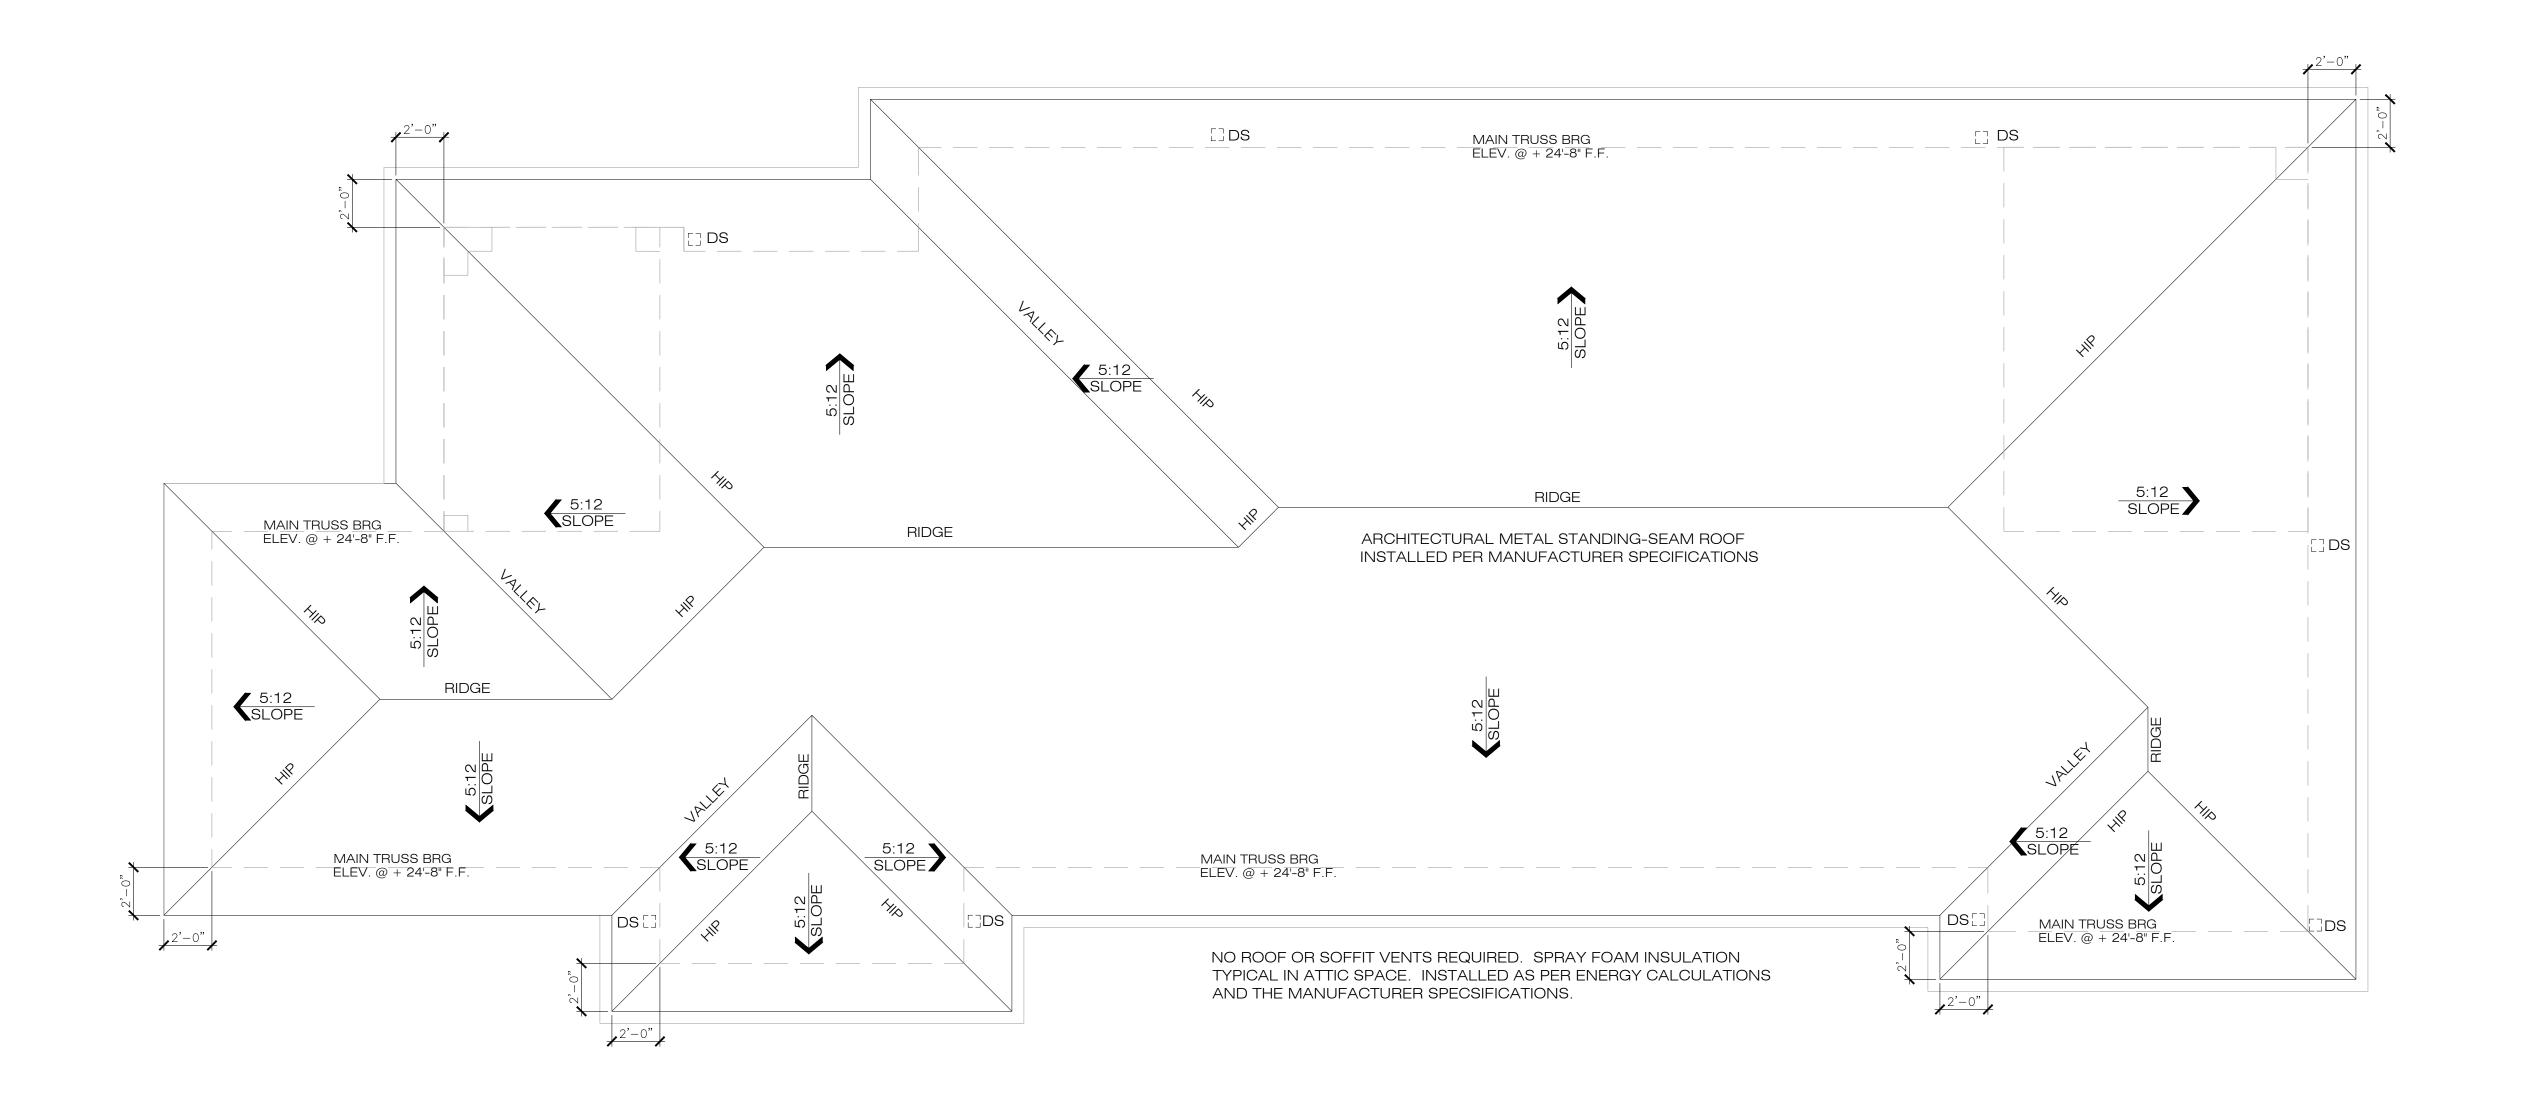

1 ROOF PLAN
A8 SCALE: 1/4" = 1'-0"

ROOF NOTES

GENERAL NOTES:

COORDINATE ALL ROOF NOTES WITH ELEVATION AND FLOOR PLANS NOTES.
 REFER TO ROOFING SPECIFICATIONS 202 7TH EDITION FBC CHAPTER 9 - ROOF ASSEMBLIES FOR FURTHER INFORMATION, TYP.
 REFER TO CIVIL DRAWINGS FOR STORM DRAIN LOCATION. COORDINATE IN FIELD.
 PROVIDE ROOF CRICKETING AROUND ROOF ACCESSORIES AND PENETRATIONS.


4. PROVIDE ROOF CRICKETING AROUND ROOF ACCESSORIES AND PENETRATIONS.
5. GENERAL CONTRACTOR TO COORDINATE LOCATIONS OF DOWNSPOUT AND/OR SCUPPERS IF APPLICABLE TO BUILD.

LOW-SLOPE ROOF DRAINAGE

ALL LOW ROOFS SURROUNDED BY PARAPET WALLS TO HAVE DRAINS PIPED TO EXTERIOR OF RESIDENCE, WITH SEPARATE OVERFLOW DRAINS OR SCUPPERS LOCATED 2" ABOVE PRIMARY DRAIN ELEVATION TO COMPLY WITH FBC-R304 AND FBC-PLUMBING 1105 & 1106

FLASHING NOTE:

FLASHING SHALL BE INSTALLED AT ALL WALL AND ROOF INTERSECTIONS, AT ALL CHANGE IN ROOF SLOPE OR DIRECTION AND AROUND ALL ROOF OPENINGS PER FBC-R903.

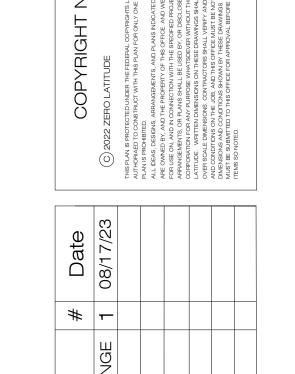

Revisions # Data

A NEW HOME BY ZERO LATITUDE HOMES

WAVERLY SPEC HOME

LOT 5 - SOUTH HARBOR DR., VERO BEACH, F


MERIDIAN CUSTOM HOMES


DANIEL SOUTER, P.E.
P.E.# 63901
P.O. BOX 547774
ORLANDO, FL 32854
PHONE: (407) 421-4866




Date	02-20-23
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Reviewed by Interior Design & Owner	YES 08



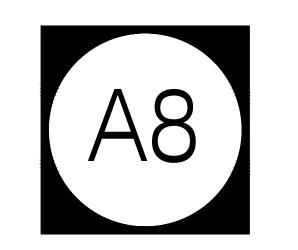


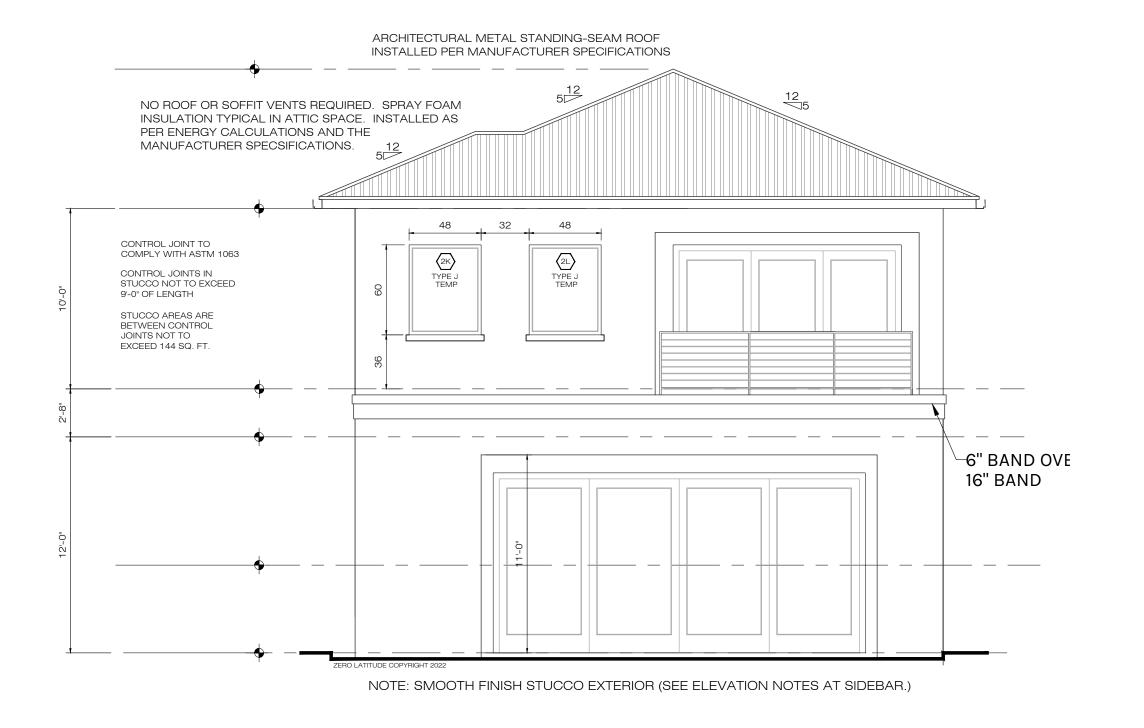


2 REAR ELEVATION A9 SCALE: 3/16" = 1'-0"

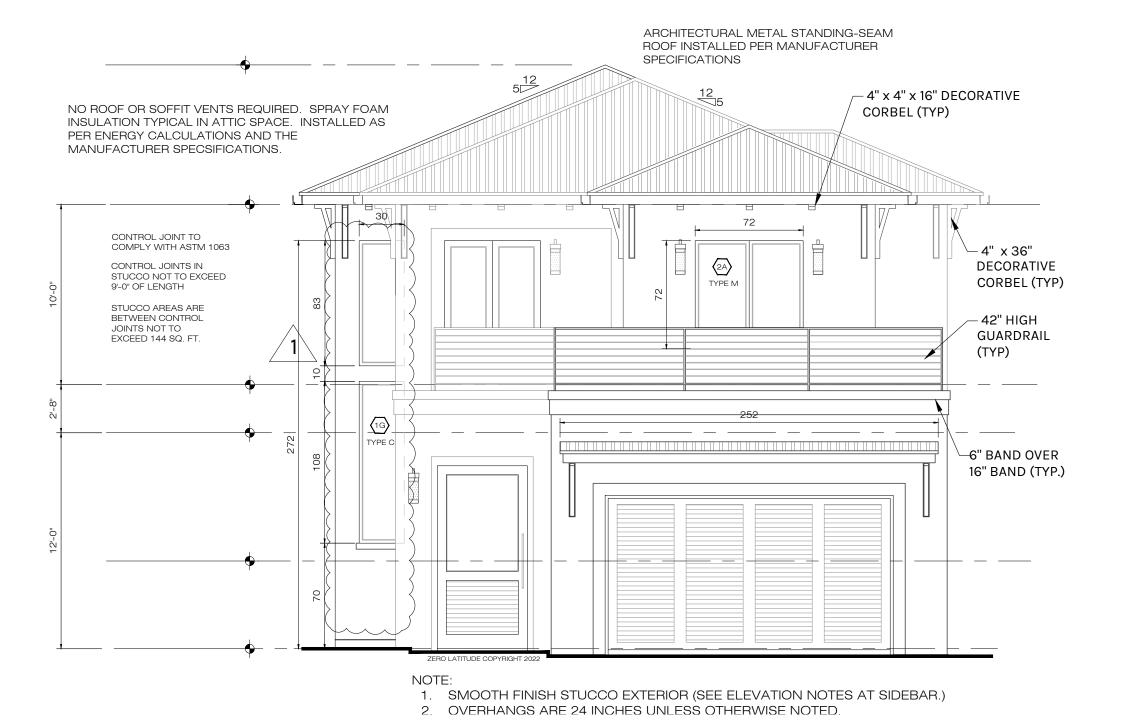



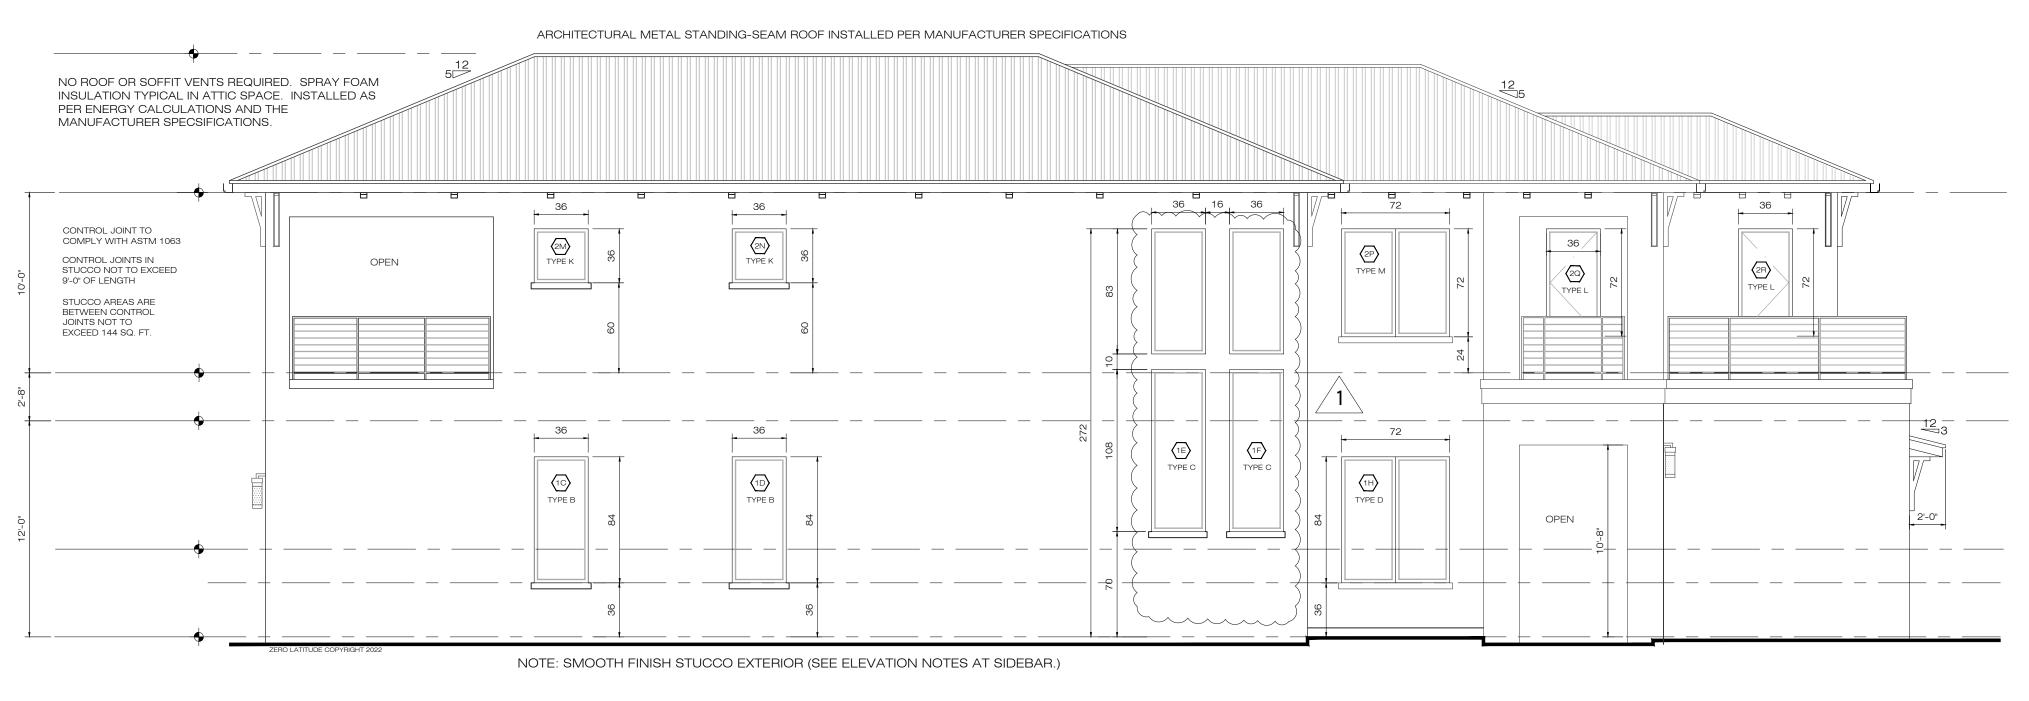

3 LEFT SIDE ELEVATION A9 SCALE: 3/16" = 1'-0"

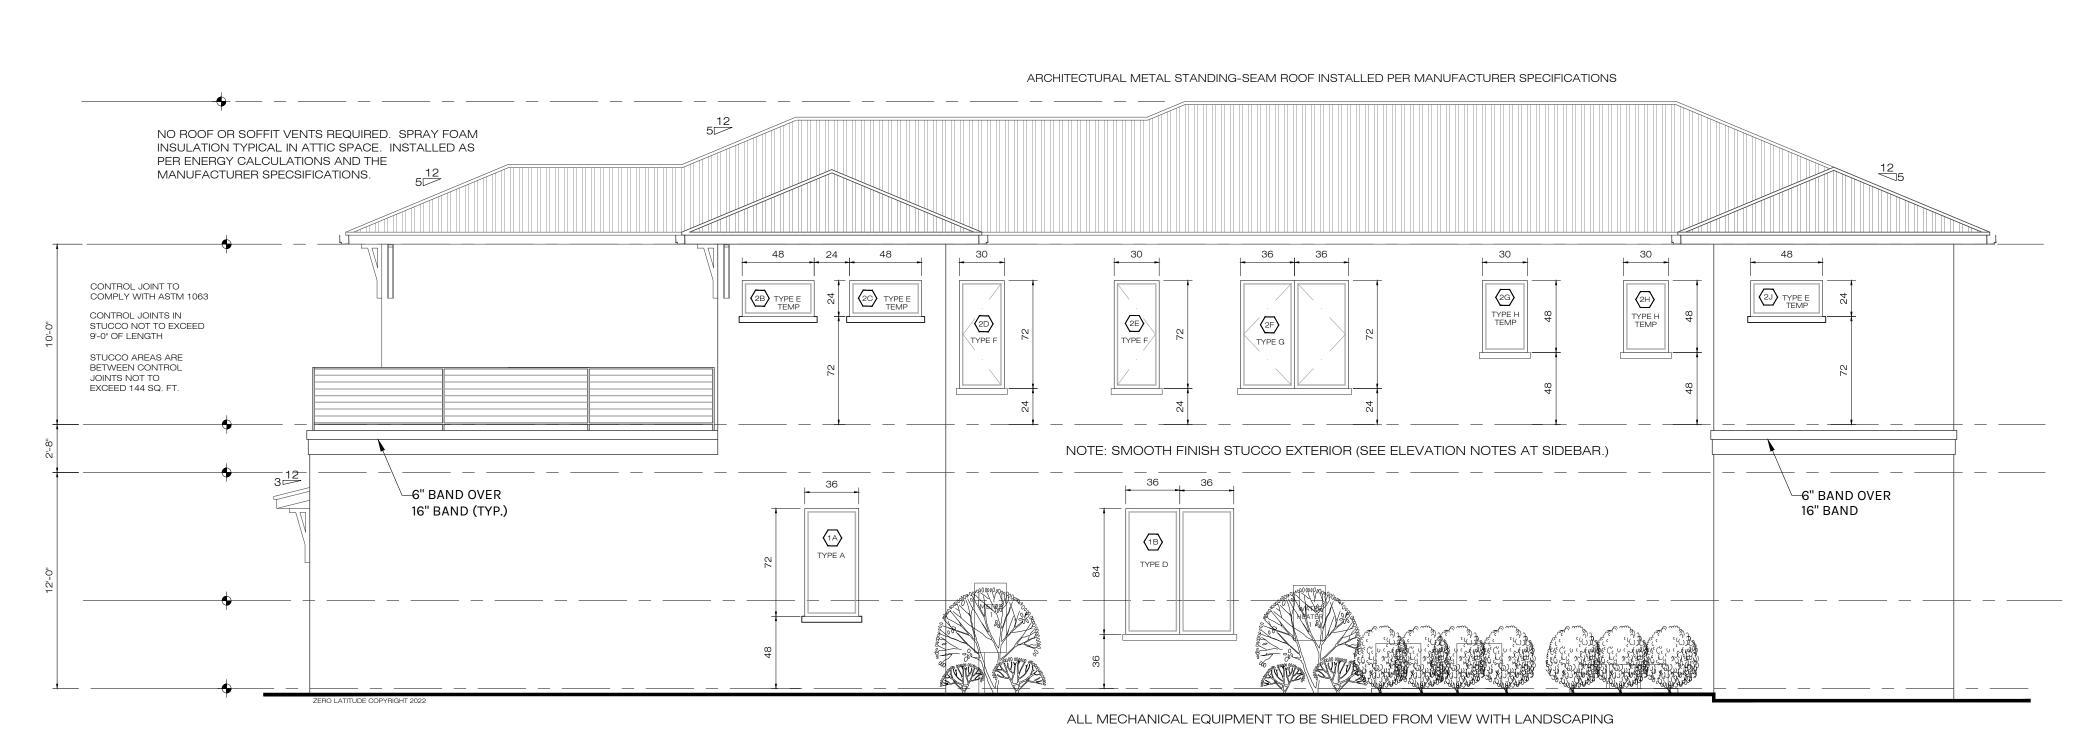

A9 SCALE: 3/16" = 1'-0"

GUARD RAILS

GUARD RAILS SHALL BE PROVIDED FOR THOSE PORTIONS OF OPEN-SIDED WALKING SURFACES, INCLUDING STAIRS, RAMPS AND LANDINGS, THAT ARE LOCATED MORE THAN 30" MEASURED VERTICALLY TO THE FLOOR OR GRADE BELOW AT ANY POINT WITHIN 24 INCHES HORIZONTALLY TO THE EDGE OF THE OPEN SIDE. INSECT SCREENING SHALL NOT BE CONSIDERED AS A GUARD. GUARDS SHALL NOT BE LESS THAN 36" IN HEIGHT. LARGEST GAPS BETWEEN HANDRAIL MEMBERS, PICKETS AND BASE SHALL NOT EXCEED 4". HANDRAIL/GUARDRAIL LIVE LOADS, GUARDS AND HANDRAILS (HIGHER OF 200LB PT LOAD OR 50PLF). GUARD/PICKET INFILL COMPONENTS, 50PSF OVER A 1 SQ. FT. AREA.

STUCCO APPLICATION

ELEVATION NOTES

1. TYPICAL 5/8" SMOOTH STUCCO FINISH @ C.M.U.

2. TYPICAL 7/8" SMOOTH STUCCO FINISH @ FRAME

3. ARCHITECTURAL METAL STANDING-SEAM ROOF

5. FRONT ELEVATION WINDOW SILLS TO BE 4" x 6"

6. 6" WOOD SIDING WHERE INDICATED, STYLE AND

7. CONTROL JOINTS ON EXTERIOR STUCCO WALLS

OVER WOOD FRAME TO BE INSTALLED PER ASTM

NOTE: CONTRACTOR TO VERIFY ALL ELEVATIONS PRIOR

DESIGNER/ENGINEER WITH ANY CHANGES OR

ALL EGRESS WINDOWS TO COMPLY W/F.B.C. R 310.1. AN OUTSIDE WINDOW OR DOOR OPERABLE FROM THE INSIDE WITHOUT THE USE OF TOOLS AND PROVIDING A CLEAR

OPENING OF NOT LESS THAN 20" WIDE X 24" HIGH AND 5.7

SF IN AREA. THE BOTTOM OF THE OPENING SHALL NOT BE

MORE THAN 44" OF THE FLOOR, THE MODE OF OPERATION MUST NOT REQUIRE THE USE OF A KEY, TOOL OR SPECIAL KNOWLEDGE OR EFFORT TO MAKE AVAILABLE THE REQUIRED

MECHANISM SHALL BE PLACED HIGHER THAN 54" ABOVE THE

EVERY CLOSET DOOR LATCH SHALL BE SUCH THAT CHILDREN CAN OPEN THE DOOR FROM INSIDE THE CLOSET, EVERY BATHROOM DOOR SHALL BE DESIGNED TO ALLOW OPENING FROM THE OUTSIDE ENSURING AN EMERGENCY WHEN

CLEAR OPENING, AND NO PART OF THE OPERATION

STUCCO AND/OR WHERE ALSO INDICATED.

COLOR PER CONTRACTOR AND OWNER.

TO CONSTRUCTION AND CONTACT

4. NO ROOF VENTS REQUIRED, SPRAY FOAM

INSULATION TO BE USED PER ENERGY

CALCULATIONS.

EGRESS

FINISHED FLOOR.

LOCKED.

MEAN OF ESCAPE NOTE (EGRESS):

INSTALLED PER MANUFACTURER SPECIFICATION.

 TYPICAL 5/8" SMOOTH STUCCO FINISH @ C.M.U. WALLS


• TYPICAL 7/8" SMOOTH STUCCO FINISH @ FRAME WALLS OVER EXPANDED METAL OR FIBERGLASS LATH, OVER #15 BUILDING PAPER, OVER TYVEK HOMEWRAP (OR EQUAL).

CONTROL JOINTS

• CONTROL JOINTS IN STUCCO SHALL NOT EXCEED 9'-0" IN LENGTH.

 STUCCO AREAS ARE BETWEEN CONTROLS JOINTS SHALL NOT EXCEED 144 SQ. FT.

HOR HP1 S 15 - 60 x 60 950#, RH RAIL, IN-LINE OPENING, SCISSOR GATE, 15 SQ. FT. LUXURY LIFT TRACTION (LLT)

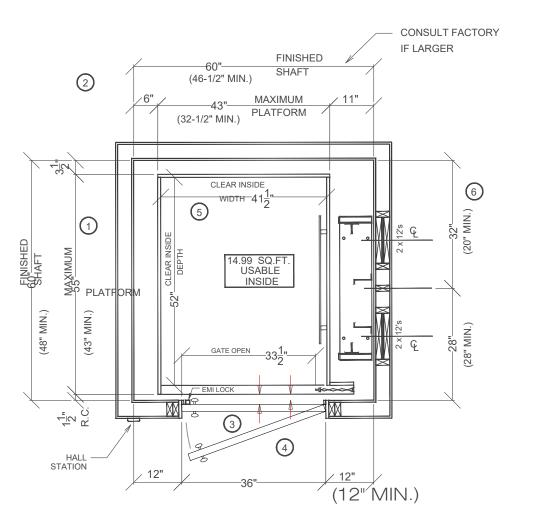

STANDARD HOISTWAY PLAN

NOTE: ALL DIMENSIONS ARE APPROXIMATE

OVERSIZE CAB OPTION ASSUMED

THE INFORMATION CONTAINED HEREIN IS SOLELY OWNED BY RESIDENTIAL ELEVATORS ANY REPRODUCTION IN PART OR AS A WHOLE WITHOUT WRITTEN PERMISSION FROM RESIDENTIAL ELEVATORS IS STRICTLY PROHIBITED.

NOTES:

IF PLATFORM SIZE IS REDUCED, THEN THE BLOCKING IS TO BE POSITIONED SUCH THAT IT IS CENTERED ON THE PLATFORM.

(PLATFORM DEPTH / 2) + 2" = CENTERLINE OF RAIL BLOCKING OFF OF INSIDE FRONT WALL. (MIN. 28" DIMENSION)

2 CAR TO WALL (CTW) DIMENSION IS 3-1/2" MIN.

(3) HOISTWAY DOORS & FRAMES MUST BE INSTALLED TO COMPLY WITH THE AUTHORITY HAVING JURISDICTION REQUIREMENTS. THESE DIMENSIONS VARY. CONSULT YOUR RESIDENTIAL ELEVATORS SALES REPRESENTATIVE FOR DETAILS PRIOR TO CONSTRUCTION.

4 HOISTWAY DOORS TO BE SOLID CORE (BY OTHERS.)

5 CLEAR CAB DIMENSIONS BASED ON A 3/4" FLAT WALL

(6) CLEAR CAB DIMENSIONS BASED ON A 3/4" FLAT WALL

All Traction Elevators require an access panel for emergency lowering.
Access panel size and location must be discussed with your
Residential Elevators Sales Representative prior to construction.



5 ELEVATOR DETAIL

A9 | SCALE 1/2" = 1'

SEE MANUFACTURER'S SPECIFICATIONS AND INSTALLATIONS INSTRUCTIONS PRIOR TO FRAMING IN ORDER TO ENSURE EXACT PLACEMENT OF ELEVATOR WALLS & FRAMING.

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AND IS PROJECTED UNDER THE FEDERAL COPPRIGHTS LAWS. THE ORIGINAL PURCHASS
THORAGED TO CONSTRUCT WITH THIS PLAN POR ONLY ONE TIME, REUSE OR CHANGE OF TAIN IS PROJECTED.

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AND CANDETTONS ON THE JOBS BANAL WAS PRESEDED BROWN.

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MDOW CHANGE 1 08/17/23

THIS PLAN IS POUNDED IN THE PLAN IS POUNDED

STAIR WINDOW CHANG STAIR WINDOW CHANG

A NEW HOME BY ZERO LATITUDE HOME

WAVERLY SPEC HOM

LOT 5 - SOUTH HARBOR DR., VERO BEAC

DANIEL SOUTER, P.E.
P.E.# 63901
P.O. BOX 547774
ORLANDO, FL 32854




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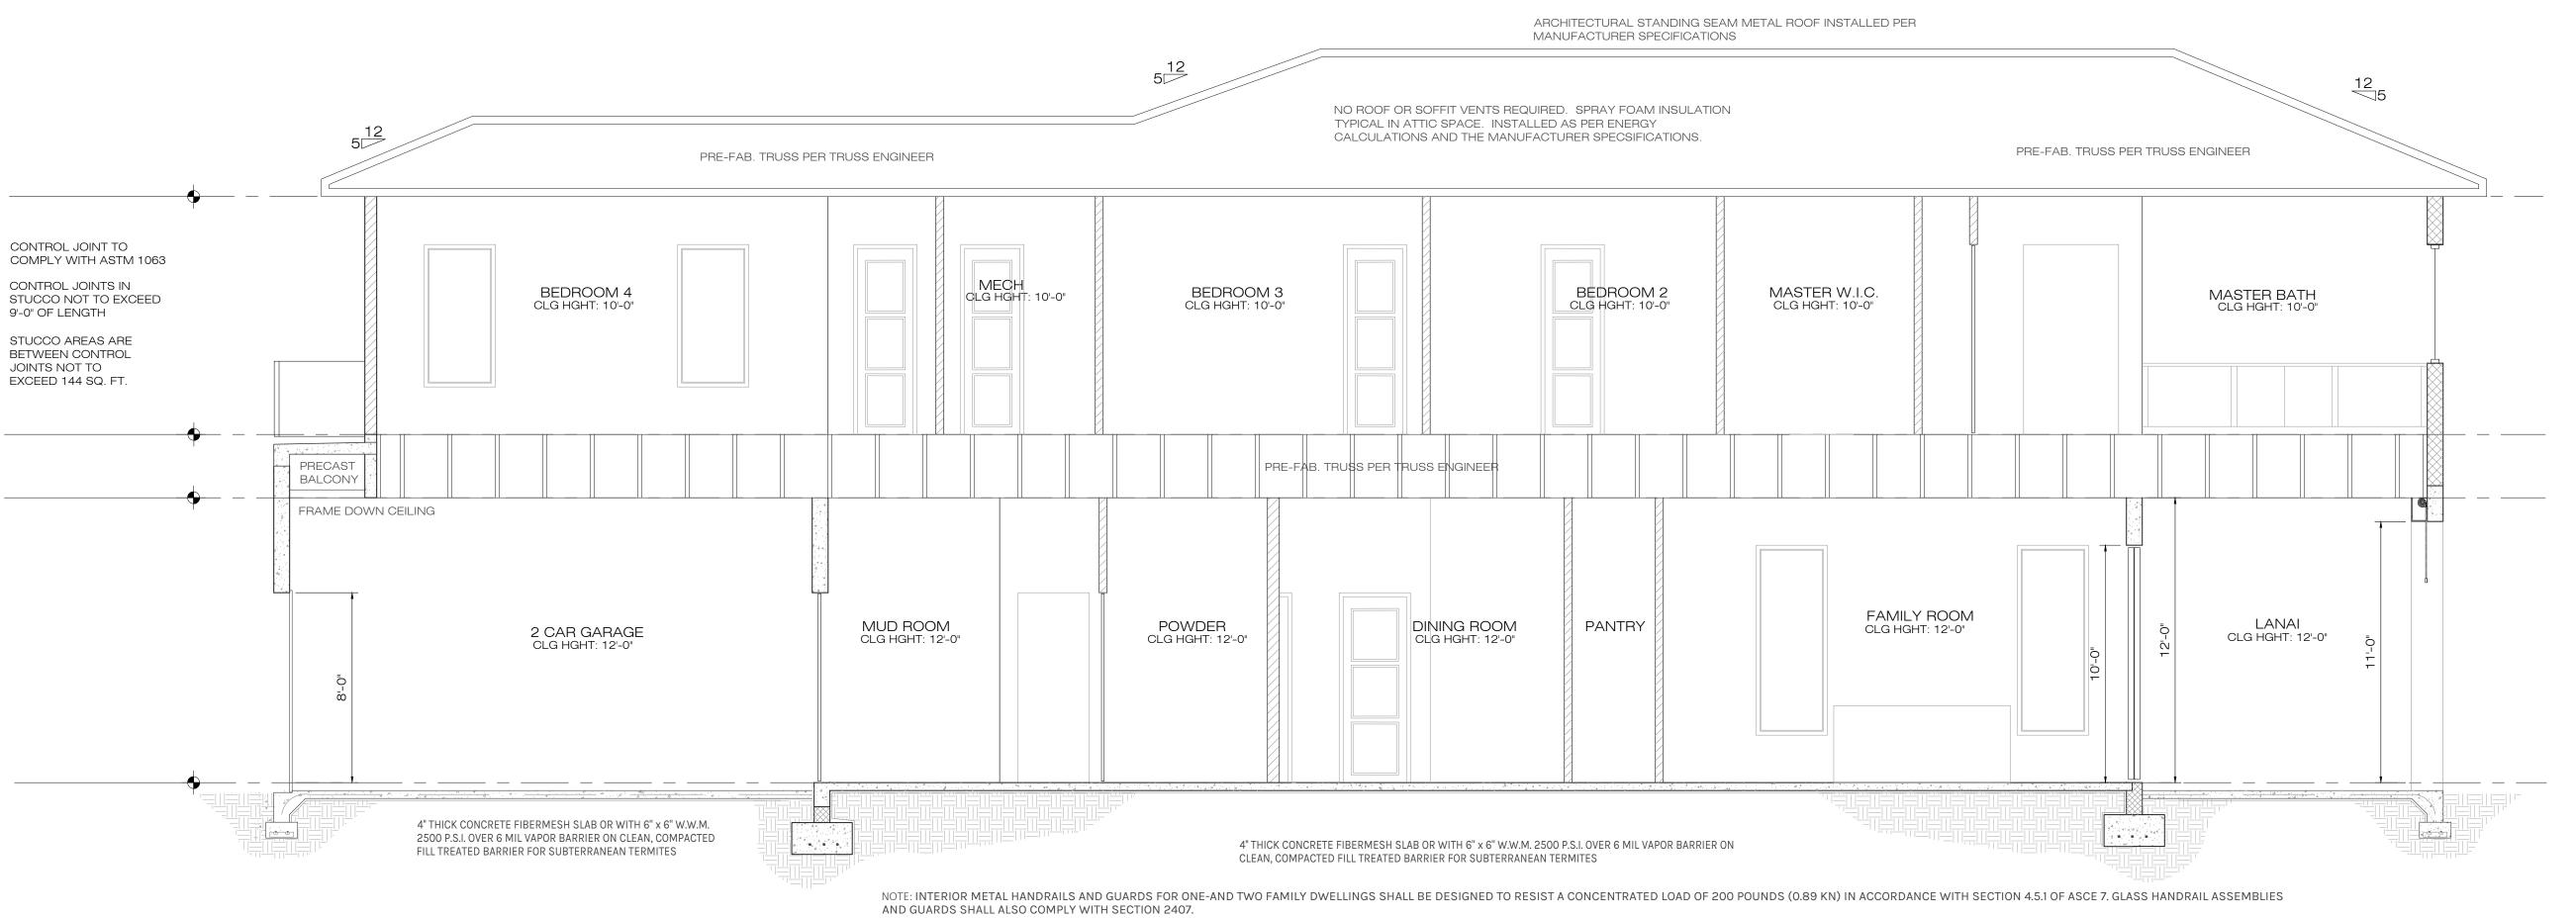
Date 02-20-23
Project # 22-026
Drawn by FVC
Checked by JH/DS
Reviewed by Interior Design YES

& Owner



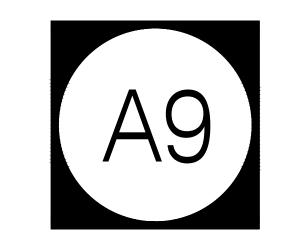

PERMIT SET FOR CONSTRUCTION




NOTE: ALL THE WINDOW OPENINGS; DELAY A MINIMUM 2" FROM FACE OF EXTERIOR WALL (CMU & WOOD FRAME)

R-318 TERMITE PROTECTION SHALL BE PROVIDED BY REGISTERED TERMTICIDES, INCLUDING SOIL APPLIED PESTICIDES, BAITING SYSTEMS, AND PESTICIDES INCLUDING SOIL APPLIED PESTICIDES, BAITING SYSTEMS, AND PESTICIDES APPLIED TO WOOD, OR OTHER APPROVED METHODS OF TERMITE PROTECTION LABELED FOR USE AS A PREVENTATIVE TREATMENT TO NEW CONSTRUCTION (SEE SECTION 202, REGISTERED TERMITICIDE). UPON COMPLETION OF THE APPLICATION OF THE TERMITE PROTECTION TREATMENT, A CERTIFICATE OF COMPLIANCE SHALL BE ISSUED TO THE BUILDING DEPARTMENT BY THE LICENSED PEST CONTROL COMPANY THAT CONTAINS THE FOLLOWING STATEMENT: "THE BUILDING HAS RECEIVED A COMPLETE

TREATMENT FOR THE PREVENTION OF SUBTERRANEAN TERMITES. TREATMENT IS IN ACCORDANCE WITH RULES AND LAWS ESTABLISHED BY FLORIDA DEPARTMENT OF AGRICULTURE AND CONSUMER SERVICES."

1 BUILDING ELEVATION A10 SCALE: 1/4" = 1'-0"

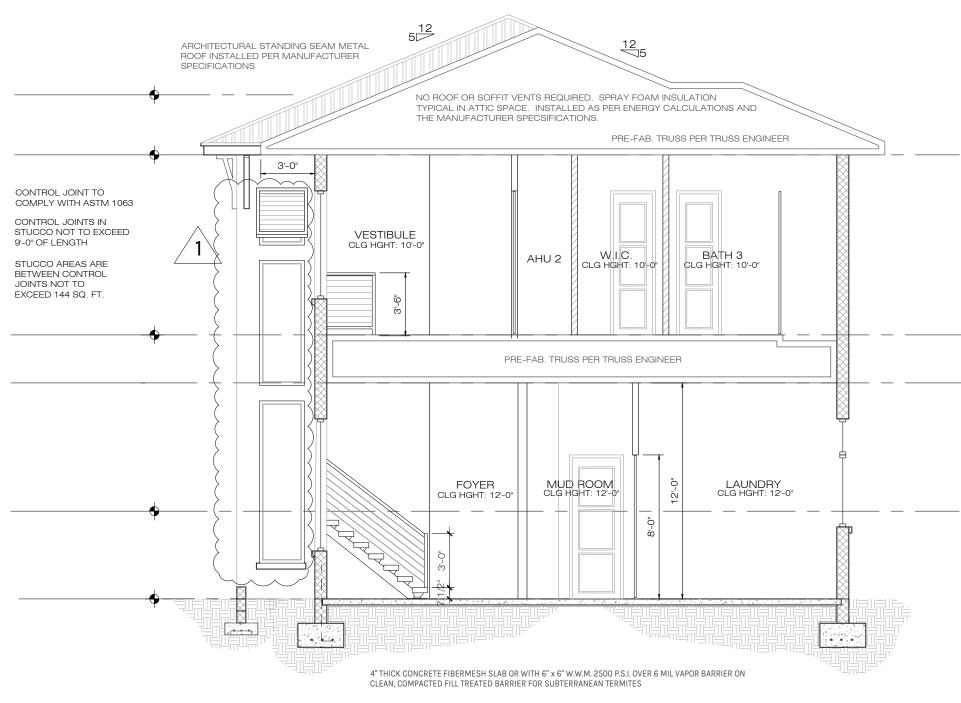


NOTE: INTERIOR METAL HANDRAILS AND GUARDS FOR ONE-AND TWO FAMILY DWELLINGS SHALL BE DESIGNED TO RESIST A CONCENTRATED LOAD OF 200 POUNDS (0.89 KN) IN ACCORDANCE WITH SECTION 4.5.1 OF ASCE 7. GLASS HANDRAIL ASSEMBLIES AND GUARDS SHALL ALSO COMPLY WITH SECTION 2407.

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ELEVATION NOTES

- TYPICAL 5/8" SMOOTH STUCCO FINISH @ C.M.U. WALL
- 2. TYPICAL 7/8" SMOOTH STUCCO FINISH @ FRAME
- 3. ARCHITECTURAL METAL STANDING-SEAM ROOF INSTALLED PER MANUFACTURER SPECIFICATION.
- 4. NO ROOF VENTS REQUIRED, SPRAY FOAM INSULATION TO BE USED PER ENERGY CALCULATIONS.
- 5. FRONT ELEVATION WINDOW SILLS TO BE 4" x 6" STUCCO AND/OR WHERE ALSO INDICATED.
- 6. 6" WOOD SIDING WHERE INDICATED, STYLE AND

COLOR PER CONTRACTOR AND OWNER.

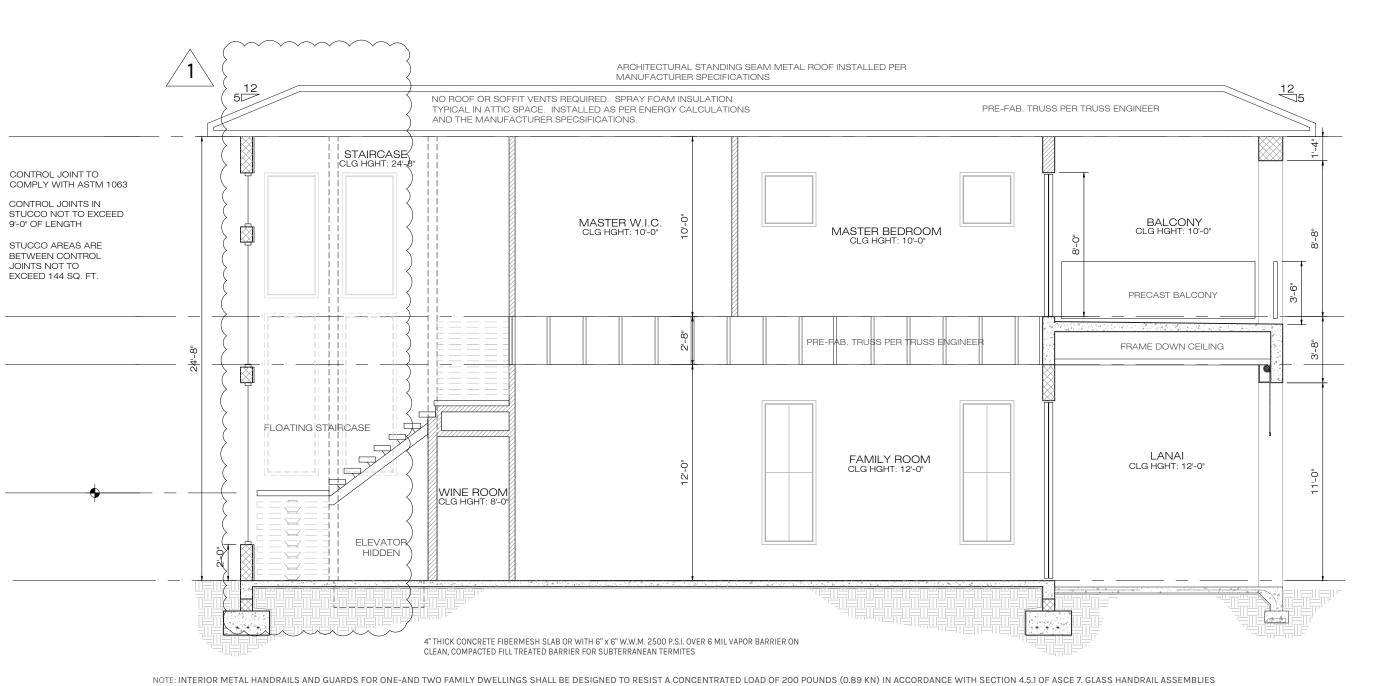- 7. CONTROL JOINTS ON EXTERIOR STUCCO WALLS OVER WOOD FRAME TO BE INSTALLED PER ASTM
- NOTE: CONTRACTOR TO VERIFY ALL ELEVATIONS PRIOR TO CONSTRUCTION AND CONTACT DESIGNER/ENGINEER WITH ANY CHANGES OR QUESTIONS.

EGRESS

MEAN OF ESCAPE NOTE (EGRESS):

ALL EGRESS WINDOWS TO COMPLY W/F.B.C. R 310.1. AN OUTSIDE WINDOW OR DOOR OPERABLE FROM THE INSIDE WITHOUT THE USE OF TOOLS AND PROVIDING A CLEAR OPENING OF NOT LESS THAN 20" WIDE X 24" HIGH AND 5.7 SF IN AREA. THE BOTTOM OF THE OPENING SHALL NOT BE MORE THAN 44" OF THE FLOOR, THE MODE OF OPERATION MUST NOT REQUIRE THE USE OF A KEY, TOOL OR SPECIAL KNOWLEDGE OR EFFORT TO MAKE AVAILABLE THE REQUIRED CLEAR OPENING, AND NO PART OF THE OPERATION MECHANISM SHALL BE PLACED HIGHER THAN 54" ABOVE THE FINISHED FLOOR.

EVERY CLOSET DOOR LATCH SHALL BE SUCH THAT CHILDREN CAN OPEN THE DOOR FROM INSIDE THE CLOSET, EVERY BATHROOM DOOR SHALL BE DESIGNED TO ALLOW OPENING FROM THE OUTSIDE ENSURING AN EMERGENCY WHEN LOCKED.

STUCCO APPLICATION

- TYPICAL 5/8" SMOOTH STUCCO FINISH @ C.M.U. WALLS
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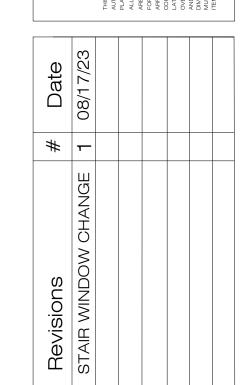
CONTROL JOINTS

- CONTROL JOINTS IN STUCCO SHALL NOT EXCEED 9'-0" IN LENGTH.
- STUCCO AREAS ARE BETWEEN CONTROLS JOINTS SHALL NOT EXCEED 144 SQ. FT.

GUARD RAILS

GUARD RAILS SHALL BE PROVIDED FOR THOSE PORTIONS OF OPEN-SIDED WALKING SURFACES, INCLUDING STAIRS, RAMPS AND LANDINGS, THAT ARE LOCATED MORE THAN 30" MEASURED VERTICALLY TO THE FLOOR OR GRADE BELOW AT ANY POINT WITHIN 24 INCHES HORIZONTALLY TO THE EDGE OF THE OPEN SIDE. INSECT SCREENING SHALL NOT BE CONSIDERED AS A GUARD. GUARDS SHALL NOT BE LESS THAN 36" IN HEIGHT. LARGEST GAPS BETWEEN HANDRAIL MEMBERS, PICKETS AND BASE SHALL NOT EXCEED 4". HANDRAIL/GUARDRAIL LIVE LOADS, GUARDS AND HANDRAILS (HIGHER OF 200LB PT LOAD OR 50PLF). GUARD/PICKET INFILL COMPONENTS, 50PSF OVER A 1 SQ. FT. AREA.





A NEW HOME BY ZERO LAITHUDE HOMES

WAVERLY SPEC HOME

LOT 5 - SOUTH HARBOR DR., VERO BEACH,

MERIDIAN CUSTOM HOMES

DANIEL SOUTER, P.E.
P.E.# 63901
P.O. BOX 547774
ORLANDO, FL 32854




PHONE: (407) 421-4866

Date	02-20-23
Project #	22-026
Drawn by	FVC
Checked by	JH/DS
Reviewed by Interior Design	YES

& Owner



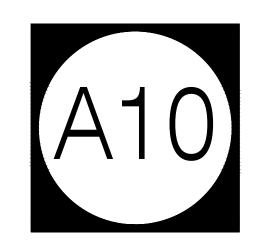



ELECTRICAL NOTES

1. DRAWINGS ARE DIAGRAMMATIC AND SHALL N OT BE SCALED. REFER TO ARCHITECTURAL PLANS AND ELEVATIONS FOR EXACT LOCATION OF ALL EQUIPMENT AND MANUFACTURER'S SPECIFICATIONS FOR CORRECT INSTALLATION. ELECT

2. ELECTRICAL CONTRACTOR SHALL FURNISH AND INSTALL ALL ITEMS REQUIRED FOR A COMPLETE AND ACCEPTABLE WORKING INSTALLATION. ALL INSTALLATIONS ARE TO BE CHECKED AS WORKING PRIOR TO OCCUPANCY CERTIFICATION.

(NEC) AND WITH ALL LOCAL ORDINANCES HAVING JURISDICTION, PER 2017 NEC EDITION.

4. VERIFY LOCATION OF ALL OUTLETS, RECEPTACLES, SWITCHES, COAX CABLE, CAT 6 DATA,

3. ALL WORK SHALL COMPLY WITH THE LATEST EDITION OF THE NATIONAL ELECTRICAL CODE

FIXTURES, ETC., WITH OWNER PRIOR TO ANY INSTALLATION.

5. ALL SECURITY SYSTEMS SHALL HAVE 3 PADS. VERIFY OWNER/CONTRACTOR AGREEMENT AND LOCATIONS OF PADS PRIOR TO ANY INSTALLATION.

6. ALL WORK TO BE PERFORMED BY A LICENSED ELECTRICAL CONTRACTOR.

7. ALL MATERIAL SHALL BE NEW AND BEAR THE UNDERWRITERS LABEL (U.L.) WHERE APPLICABLE.

8. THE ELECTRICAL, TELEPHONE, DATA AND CABLE TELEVISION INSTALLATIONS SHALL MEET ALL REQUIREMENTS BY THE LOCAL UTILITY COMPANIES.

9. THE ELECTRICAL SYSTEM SHALL BE COMPLETELY AND EFFECTIVELY GROUNDED AS REQUIRED IN ARTICLE 250 OF THE NATIONAL ELECTRICAL CODE (NEC).

10. ALL WORK SHALL BE COORDINATED WITH OTHER TRADES TO AVOID INTERFERENCE WITH THE PROGRESS OF CONSTRUCTION.

11. UNLESS OTHERWISE INDICATED, ALL RECEPTACLES, CABLE, DATA, AND TELEPHONE OUTLETS TO BE 18" A.F.F.

12. SMOKE DETECTORS ARE INTERCONNECTED AND TO HAVE BATTERY BACKUP, INSTALLED PER NFPA 72.29.8.3.4

13. ALL NON-GFI OUTLETS TO BE ON ARC-FAULT INTERRUPTERS

14. GFI OUTLETS LOCATION OUTDOORS ARE TO BE WATERPROOF & TAMPER-RESISTANT

15. GIF OUTLEST LOCATED IN GARAGES, KITCHENS, AND BATHROOMS, SHALL BE TAMPER-PROOF.

16. ALL DETECTORS SHALL BE SMOKE/CARBON MONOXIDE COMBO, AND SHALL BE HARDWIRED AND INTERCONNECTED WITH BATTERY BACKUP, AND SHALL BE INSTALLED PER NFPA 72.29.8.3.4 - IN NO CASE SHALL MORE THAN 18 INITIATING DEVICES BE INTERCONNECTED OF WHICH 12 CAN BE SMOKE ALARMS WHERE THE INTERCONNECTING MEANS IS NOT SUPERVISED. PER NFPA 72.29.8.2 HOMES WITH A LARGE NUMBER OF BEDROOMS WHERE MORE THAN 12 SMOKE ALARMS OR CARBON MONOXIDE ALARM COMBINATION, WILL REQUIRE A SEPARATE PERMIT FOR A FIRE ALARM SYSTEM.

17. ELECTRICAL METER AN PANEL LOCATION MAY VARY AS PER SERVICE ENTRANCE LOCATION.

18. ALL WIRING TO BE COPPER.

SECOND FLOOR

EXTERIOR LIGHTING

19. IF CHOSEN BY OWNER, CONTRACTOR TO VERIFY LOCATION OF E.C.P. 240V ELECTRIC CHARGING PORT WITH OWNER PRIOR TO INSTALLATION. ELECTRIC CAR CHARGING STATION TO BE INSTALLED PER MANUFACTURER'S SPECIFICATIONS. VERIFY CHARGING STATION SPECIFICATIONS MATCH OWNERS VEHICLES.

NOTE: THIS DIAGRAMMATIC PLAN IS INTENDED TO SHOW LIGHTING AND CONVENIENCE OUTLETS ONLY. ZERO LATITUDE INC. WILL BEAR NO RESPONSIBILITY FOR IT'S ACCURACY. IT IS THE ELECTRICAL CONTRACTOR'S RESPONSIBILITY TO VERITY THE REQUIREMENTS AND LOCATIONS OF ALL ELECTRICAL EQUIPMENT AND PROVIDE AND INSTALL COMPLETE ELECTRICAL SERVICES AS REQUIRED PRIOR TO COMMENCING WITH ANY INSTALLATION. ELECTRICAL CONTRACTOR TO SUBMIT PLAN AND PULL PERMIT.

FIRE-SMOKE ALARM SYSTEM

NFPA 72 29.5.1.3.1

All points on the ceiling shall have a smoke alarm within a distance of 30 ft (9.1 m) travel distance or shall have an equivalent of one smoke alarm per 500 ft2 (46 m2) of floor area.

29.5.1.1 - Where required by other governing laws, codes, or standards for a specific type of occupancy, approved single and multiple-station smoke alarms shall be installed as follows:

(2) In all sleeping rooms and guest rooms
(2) Outside of each separate dwelling unit sleeping area, within 21 ft. of any door to a sleeping room, with the distance measured along a path of travel
(3) On every level of a dwelling unit, including basements
(4) On every level of a residential board and care

occupancy (small facility), including basements and excluding crawl spaces and unfinished attics (5) In the living area(s) of a guest suite (6) In the living area(s) of a residential board and care occupancy (small facility)

ELECTRICAL CONTRACTOR AND OR SECURITY SYSTEMS CONTRACTOR SHALL BE RESPONSIBLE TO ENSURE

THAT ALL DOORS AND WINDOWS PROVIDING DIRECT

EQUIPPED WITH AN EXIT ALARM THAT HAS A MINIMUM

SOUND PRESSURE RATING OF 85 DECIBELS AT 10 FEET,

STATUTES SECTIONS 515.21 - 515.37, THE RESIDENTIAL

ACCESS FROM THE HOME TO THE POOL WILL BE

PER THE REQUIREMENTS DESCRIBED IN FLORIDA

SECURITY SYSTEM

SWIMMING POOL SAFETY ACT.

29.5.1.2 - Where the area addressed in 29.5.1.1(2) is separated from the adjacent living areas by a door, a smoke alarm shall be installed in the area between the door and the sleeping rooms, and additional alarms shall be installed on the living area side of the door as specified by 29.5.1.1 and 29.5.1.3.

29.5.1.3 - In addition to the requirements of 29.5.1.1(1) through (3), where the interior floor area for a given level of a dwelling unit, excluding garage areas, is greater than 1000 ft2 smoke alarms shall be installed per 29.5.1.3.1 and 29.5.1.3.2.

29.5.1.3.1 - All points on the ceiling shall have a smoke alarm within a distance of 30 ft. travel distance or shall have an equivalent of one smoke alarm per 500 ft2 of floor area. One smoke alarm per 500 ft2 is evaluated by dividing the total interior square footage of floor area per level by 500 ft2

29.5.1.3.2 - Where dwelling units include great rooms or vaulted/cathedral ceilings extending over multiple floors, smoke alarms located on the upper floor that are intended to protect the aforementioned area shall be permitted to be considered as part of the lower floor(s) protection scheme used to meet the requirements of 29.5.1.3.1.

29.5.2.1.1 - Smoke and Heat Alarms. Unless exempted by applicable laws, codes, or standards, smoke or heat alarms used to provide a fire-warning function, and when two or more alarms are installed within a dwelling unit, suite of rooms, or similar area, shall be arranged so that the operation of any smoke or heat alarm causes all alarms within these locations to sound.

NOTE: A SUPERVISED FIRE ALARM SYSTEM IS REQUIRED TO BE INSTALLED PER NFPA 72.29.8.2 - A SEPARATE FIRE ALARM PERMIT IS REQUIRED. THE SYSTEM DESIGN, PERMIT APPLICATION AND INSTALLATION IS THE RESPONSIBILITY OF THE FIRE ALARM SYSTEM COMPANY. ZERO LATITUDE INC. WILL BEAR NO RESPONSIBILITY FOR IT'S ACCURACY.

THIS DIAGRAMMATIC PLAN IS INTENDED TO SHOW LIGHTING AND CONVENIENCE OUTLETS ONLY. ZERO LATITUDE WILL BEAR NO RESPONSIBILITY FOR IT'S ACCURACY. IT IS THE ELECTRICAL CONTRACTOR'S RESPONSIBILITY TO VERIFY THE THE REQUIREMENTS AND LOCATIONS OF ALL ELECTRICAL EQUIPMENT AND PROVIDE AND INSTALL COMPLETE ELECTRICAL SERVICES AS REQUIRED. ELECTRICAL CONTRACTOR TO SUBMIT PLAN AND PULL PERMIT.

LIGHTING OPTIONAL SUMMER KITCHEN PORCH WINE ROOM SINGLE SWITCH TO ELEVATOR SOFFIT RECEPTACLES FOR HOLIDAY LIGHTING - TIMER OPT. 8'-3 3/4" FAMILY ROOM 6'-8 3//4" 13'-9 3/4" EXTERIOR LANAI 2-CAR GARAGE KITCHEN LED DEFORMABLE POOL BATH POOL STOR ZERO LATITUDE COPYRIGHT 2022


WALL KEYNOTE	
8" CMU	×
WD. STUD	7
BEARING STUD	

ELECTRICAL SYMBOLS LEGEND

ELECTRIC METER

	ELECTRIC PANEL
DISP	ELECTRICAL - A/C DISCONNECT
\ominus	DUPLEX OUTLET
FO	FLOOR OUTLET LOCATE PER OWNERS / BUILDER
\rightarrow	DUPLEX OUTLET -HALF SWITCHED
⊕ WP	WEATHER PROOF DUPLEX OUTLET
⊕ G.F.I.	G.F.I DUPLEX OUTLET
	220 VOLT RECEPTACLE
-[2]	TELEVISION JACK
\triangleleft	CAT 6 NETWORK
V	CENTRAL VACUUM HOSE OUTLET
()	WALL SWITCH
Θ_{ω}	3-WAY WALL SWITCH
₩ ₄	4-WAY WALL SWITCH
₩	DIMMER WALL SWITCH
- ••	PUSH BUTTON WALL SWITCH
	CEILING MOUNTED LIGHT FIXTURE
H	WALL MOUNTED LIGHT FIXTURE
J	JUNCTION BOX
∇ ∇	TRACK LIGHTING
\bigcirc	HANGING LIGHT FIXTURE
	RECESSED LIGHT FIXTURE
	RECESSED HIGHLIGHTING LIGHT FIXTURE
V.P.	VAPOR RESISTANT RECESSED LIGHT FIXTURE
EXT.	EXTERIOR RECESSED LIGHT FIXTURE
0	4' LONG FLUORESCENT LIGHT FIXTURE
	52" CEILING FAN WITH LIGHT
	FLOOD LIGHT
T	THERMOSTAT
FACP	FIRE ALARM CONTROL PANEL
SD	SMOKE DETECTOR
ĆMD	SMOKE & CARBON MONOXIDE DETECTOR
€ _{E.F.}	EXHAUST FAN CFM MIN 80
+	CEILING OUTLET
-	NEMA 14-50 (220V) ELECT CAR CHARGER OUTLET
•	GARAGE DOOR POWER BUTTON
•	DOORBELL BUTTON
~ ~	LED GARAGE, DEFORMABLE TRIPLE LIGHT
CH CH	DOORBELL CHIME


SMOKE DETECTOR GOES INSIDE BEDROOMS
SMOKE & CARBON MONOXIDE DETECTOR GOES IN COMMON AREAS

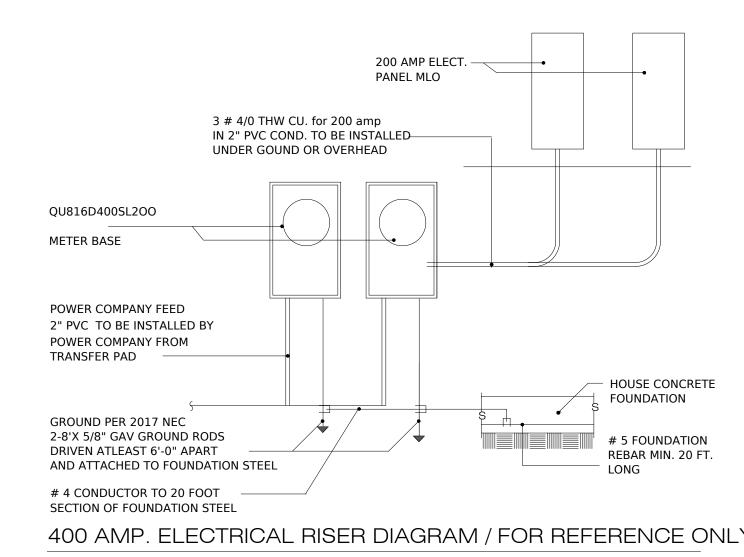

DESIGN WITH AN ELECTRICAL RISER DIAGRAM AND LOAD CALCULATIONS IS THE RESPONSIBILITY OF THE ELECTRICAL CONTRACTOR, AND SHALL VERIFY PANEL AMPERAGE IS CORRECT PRIOR

PERMIT SET

FOR CONSTRUCTION

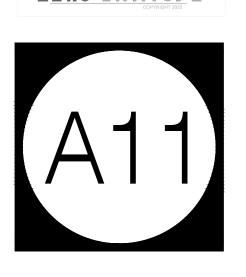

DANIEL SOUTER, P.E.

P.E.# 63901

P.O. BOX 547774

ORLANDO, FL 32854 PHONE: (407) 421-4866

meridian

Project #

Drawn by

Reviewed by

& Owner

Checked by JH/DS

Interior Design YES

02-20-23

-

Signal Si

1 ELECTRICAL 1ST FLOOR PLAN
A11 SCALE: 1/4" = 1'-0"

NUMBER OF SMOKE DETECTORS PER CODE: 2,018 / 500 = 4

SMOKE DETECTORS REQUIRED - 5 PROVIDED

ELECTRICAL NOTES

1. DRAWINGS ARE DIAGRAMMATIC AND SHALL N OT BE SCALED. REFER TO ARCHITECTURAL PLANS AND ELEVATIONS FOR EXACT LOCATION OF ALL EQUIPMENT AND MANUFACTURER'S SPECIFICATIONS FOR CORRECT INSTALLATION. ELECT

2. ELECTRICAL CONTRACTOR SHALL FURNISH AND INSTALL ALL ITEMS REQUIRED FOR A COMPLETE AND ACCEPTABLE WORKING INSTALLATION. ALL INSTALLATIONS ARE TO BE CHECKED AS WORKING PRIOR TO OCCUPANCY CERTIFICATION.

3. ALL WORK SHALL COMPLY WITH THE LATEST EDITION OF THE NATIONAL ELECTRICAL CODE (NEC) AND WITH ALL LOCAL ORDINANCES HAVING JURISDICTION, PER 2017 NEC EDITION.

4. VERIFY LOCATION OF ALL OUTLETS, RECEPTACLES, SWITCHES, COAX CABLE, CAT 6 DATA, FIXTURES, ETC., WITH OWNER PRIOR TO ANY INSTALLATION.

5. ALL SECURITY SYSTEMS SHALL HAVE 3 PADS. VERIFY OWNER/CONTRACTOR AGREEMENT AND LOCATIONS OF PADS PRIOR TO ANY INSTALLATION.

6. ALL WORK TO BE PERFORMED BY A LICENSED ELECTRICAL CONTRACTOR.

7. ALL MATERIAL SHALL BE NEW AND BEAR THE UNDERWRITERS LABEL (U.L.) WHERE APPLICABLE.

8. THE ELECTRICAL, TELEPHONE, DATA AND CABLE TELEVISION INSTALLATIONS SHALL MEET ALL REQUIREMENTS BY THE LOCAL UTILITY COMPANIES.

9. THE ELECTRICAL SYSTEM SHALL BE COMPLETELY AND EFFECTIVELY GROUNDED AS REQUIRED IN ARTICLE 250 OF THE NATIONAL ELECTRICAL CODE (NEC).

10. ALL WORK SHALL BE COORDINATED WITH OTHER TRADES TO AVOID INTERFERENCE WITH THE PROGRESS OF CONSTRUCTION.

11. UNLESS OTHERWISE INDICATED, ALL RECEPTACLES, CABLE, DATA, AND TELEPHONE OUTLETS TO BE 18" A.F.F.

12. SMOKE DETECTORS ARE INTERCONNECTED AND TO HAVE BATTERY BACKUP, INSTALLED PER NFPA 72.29.8.3.4

13. ALL NON-GFI OUTLETS TO BE ON ARC-FAULT INTERRUPTERS

14. GFI OUTLETS LOCATION OUTDOORS ARE TO BE WATERPROOF & TAMPER-RESISTANT

15. GIF OUTLEST LOCATED IN GARAGES, KITCHENS, AND BATHROOMS, SHALL BE TAMPER-PROOF.

16. ALL DETECTORS SHALL BE SMOKE/CARBON MONOXIDE COMBO, AND SHALL BE HARDWIRED AND INTERCONNECTED WITH BATTERY BACKUP, AND SHALL BE INSTALLED PER NFPA 72.29.8.3.4 - IN NO CASE SHALL MORE THAN 18 INITIATING DEVICES BE INTERCONNECTED OF WHICH 12 CAN BE SMOKE ALARMS WHERE THE INTERCONNECTING MEANS IS NOT SUPERVISED. PER NFPA 72.29.8.2 HOMES WITH A LARGE NUMBER OF BEDROOMS WHERE MORE THAN 12 SMOKE ALARMS OR CARBON MONOXIDE ALARM COMBINATION, WILL REQUIRE A SEPARATE PERMIT FOR A FIRE ALARM SYSTEM.

17. ELECTRICAL METER AN PANEL LOCATION MAY VARY AS PER SERVICE ENTRANCE LOCATION.

18. ALL WIRING TO BE COPPER.

19. IF CHOSEN BY OWNER, CONTRACTOR TO VERIFY LOCATION OF E.C.P. 240V ELECTRIC CHARGING PORT WITH OWNER PRIOR TO INSTALLATION. ELECTRIC CAR CHARGING STATION TO BE INSTALLED PER MANUFACTURER'S SPECIFICATIONS. VERIFY CHARGING STATION SPECIFICATIONS MATCH OWNERS VEHICLES.

NOTE: THIS DIAGRAMMATIC PLAN IS INTENDED TO SHOW LIGHTING AND CONVENIENCE OUTLETS ONLY. ZERO LATITUDE INC. WILL BEAR NO RESPONSIBILITY FOR IT'S ACCURACY. IT IS THE ELECTRICAL CONTRACTOR'S RESPONSIBILITY TO VERITY THE REQUIREMENTS AND LOCATIONS OF ALL ELECTRICAL EQUIPMENT AND PROVIDE AND INSTALL COMPLETE ELECTRICAL SERVICES AS REQUIRED PRIOR TO COMMENCING WITH ANY INSTALLATION. ELECTRICAL CONTRACTOR TO SUBMIT PLAN AND PULL PERMIT.

FIRE-SMOKE ALARM SYSTEM

NFPA 72 29.5.1.3.1

All points on the ceiling shall have a smoke alarm within a distance of 30 ft (9.1 m) travel distance or shall have an equivalent of one smoke alarm per 500 ft2 (46 m2) of floor area.

29.5.1.1 - Where required by other governing laws, codes, or standards for a specific type of occupancy, approved single and multiple-station smoke alarms shall be installed as follows: (2) In all sleeping rooms and guest rooms

(2) Outside of each separate dwelling unit sleeping area, within 21 ft. of any door to a sleeping room, with the distance measured along a path of travel (3) On every level of a dwelling unit, including basements

(4) On every level of a residential board and care occupancy (small facility), including basements and excluding crawl spaces and unfinished attics (5) In the living area(s) of a guest suite (6) In the living area(s) of a residential board and care occupancy (small facility)

smoke alarm within a distance of 30 ft. travel distance or shall have an equivalent of one smoke alarm per 500 ft2 of floor area. One smoke alarm per 500 ft2 is evaluated by dividing the total interior square footage of floor area per level by 500 ft2

29.5.1.3.1 - All points on the ceiling shall have a

the door as specified by 29.5.1.1 and 29.5.1.3.

per 29.5.1.3.1 and 29.5.1.3.2.

29.5.1.3 - In addition to the requirements of 29.5.1.1(1)

through (3), where the interior floor area for a given

greater than 1000 ft2 smoke alarms shall be installed

level of a dwelling unit, excluding garage areas, is

29.5.1.2 - Where the area addressed in 29.5.1.1(2) is **29.5.1.3.2** - Where dwelling units include great rooms separated from the adjacent living areas by a door, a or vaulted/cathedral ceilings extending over multiple floors, smoke alarms located on the upper floor that smoke alarm shall be installed in the area between the door and the sleeping rooms, and additional are intended to protect the aforementioned area alarms shall be installed on the living area side of shall be permitted to be considered as part of the lower floor(s) protection scheme used to meet the requirements of 29.5.1.3.1.

> 29.5.2.1.1 - Smoke and Heat Alarms. Unless exempted by applicable laws, codes, or standards, smoke or heat alarms used to provide a fire-warning function, and when two or more alarms are installed within a dwelling unit, suite of rooms, or similar area, shall be arranged so that the operation of any smoke or heat alarm causes all alarms within these locations to

NOTE: A SUPERVISED FIRE ALARM SYSTEM IS REQUIRED TO BE INSTALLED PER NFPA 72.29.8.2 - A SEPARATE FIRE ALARM PERMIT IS REQUIRED. THE SYSTEM DESIGN, PERMIT APPLICATION AND INSTALLATION IS THE RESPONSIBILITY OF THE FIRE ALARM SYSTEM COMPANY. ZERO LATITUDE INC. WILL BEAR NO RESPONSIBILITY FOR IT'S ACCURACY.


ELECTRICAL SYMBOLS LEGEND

ELECTRIC METER

METER

	ELECTRIC PANEL
DISC	ELECTRICAL - A/C DISCONNECT
\bigoplus	DUPLEX OUTLET
FO	FLOOR OUTLET LOCATE PER OWNERS / BUILDER
\rightarrow	DUPLEX OUTLET -HALF SWITCHED
⇒ WP	WEATHER PROOF DUPLEX OUTLET
⊕ G.F.I.	G.F.I DUPLEX OUTLET
	220 VOLT RECEPTACLE
-[2]	TELEVISION JACK
\triangleleft	CAT 6 NETWORK
V	CENTRAL VACUUM HOSE OUTLET
\leftrightarrow	WALL SWITCH
\leftrightarrow°	3-WAY WALL SWITCH
Θ_4	4-WAY WALL SWITCH
₩	DIMMER WALL SWITCH
•	PUSH BUTTON WALL SWITCH
	CEILING MOUNTED LIGHT FIXTURE
-	WALL MOUNTED LIGHT FIXTURE
J	JUNCTION BOX
\Box \Box \Box	TRACK LIGHTING
\odot	HANGING LIGHT FIXTURE
	RECESSED LIGHT FIXTURE
\longrightarrow	RECESSED HIGHLIGHTING LIGHT FIXTURE
V.P.	VAPOR RESISTANT RECESSED LIGHT FIXTURE
EXT.	EXTERIOR RECESSED LIGHT FIXTURE
	4' LONG FLUORESCENT LIGHT FIXTURE
	52" CEILING FAN WITH LIGHT
	FLOOD LIGHT
	THERMOSTAT
FACP	FIRE ALARM CONTROL PANEL
SD	SMOKE DETECTOR
ĆMD	SMOKE & CARBON MONOXIDE DETECTOR
€ _{E.F.}	EXHAUST FAN CFM MIN 80
+	CEILING OUTLET
-	NEMA 14-50 (220V) ELECT CAR CHARGER OUTLET
	GARAGE DOOR POWER BUTTON
•	DOORBELL BUTTON
	LED GARAGE, DEFORMABLE TRIPLE LIGHT
СН	DOORBELL CHIME
• W.H. •	INSTA-HOT EXTERIOR WATER HEATER

SMOKE DETECTOR GOES INSIDE BEDROOMS SMOKE & CARBON MONOXIDE DETECTOR GOES IN COMMON AREAS

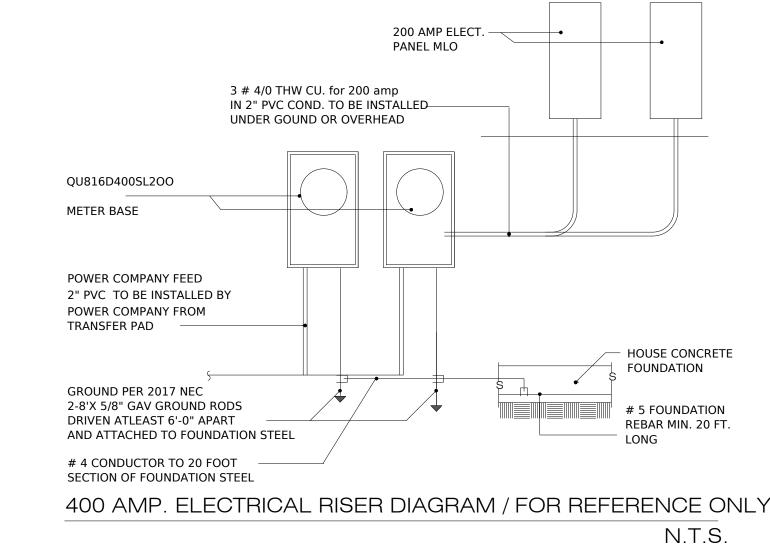

DESIGN WITH AN ELECTRICAL RISER DIAGRAM AND LOAD CALCULATIONS IS THE RESPONSIBILITY OF THE ELECTRICAL CONTRACTOR, AND SHALL VERIFY PANEL AMPERAGE IS CORRECT PRIOR TO COMMENCING ANY ELECTRICAL WORK.


WD. STUD

BEARING STUD

SECURITY SYSTEM

ELECTRICAL CONTRACTOR AND OR SECURITY SYSTEMS CONTRACTOR SHALL BE RESPONSIBLE TO ENSURE THAT ALL DOORS AND WINDOWS PROVIDING DIRECT ACCESS FROM THE HOME TO THE POOL WILL BE EQUIPPED WITH AN EXIT ALARM THAT HAS A MINIMUM SOUND PRESSURE RATING OF 85 DECIBELS AT 10 FEET, PER THE REQUIREMENTS DESCRIBED IN FLORIDA STATUTES SECTIONS 515.21 - 515.37, THE RESIDENTIAL SWIMMING POOL SAFETY ACT.

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ELECTRICAL 1ST FLOOR PLAN A12 SCALE: 1/4" = 1'-0"
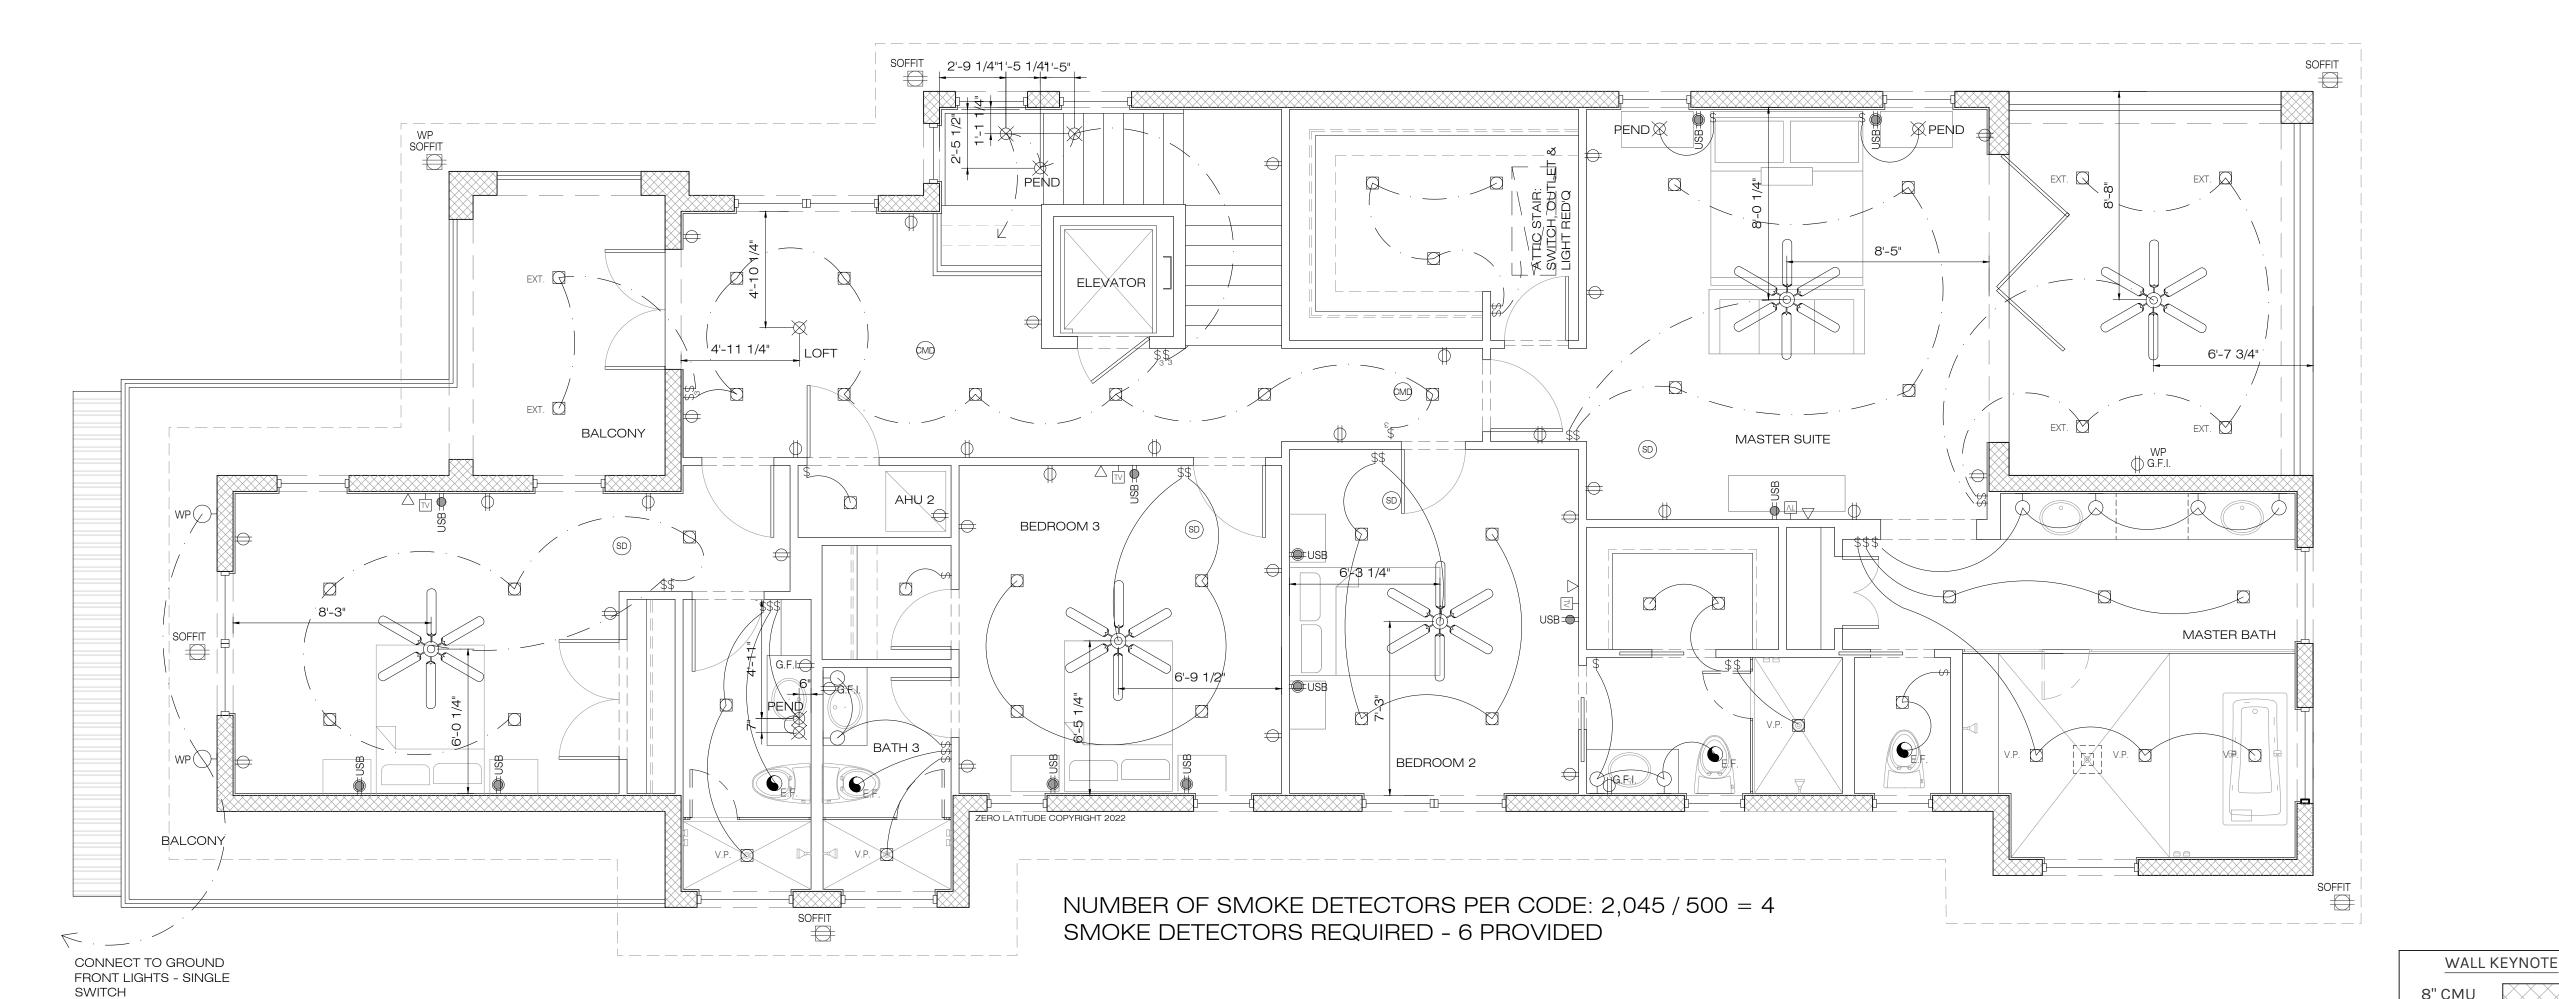
> PERMIT SET FOR CONSTRUCTION

¶ Si TO

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Date 02-20-23 Project # Drawn by Checked by JH/DS Reviewed by Interior Design YES

& Owner



