#### A NEW HOME BY ZERO LATITUDE:

## THE HIDEAWAY

## SOUTH HARBOR DRIVE - LOT 7 VERO BEACH, INDIAN RIVER COUNTY, FLORIDA A MERIDIAN HOMES CONSTRUCTION PROJECT



SHEET INDEX	GENERAL NO	DTES	APPLICABLE CODES	DESIGN PROFESSIONALS	
COVER SHEET & DATA  2- SITE PLAN  3- PLUMBING/SLAB PLAN  4- DIMENSIONED 1ST FLOOR  5- DETAILED 1ST FLOOR  6- DIMENSIONED 2ND FLOOR  7- DETAILED 2ND FLOOR  8- ROOF PLAN  9- ELEVATIONS  110- SECTIONS  111- ELECTRICAL 1ST FLOOR  12- ELECTRICAL 2ND FLOOR	<ol> <li>IT IS THE INTENT OF THE DESIGNER; ENGINEER THAT THIS WORK BE IN CONFORMANCE WITH ALL REQUIREMNENTS OF THE BUILDING AUTHORITIES HAVING JURISDICTION OVER THIS TYPE OF CONSTRUCTION AND OCCUPANCY. ALL CONTRACTORS SHALL DO THEIR WORK IN CONFORMANCE WITH ALL APPLICABLE CODES AND REGULATIONS.</li> <li>THE CONTRACTOR SHALL VERIFY ALL CONDITIONS AND CONDITIONS AT THE JOBSITE PRIOR TO COMMENCING WORK. CONTRACTOR SHALL REPORT ALL DISCREPANCIES IN THE DRAWING AND EXISTING CONDITIONS TO THE DESIGNER/ENGINEER PRIOR TO COMMENCING WORK.</li> <li>CONTRACTOR SHALL SUPPLY, LOCATE AND BUILD IN THE WORK ALL INSERTS, ANCHORS, ANGLES, PLATES, OPENINGS, SLEEVES, HANGERS, SLAB DEPRESSIONS, AND PITCHES AS MAY BE REQUIRED TO ATTACH AND ACCOMODATE OTHER WORK.</li> <li>THESE DOCUMENTS, AS INSTRUMENTS OF SERVICE, ARE THE PROPERTY OF THE DESIGNER/ENGINEER AND MAY NOT BE USED OR REPRODUCED WITHOUT EXPRESSED WRITTEN CONSENT OF THE DESIGNER/ENGINEER.</li> <li>ALL DETAILS AND SECTIONS SHOWN ON THE DRAWINGS ARE INTENDED TO BE TYPICAL AND SHALL BE CONSTRUED TO APPLY TO ANY SIMILAR SITUATION ELSEWHERE IN THE WORK EXCEPT WHERE A DIFFERENT DETAIL IS SHOWN.</li> <li>SUBSURFACE SOIL CONDITION INFORMATION IS NOT AVAILABLE. FOUNDATIONS ARE DESIGNED FOR A 2000 PSF SOIL BEARING CAPACITY. CONTRACTOR SHALL REPORT ANY DIFFERING CONDITIONS TO THE DESIGNER/ENGINEER PRIOR TO COMMENCING WORK.</li> </ol>	<ul> <li>15. ALL WIND LOAD CALCULATIONS AND DESIGN CRITERIA ARE BASED ON A "ENCLOSED" STRUCTURE. ANY BREACH OR PENETRATION, SUCH AS WINDOWS, DOORS, GARAGE DOORS, ETC., DURING STORM EVENT WILL COMPROMISE STRUCTURAL INTEGRITY.</li> <li>16. ALL DOOR AND WINDOW OPENINGS SHALL BE INSTALLED PER MANUFACTURER'S SPECIFICATIONS.</li> <li>17. ALL SHEAR WALLS MUST TRANSFER LOADS TO FLOOR JOISTS OR FOUNDATION.</li> <li>18. DIAPHRAGM SYSTEMS MUST BE ATTACHED TO END WALLS AND/OR SIDE WALLS.</li> <li>19. TRUSSES MUST BE CAPABLE OF TRANSFERRING LATERAL LOADS TO BEARING WALLS.</li> <li>20. TRUSSES, GIRDERS AND BEAM TIE DOWNS ARE SIZED PER UPLIFT REQUIREMENTS. ANY QUESTION AS TO SIZE, TYPE OR VALUE OF A NAIL, STRAP OR CLIP SHOULD BE VERIFIED BY STRUCTURAL ENGINEER.</li> <li>21. ALL WINDOWS TO COMPLY WITH THE 2020 FLORIDA BUILDING CODE 139 MPH WIND LOAD REQUIREMENT.</li> <li>22. SUBCONTRACTORS SHALL VERIFY ALL APPLICABLE DIMENSIONS AND FIXTURE LOCATIONS.</li> </ul>	SINGLE FAMILY RESIDENCE  • FLORIDA BUILDING CODE, 7TH EDITION (2020), BUILDING (FBCB) WITH SUPPLEMENTS • FLORIDA BUILDING CODE, 7TH EDITION (2020), PLUMBING (FBCP) • FLORIDA BUILDING CODE, 7TH EDITION (2020), MECHANICAL (FBCM) • NATIONAL ELECTRICAL CODE, 2017 (NEC) • ASCE7-16  RESIDENTIAL DESIGNER: ZERO LATITUDE 210 SOUTH PARK AVE., SANFORD, FL 32771 (239) 682-2210  GENERAL CONTRACTOR: Meridian Homes 1810 Chippewa Trail Maitland, FL. 32751 754-4154  TRUSS DESIGN: Trusswood Roof & Floor Tr		
-2 STRUCTURAL DETAILS -3 FOUNDATION PLAN	STRUCTURAL DETAILS FOUNDATION PLAN LINTEL PLAN LOWER TRUSS FRAMING PLAN UPPER TRUSS FRAMING PLAN UPPER TRUSS FRAMING PLAN UPPER TRUSS FRAMING PLAN STRUCTURAL DETAILS  CONTRACTOR SHALL BE TURNED OVER TO OWNER IN CLEAN CONDITION WITH ALL TRASH AND DEBRIS REMOVED FROM SIT, ALL WINDOWS AND BLASS CLEAN, ALL HOORS CLEAN, ALL HORIZONTAL SURFACES DUSTED AND CLEANED, AND ALL TOILET AND PLUMBING FIXTURES CLEAN AND IN GOOD WORKING ORDER.  CONTRACTOR TO OBTAIN ALL PERMITS AND TO PAY ALL FEES AND TAXES.  10. CONTRACTOR TO OBTAIN ALL PERMITS AND TO PAY ALL FEES AND TAXES.  11. DIMENSIONS INDICATED ON THE DRAWINGS IN REFERENCE TO EXISTING CONDITIONS ARE THE BEST AVAILABLE DATA OBTAINABLE, BUT ARE NOT GUARANTEED. BEFORE PROCESSING WITH ANY WORK DEPENDENT UPON THE DATA INVOLVED, THE CONTRACTOR SHALL FIELD OHEOX AND VERIFY ALL DIMENSIONS, GRADES, LINES, LEVELS OR OTHER CONDITIONS OF LIMITATIONS AT THE SITE TO AVOID CONSTRUCTION ERRORS. IF ANY WORK IS PERFORMED BY THE CONTRACTOR OR ANY OF HIS SUBCONTRACTORS PRICE TO ADEQUATE VERIFICATION OF APPLICABLE DATA, ANY RESULTANT EXTRA COST FOR ADJUSTMENT OF WORK AS REQUIRED TO CONFORM TO EXISTING LIMITATIONS, SHALL BE DESTRIBUTED BY THE CONTRACTOR WITHOUT REIMBURSEMENT OR COMPENSATION BY THE OWNER.  12. A DESIGNATED LOCATION FOR STORAGE OF CONSTRUCTION MATERIAL AND EQUIPMENT SHALL BE DETERMINED BY OWNER AND DENTIFIED AT THE PRECONSTRUCTION MEETING.  13. CONTRACTOR PERSONNEL ARE CONFINED TO AREAS OF BUILDING NECESSARY FOR COMPLETING THE WORK. FREE ACCESS TO ALL PARTS OF THE BUILDING IS NOT ALLOWED. ALL CONTRACTOR TOOL BOXES, CONTAINER, ETC., ARE SUBJECT TO OWNERS INSPECTION.  14. CONTRACTOR IS RESPONSIBLE FOR SCHEDULING DELIVERY, RECEIVING, UNLOADING, UNCRATING, STORING, SETTING IN PLACE, AND PROTECTIONS FROM DAMAGE ALL NEW EQUIPMENT FURNISHED BY THE CONTRATOR. THIS SHALL ALSO APPLYTO	<ul> <li>23. ALL INTERIOR SLABS TO HAVE STEEL TROWEL FINISH. ALL EXTERIOR SLABS TO HAVE MEDIUM BROM FINISH.</li> <li>24. REFER TO TUB/SHOWER MANUFACTURER FOR DRAIN LOCATION, PER OWNERS SELECTION.</li> </ul>	BUILDING DATA - LC	OT 7 3620 Bobbi Lane P.O. Box 5366	
S-4 LINTEL PLAN S-5 LOWER TRUSS FRAMING PLAN S-6 UPPER TRUSS FRAMING PLAN		<ul> <li>25. ALL PLUMBING TO MEET LOCAL PLUMBING CODES.</li> <li>26. PROVIDE STUB-OUT FOR ICE MAKER AT REFRIGERATOR LOCATION.</li> <li>27. REFER TO DOOR &amp; WINDOW SCHEDULE FOR DOOR &amp; WINDOW HEIGHTS</li> <li>28. WINDOWS AND EXTERIOR DOORS SHALL COMPLY WITH FBC WIND LOAD REQUIREMENTS. (WINDOWS MUST MEET R-30)</li> </ul>	THE HIDEAW	ENGINEERING:	
-7 STRUCTURAL DETAILS		29. USE GREENBOARD AT WET WALLS  30. PROVIDE BLOCKING AT 33"-36" AFF IN BATHROOM WALLS ABOVE WATER CLOSET, TUB/SHOWER FAUCETS AND TUB SOAP DISH FOR FUTURE GRAB BARS.  31. CONTRACTOR TO PROVIDE SITE ADDRESS PER SECTION R-319 OF 2020 FLORIDA BUILDING CODE RESIDENTIAL  32. FOAM PLASTIC MATERIALS TO MEET THE REQUIREMENTS OF THE 2020 FLORIDA BUILDING CODE RESIDENTIAL.  33. PROTECTION OF WOOD DECAY TO MEET THE REQUIREMENTS OF THE 2020 FLORIDA BUILDING CODE RESIDENTIAL  34. PROVIDE HANDICAP ACCESSIBILITY PER SECTION R-320 OF THE 2020 FLORIDA BUILDING CODE RESIDENTIAL.  35. THIS STRUCTURE MEETS THE REQUIREMENTS OF THE 2020 FLORIDA BUILDING CODE RESIDENTIAL  36. TERMITE TREATING AND PROTECTION TO MEET THE REQUIREMENT OF SECTION R-318 OF THE FBC.  37. FINISHED FLOOR TO MINIMUM 12" ABOVE CROWN OF ROAD.  38. FINISHED FLOOR TO MINIMUM 8" ABOVE GRADE.	SECOND FLOOR TOTAL AC AREA  GARAGE ENTRY PORCH LANAI FRONT BALCONY REAR BALCONY TOTAL OTHER AREAS	ALBA ENGINEERING  2.028 SF  3.798 SF  ORANDO, FL. 32854  (407) 421-4866  DANIEL SOUTER, P.E.  FL PE #63901  1.463 SF  5.261 SF	

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# Date	6/6/23			
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NEW HOME BY ZERO LATH UDE HOMES

HDEAWAY SPEC HOMES

7 - SOUTH HARBOR DR., VERO BEACH, F

MERIDIAN CUSTOM HOMES

DANIEL SOUTER, P.E.
P.E.# 63901
P.O. BOX 547774
ORLANDO, FL 32854
PHONE: (407) 421-4866

## meridian

Date	02-10-23
Project #	22-026
Drawn by	FVC
Checked by	JH/DS
Reviewed by Interior Design & Owner	YES





## THIS IS NOT A SURVEY

THIS IS NOT A SURVEY
SITE PLAN BASED ON
BOUNDARY SURVEY BASED
ON OCCUPATION AND
MONUMENTATION.

#### Site Plan Notes

This is not a survey. Zero Latitude Inc. assumes no responsibility for its accuracy. The Owner and Contractor are totally responsible for placing the building on the property.


Pool Design and location, if shown, are only suggested.

Landscaping design by others.

Zero Latitude Inc. assumes no responsibilty for septic design or location. Septic ,if shown, on plan is per builder or owner requirements. Septic systems are to be designed and located per Dept. of Health requirements or as per governing codes.

#### Site Plan

1/8"=1'-0"

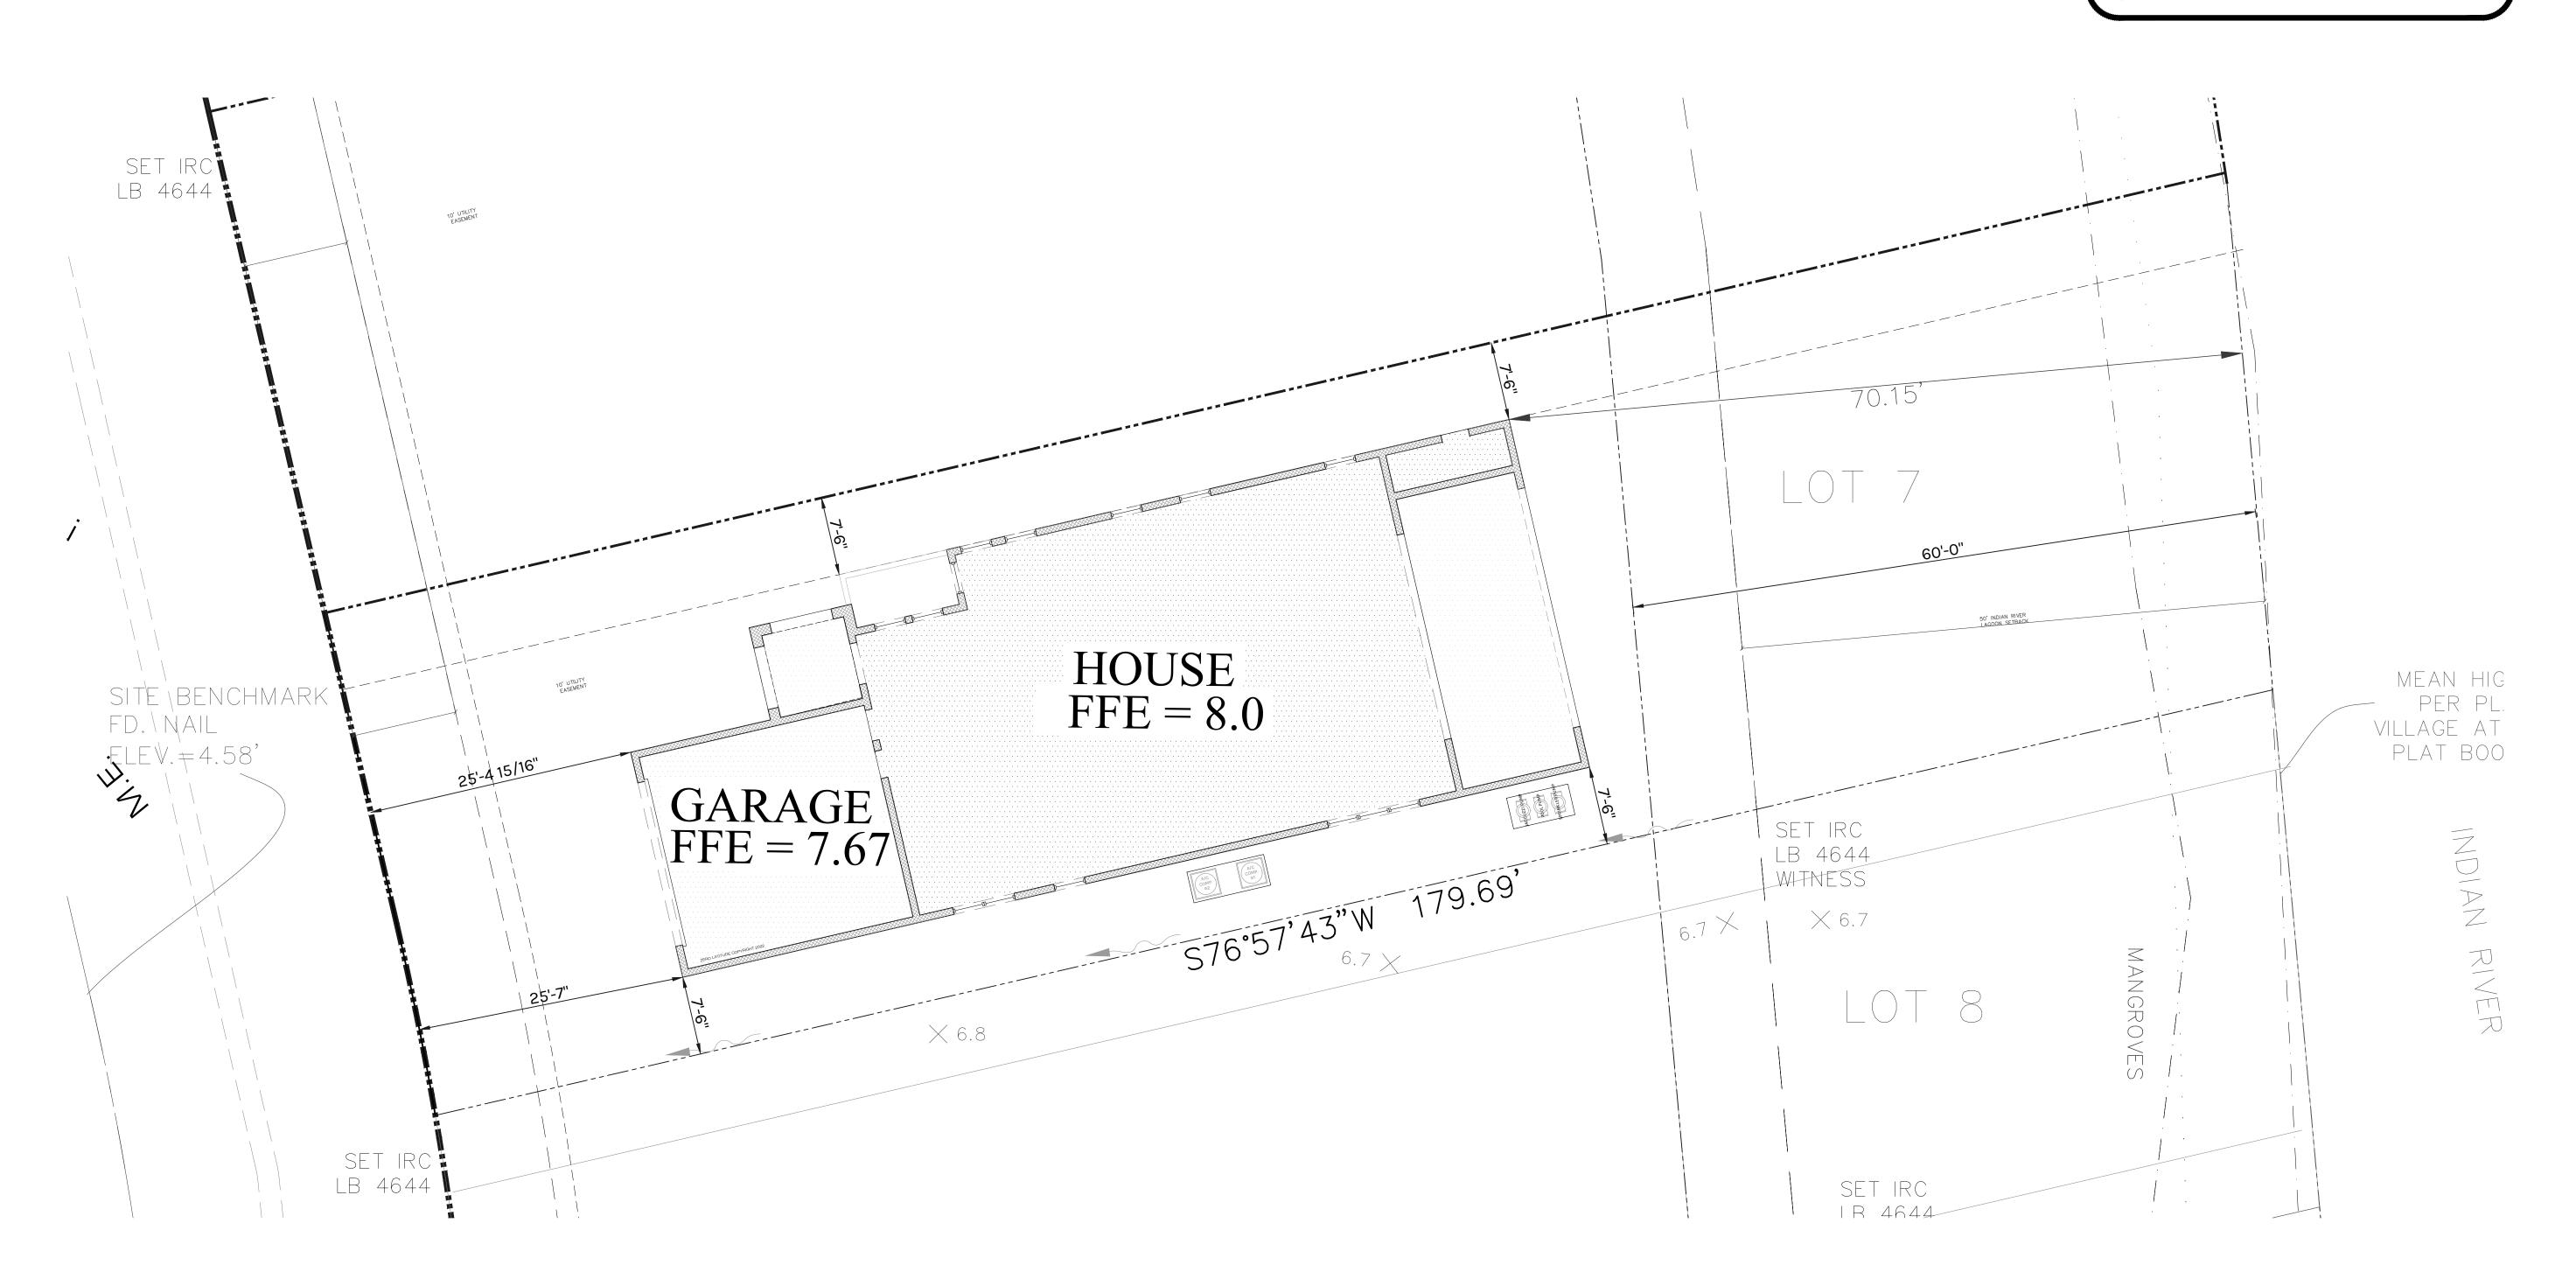

ARCH SITE PLAN

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THORRADED TO CONSTRUCT WITH THIS PLAN FOR ONLY ONE TIME. RELISE OR CHANGE OF THIS PROBLED.

I AND SECURISHS, ARE THE PROPERTY OF THIS OFFICE. AND WERE CREATED. EVOLVED, AND IN GONDALD TO WITH SEPCRETED PROBLET, INVOICE OF SUCH DELAS, DESIGNALS, ARAND IN CONNECTION WITH THE REPORTED THOUGH OF SUCH DELAS, DESIGNATION IN CHARMAN REPORTED. WHO CO SUCH DELAS, DESIGNATION TO ANY PERPOSE WHAT SOBE WITHOUT THE WRITTEN PERBOSIC ON TEACH OF A THIND.

INDUCE. WHITH DIO MENSIONS ON THESE DEPAYMINGS SHALL MAY PRECEDENCE

TITUDE. WHITH DIO MENSIONS ON THESE DEPAYMINGS SHOP DEFINITION FOR ANY VARIATIONS FROM A CONDITIONS SHOWN BY THESE DRAWINGS SHOP PETALLS OF ADEQUATES AND SEROBANTED.

INDUCEDING WITH DIO THIS OFFICE FOR A PROPOVALE BEFORE PROCEEDING WITH FABRICANTER.

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# Date	1 6/6/23			
Revisions	CITY COMMENTS			

HIDEAWAY SPEC HOMES

LOT 7 - SOUTH HARBOR DR., VERO BEACH, F

MERIDIAN CLISTOM HOMES



Date	)	02-10-23
Proje	ect#	22-026
Draw	n by	FVC
Chec	cked by	JH/DS
	wed by or Design ner	YES





#### 88'-8" 13'-8" 10'-0" 42'-9" 10'-0" 12'-2" OUTDOOR 22'-5" SHOWER PROVIDE RECESS FOR EXT. DOOR PER GC STEP DOWN TO GRADE ((wc | | • | PLANTER **OPENING** \_\_\_\_\_ G.C. TO VERIFY LOCATION **ELEVATOR PIT** OF FLOOR OUTLETS PRIOR FRONT PORCH ELEV -0'-4" A.F.F TO POURING OF SLAB PIT DEPTH PER MANUFACTURER'S PROVIDE RECESS SPECIFICATIONS FOR EXT. DOOR PER GC PANTRY SLOPE 1":10' 32'-7" STEP DOWN TO PORCH PROVIDE RECESS -FOR EXT. DOOR PER GC ELEVATOR PIT PER MANUFACTURER'S SPECIFICATION LANAI SLAB ELEV -0'-4" A.F.F. MAIN FIN. FLR. ELEV -0'-0" A.F.F. ALL PLUMBING DIMENSIONS ARE APPROXIMATE, G.C. TO VERIFY ALL APPLIANCE LOCATIONS INSTALLED PER MANUFACTURER SPECIFICATIONS. 4" CONCRETE SLAB , SEE GENERAL ELECT. PANEL CONTRACTOR TO VERIFY LOCATION GARAGE SLAB ELEV -0'-4" A.F.F. STRUCTURAL NOTES. OF REFRIGERATION LINES PRIOR TO INSTALLATION PER APPLIANCES 5'-11" 13'-3" SLOPE 1":10' CHOSEN BY OWNER PROVIDE RECESS 13'-5" 5'-6" FOR EXT. DOOR PER GC SHOWER UNDER COUNTER LOW WALL SLOPE 1":10' XHEAD ZERO ENTRY LOCATION OF SUMMER KITCHEN SINK W/ LINES PRIOR TO INSTALLATION 4" CONCRETE SLAB, SEE GENERAL DISPOSAL PER APPLIANCES CHOSEN BY STRUCTURAL NOTES. GAS CONNECTION FOR COOKTOP (LAV) | • ---POT-FILLER ZERO LATITUDE COPYRIGHT 2022 • GC TO VERIFY CONCRETE PAD LOCATION & INSTA-HOT HOSE METER WALL SPACING PER NEC 2017 & LOCAL CODES WATER HEATER PROVIDE (2) 4" CONCRETE MECHANICAL PADS, PROVIDE PROVIDE SIZE OF PADE DETERMINED BY G.C. PER CONTRACTOR TO VERIFY LOCATION OF POOL EQUIPMENT WATER CCONNECTIONS LOCATION OF A/C CONDENSER DRAIN PROVIDE 4" CONCRETE POOL EQUIPMWNT PAD SIZE OF PAD MANUFACTURER SPECIFICATIONS 22'-8" 53'-9" 12'-3" 88'-8"

#### **TERMITE NOTES:**

R-318 TERMITE PROTECTION SHALL BE PROVIDED BY REGISTERED TERMTICIDES, INCLUDING SOIL APPLIED PESTICIDES, BAITING SYSTEMS, AND PESTICIDES INCLUDING SOIL APPLIED PESTICIDES, BAITING SYSTEMS, AND PESTICIDES APPLIED TO WOOD, OR OTHER APPROVED METHODS OF TERMITE PROTECTION LABELED FOR USE AS A PREVENTATIVE TREATMENT TO NEW CONSTRUCTION (SEE SECTION 202, REGISTERED TERMITICIDE). UPON COMPLETION OF THE APPLICATION OF THE TERMITE PROTECTION TREATMENT, A CERTIFICATE OF COMPLIANCE SHALL BE ISSUED TO THE BUILDING DEPARTMENT BY THE LICENSED PEST CONTROL COMPANY THAT CONTAINS THE FOLLOWING STATEMENT: "THE BUILDING HAS RECEIVED A COMPLETE TREATMENT FOR THE PREVENTION OF SUBTERRANEAN TERMITES. TREATMENT IS IN ACCORDANCE WITH RULES AND LAWS ESTABLISHED BY FLORIDA DEPARTMENT OF AGRICULTURE AND CONSUMER SERVICES."

METHODS.

#### SOIL TREATMENTS FOR SUBTERRANEAN TERMITES.

BACKFILLING, AND COMPACTION IS COMPLETE.

#### DISTURBED SOIL TREATMENT MUST BE RETREATED.

TREATMENT AROUND EXTERIOR OF FOUNDATION SHALL BE DONE AFTER REMOVAL OF CONCRETE OVER POURS OR ACCUMULATED MORTAR.

PROTECTIVE SLEEVES AROUND METALLIC PIPING PENETRATING CONCRETE SLAB-ON-SLAB GRADE FLOORS SHALL NOT BE CELLULOSE-CONTAINING MATERIALS AND RECEIVE AN APPLICATION OF TERMITICIDE IN ANNULAR SPACE BETWEEN SLEEVE AND PIPE.

USE REGISTERED TERMITICIDES OR OTHER APPROVED

PROTECTION TO BE DONE AFTER ALL EXCAVATION,

TREATMENT SHALL BE PROTECTED FROM RAINFALL BY 6 MIL VAPOR BARRIER. IF RAINFALL OCCURS BEFORE BARRIER PLACEMENT, SOIL MUST BE RETREATED.

TREATMENT APPLIED UNDER ALL EXTERIOR CONCRETE OR GRADE WITHIN 1 FOOT OF PRIMARY STRUCTURE SIDEWALLS. VERTICAL CHEMICAL BARRIER SHALL BE APPLIED PROMPTLY AFTER CONSTRUCTION COMPLETION (INCLUDING LANDSCAPING AND IRRIGATION/SPRINKLER INSTALLATION.)

ALL BUILDINGS SHALL HAVE PRE-CONSTRUCTION TREATMENT PER RULES AND LAWS ESTABLISHED FLORIDA DEPARTMENT OF AGRICULTURE AND CONSUMER SERVICES.

#### PLUMBING NOTES

1. REFER TO PLANS FOR SCHEDULES OF EQUIPMENT AND FIXTURES. AMERICAN STANDARD, KOHLER AND CRANE ARE CONSIDERED ACCEPTABLE AS EQUALS.

2. MAINTAIN A MINIMUM CLEARANCE OF 6" BETWEEN PLUMBING PIPING AND EQUIPMENT AND ALL FIRE/SMOKE RATED WALLS.

3. INSTALL EQUIPMENT IN ACCORDANCE WITH MANUFACTURER'S WRITTEN INSTRUCTIONS. INSTALL UNITS LEVEL AND PLUMB, FIRMLY ANCHORED IN LOCATIONS INDICATED. MAINTAIN MANUFACTURER'S CLEARANCES. SUPPORT ALL EQUIPMENT AS REQUIRED TO PROVIDE A RIGID, VIBRATION FREE INSTALLATION.

4. POTABLE WATER PIPING SHALL BE AS FOLLOWS: A. BELOW GRADE: TYPE 'K', ANNEALED TYPE TEMPERED COPPER TUBE FOR PIPE SIZES 2 INCHES AND SMALLER. BRAZE ALL JOINTS. B. ALL OTHER: TYPE 'L' DRAWN COPPER TUBE WITH WROUGHT COPPER FITTINGS AND 95-5

5. PIPING OF DISSIMILAR METALS SHALL BE DI-ELECTRICALLY SEPARATED.

TIN-ANTIMONY SOLDER.

6. FIELD VERIFY EXACT CONNECTION POINTS PRIOR TO SUBMITTING BID AND NOTIFY ENGINEER IF CONDITIONS ARE NOT AS SHOWN ON THE PLANS OR AS STATED IN THE SPECIFICATIONS. CONTRACTOR SHALL VERIFY THE OPERABILITY OF ENTIRE SYSTEM PRIOR TO TIE-IN AS FOLLOWS:

A. SNAKE SANITARY FOR A DISTANCE OF 100 FEET AND REPORT ANY BLOCKAGE. B. TEST WATER PRESSURE TO INSURE MINIMUM MOST DEMANDING EQUIPMENT PSI MATCHES SUPPLIED.

7. INSULATE ALL HOT AND COLD WATER PIPING WITH 1" THICK (K=0.23 @ 75°F) FIBERGLASS PIPE INSULATION WITH AN ALL SERVICE JACKET TO MEET LOCAL CODES AND UL FLAME SPREAD AND SMOKE DEVELOPED RATING. INSTALL PER MANUFACTURER'S RECOMMENDATIONS.

8. INSULATE THE TRAP, SANITARY AND SUPPLY PIPES UNDER LAVATORIES WITH TRUEBRO MODEL 102W "HANDI LAV GUARD" INSULATION KIT OR EQUAL.

9. INSTALL ALL NECESSARY PIPE HANGERS, SADDLES, AND CARRIERS TO PROPERLY SUPPORT ALL PIPING AND FIXTURES. HANGERS SHALL SUIT TYPE OF PIPING PROVIDED AND BE SPACED AT A MAXIMUM SPAN OF 5 FEET.

10. STERILIZE WATER SYSTEM IN ACCORDANCE WITH LOCAL CODES.

11. TEST ENTIRE PLUMBING SYSTEM IN ACCORDANCE WITH 2020 FLORIDA PLUMBING CODE.

12. PROVIDE WATER METER AND REMOTE READER PER LOCAL UTILITIES REQUIREMENT, IF APPLICABLE.

13. CONDENSATE DRAIN: PROVIDE POLYVINYL CHLORINE (PVC) SCHEDULE 40 PLASTIC PIPE (TYPE (DWV) IN CONFORMANCE WITH STANDARD ASTM

14. VALVES: PROVIDE BALL VALVE NIBCO SERIES 585-70 FOR SHUT-OFF

15. PROVIDE ACCESS PANELS WHERE REQUIRED FOR OPERATION, MAINTENANCE AND BALANCING OR PLUMBING EQUIPMENT.

16. PROVIDE WATER HAMMER ARRESTORS AT EACH BRANCH LINE

#### **GAS LINES**

1. FURNISH AND INSTALL A COMPLETE GAS PIPING SYSTEM.

2. GAS LINES SHALL BE BLACK STEEL, SCHEDULE 40, ASTM A-53, WITH MALLEABLE THREADED FITTINGS FOR 2" AND SMALLER, AND WITH WELDED JOINTS FOR 2-1/2" AND LARGER.

3. FURNISH AND INSTALL A GAS COCK, DIRT LEG, AND UNION CONNECTION AT EACH PIECE OF EQUIPMENT.

4. PITCH PIPING AT A UNIFORM GRADE OF 1/4" IN 15 FEET UPWARD IN DIRECTION OF FLOW. SUPPORT PIPING EVERY 5 FEET, AS DETAILED ON DRAWINGS, OR BY STANDARD INDUSTRY PRACTICE, WHICHEVER IS MORE STRINGENT.

5. GAS PIPING EXPOSED ON ROOF SHALL BE PAINTED WITH RUST-INHIBITING PAINT.

6. GAS PIPING INSTALLED IN RETURN AIR PLENUMS SHALL BE SLEEVED AND VENTED OR WELDED IN ACCORDANCE WITH THE LOCAL GAS COMPANY, LOCAL CODE AND APPLICABLE NFPA 54 CODES.

7. TESTING AND PURGING OF GAS PIPING SHALL BE DONE PER THE REQUIREMENTS OF THE LOCAL GAS COMPANY, LOCAL CODES AND APPLICABLE NFPA

8. CONTACT AND COORDINATE GAS SERVICE, METER AND REGULATOR REQUIREMENTS WITH THE LOCAL GAS COMPANY PRIOR TO BID. INCLUDE INSTALLATION COST OF GAS METER AND REGULATOR IN BID.

#### **GAS WATER HEATER**

**CLEARANCES REQUIRED:** 

1. GREATER THAN 4'-0" FROM AN OPENING, OPERABLE WINDOW, DOOR AND FRESH AIR OPENING OR ADJACENT WALL.

2. 5'-0" FROM A NATURAL GAS METER OR REGULATOR.

# Date	1 6/6/23			
Revisions	CITY COMMENTS			



DANIEL SOUTER, P.E.

P.E.# 63901

P.O. BOX 547774

Date	02-10-23
Project #	22-026
Drawn by	FVC
Checked by	JH/DS
Reviewed by Interior Desigr & Owner	n YES






#### EGRESS WINDOWS

MEAN OF ESCAPE NOTE (EGRESS):

ALL EGRESS WINDOWS TO COMPLY W/F.B.C. R 310.1. AN OUTSIDE WINDOW OR DOOR OPERABLE FROM THE INSIDE WITHOUT THE USE OF TOOLS AND PROVIDING A CLEAR OPENING OF NOT LESS THAN 20" WIDE X 24" HIGH AND 5.7 SF IN AREA. THE BOTTOM OF THE OPENING SHALL NOT BE MORE THAN 44" OF THE FLOOR, THE MODE OF OPERATION MUST NOT REQUIRE THE USE OF A KEY, TOOL OR SPECIAL KNOWLEDGE OR EFFORT TO MAKE AVAILABLE THE REQUIRED CLEAR OPENING, AND NO PART OF THE OPERATION MECHANISM SHALL BE PLACED HIGHER THAN 54" ABOVE THE FINISHED FLOOR.

EVERY CLOSET DOOR LATCH SHALL BE SUCH THAT CHILDREN CAN OPEN THE DOOR FROM INSIDE THE CLOSET, EVERY BATHROOM DOOR SHALL BE DESIGNED TO ALLOW OPENING FROM THE OUTSIDE ENSURING AN EMERGENCY WHEN LOCKED.

- 1. DOOR BETWEEN GARAGE AND LIVING AREA OF HOUSE TO BE MINIMUM 20 MINUTE SOLID CORE DOOR WITH SELF CLOSING MECHANISM.
- 2. WALL BETWEEN GARAGE AND LIVING AREA OF HOUSE TO HAVE 1/2" FINISHED DRYWALL MINIMUM IF WALL IS NOT SOLID BLOCK.
- 3. GARAGE CEILING TO BE 1/2" FINISHED DRYWALL MINIMUM AND 5/8" TYPE X DRYWALL IF THERE IS LIVING SPACE ABOVE THE GARAGE.
- 4. ENCLOSED SPACE UNDER STAIRS THAT IS ACCESSED BY A DOOR OR ACCESS PANEL SHALL HAVE WALLS, UNDER-STAIR SURFACE AND ANY SOFFITS PROTECTED ON THE ENCLOSED SIDE WITH 1/2" INCH GYPSUM BOARD. (FBCR-R302.7)
- 5. ATTIC ACCESS, MINIMUM 30"x22" OPENING. PROVIDE (1) OUTLET, SWITCH AND LIGHT IN ATTIC AT PULL-DOWN STAIRS.
- 6. PULL DOWN ATTIC ACCESS LADDER, MINIMUM 54"x22" OPENING.
- 7. AT SECOND FLOOR BALCONIES: FLOORING TO BE TILES OVER PLI-DEK WATERPROOF SYSTEM. CONTRACTOR OPTION WITH OWNER APPROVAL TO USE DUROCK OVER 60 MIL. WATERPROOF MEMBRANE OVER 30# FELT OVER 3/4" PLYWOOD W/ FLASHING (TYP.)
- 8. CONTRACTOR AND/OR STAIR MANUFACTURER TO VERIFY ALL STAIR HEIGHTS, RISER HEIGHTS AND TREAD DEPTHS TO ENSURE THE CORRECT DIMENSIONS WERE PROVIDED.
- 9. CONTRACTOR TO VERIFY ALL WINDOW AND DOOR SIZES PRIOR TO ORDERING TO ENSURE ELEVATIONS PORTRAY THE CORRECT WINDOW AND DOOR HEIGHTS.
- 10. ALL RAILINGS ABOVE 24" A.F.F. SHALL BE 42 INCH HIGH GUARDRAILS UNLESS OTHERWISE SPECIFIED.
- 11. ALL SHOWERS TO BE 4 INCH RECESSED, WHERE APPLICABLE, IN FIRST FLOOR SLAB AND IN TRUSSES AT ALL OTHER FLOORS.
- 12. ALL TRAY CEILINGS TO BE 8 INCHES DEEP UNLESS OTHERWISE NOTED ON DRAWINGS.

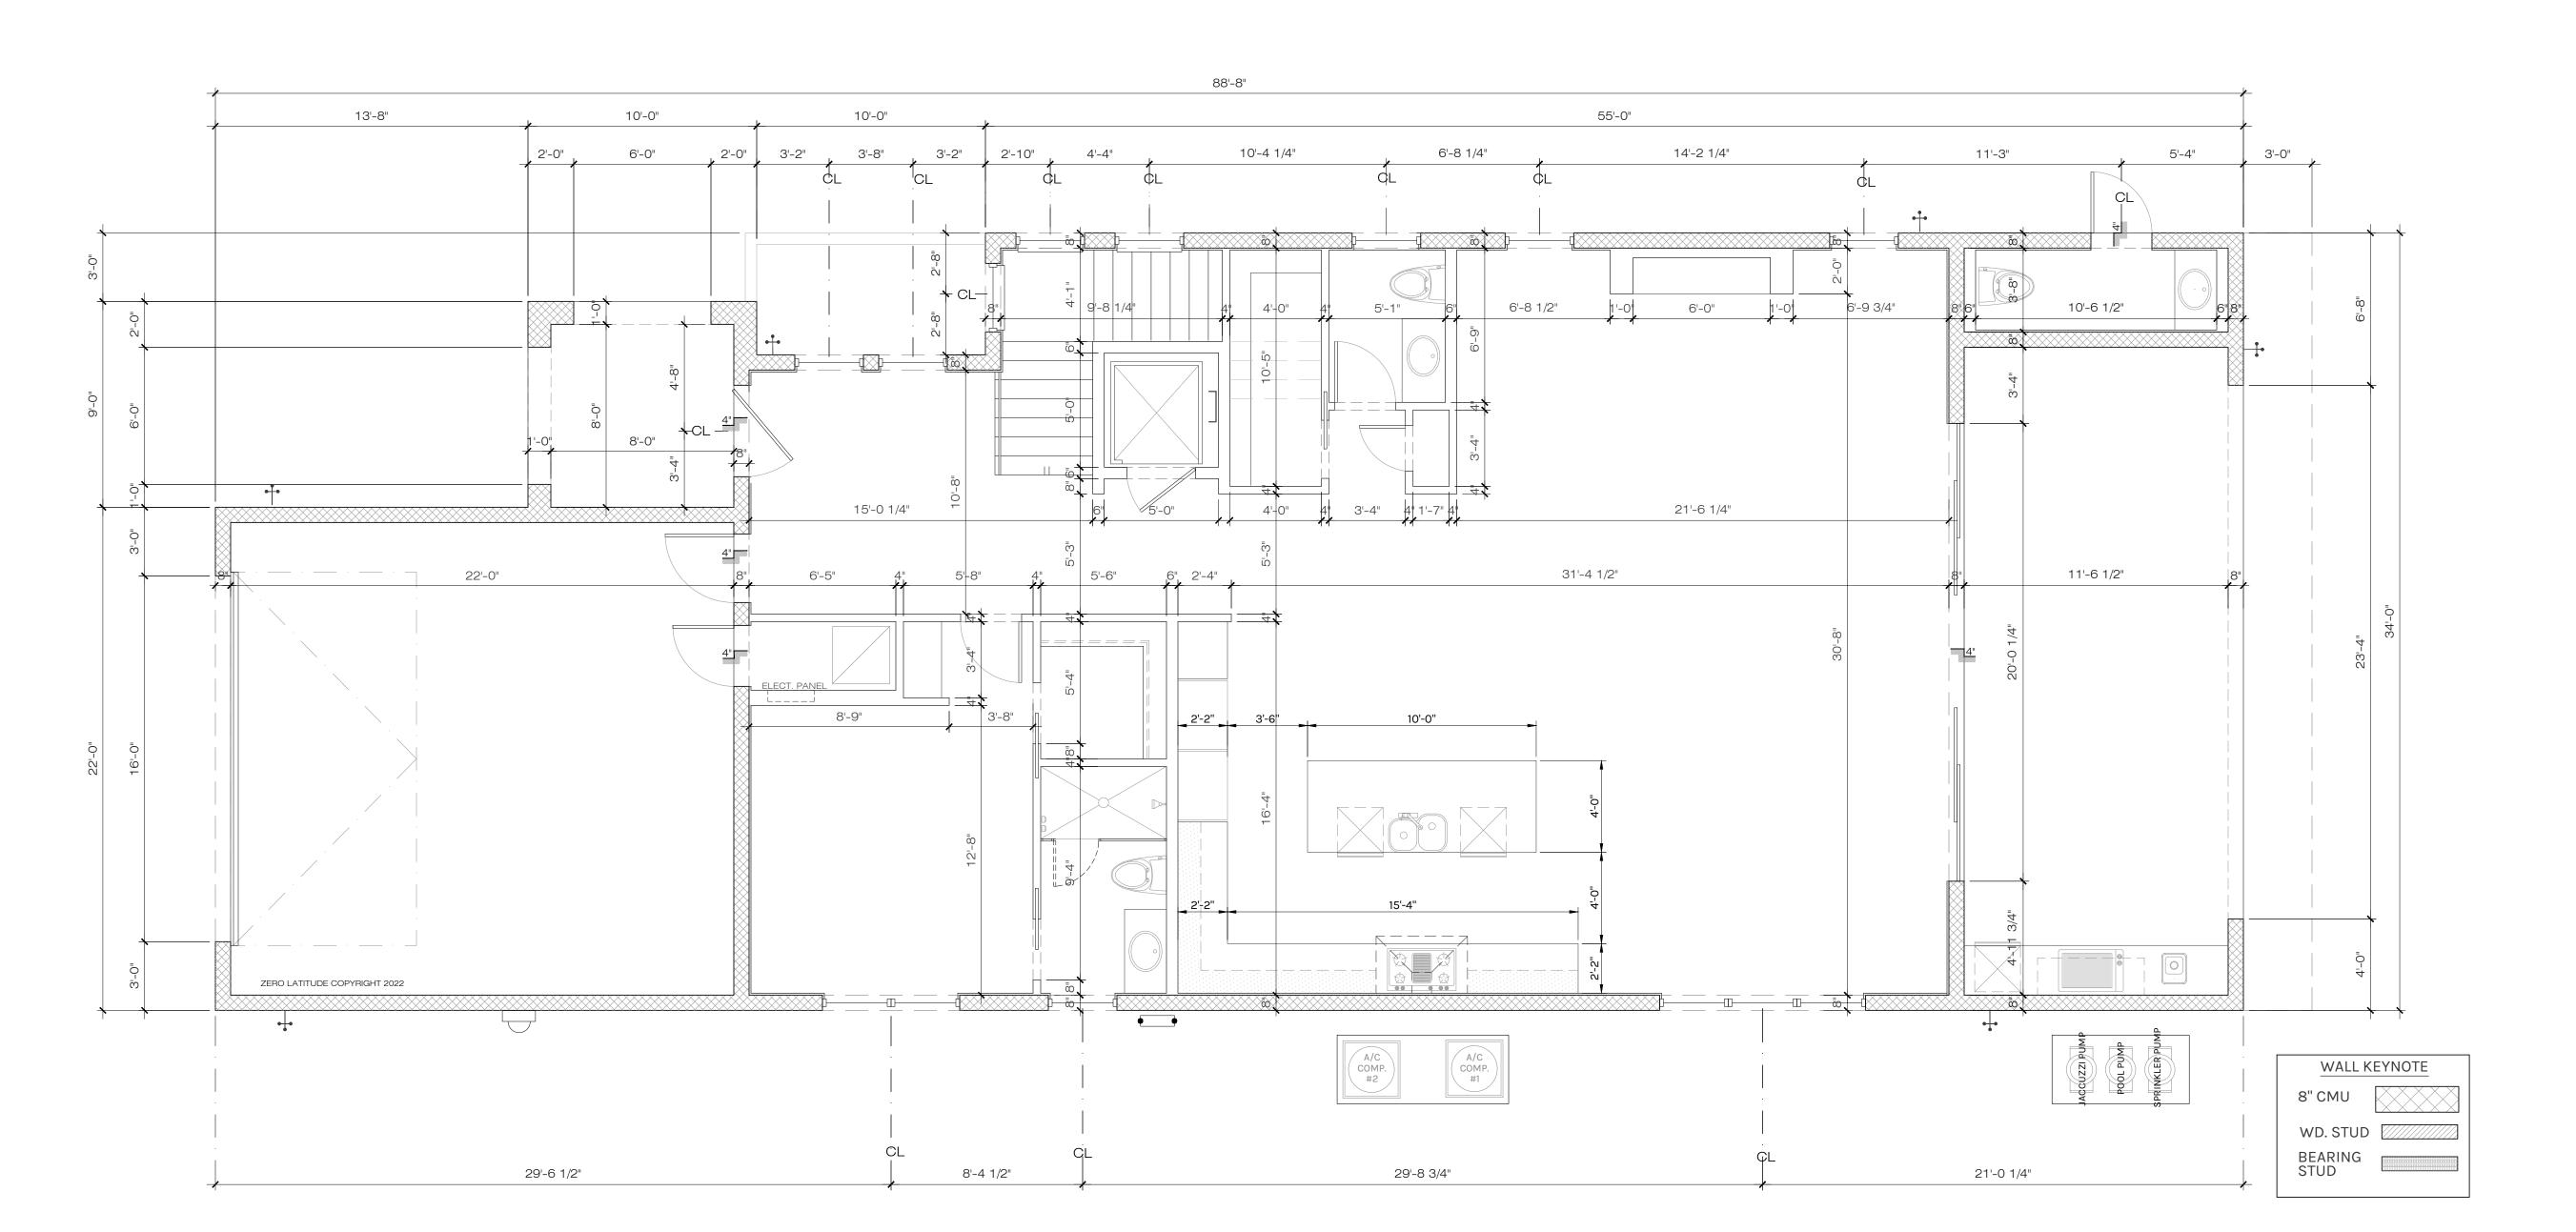

DIM 1ST FLOOR PLAN A4 SCALE: 1/4" = 1'-0"


FLOOR PLAN NOTES



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	Date	02-10-23
	Project #	22-026
	Drawn by	FVC
	Checked by	JH/DS
	Reviewed by Interior Design & Owner	YES






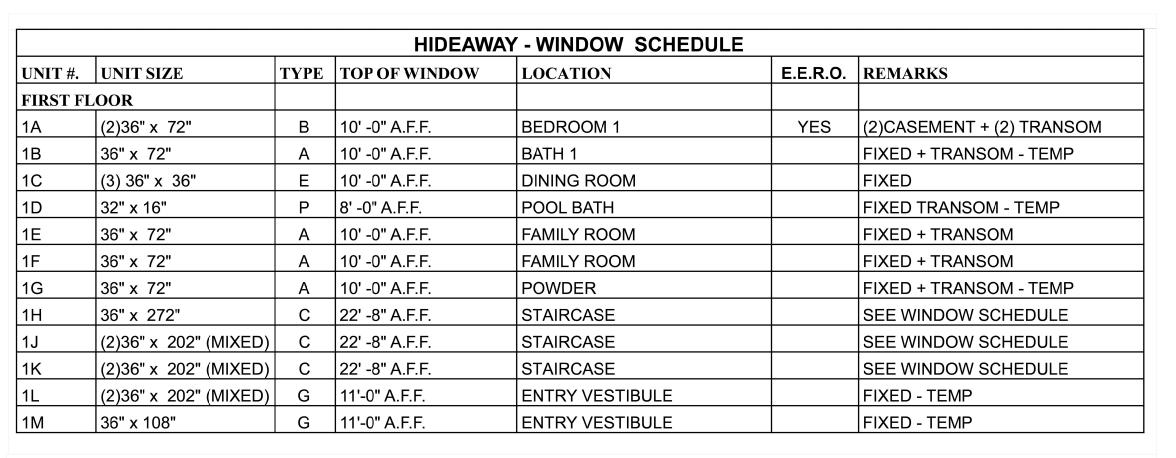

				HIDEAWAY -	DOOR SCHEE	ULE		
UNIT #.	WIDTH	HEIGHT	THKS.	MATERIALS		DOOR	LOCATION	NOTES
				DOOR	FRAME	TYPE		
FIRST FI	LOOR							
1	4'-0"	10'-0"	1 1/2"	WOOD/GLASS	WOOD	В	ENTRY DOOR	EXTERIOR GRADE PIVOT DOOR
2	9'-0"	9'-0"	1 1/2"	WOOD	WOOD	Α	GARAGE	OVERHEAD GARAGE DOOR
3	2'-8"	8'-0"	1 1/2"	SC	WOOD	С	GARAGE - MECH	
4	3'-0"	8'-0"	1 1/2"	SC	WOOD	С	GARAGE - ENTRY HOUSE	
5	2'-8"	8'-0"	1 1/2"	SC	WOOD	С	BEDROOM 1 - ENTRY	
6	2'-8"	8'-0"	1 1/2"	SC	WOOD	D	BEDROOM 1 - WIC	POCKET DOOR
7	2'-8"	8'-0"	1 1/2"	SC	WOOD	D	BATH 1 - ENTRY	POCKET DOOR
8	3'-0"	8'-0"	1 1/2"	SC	WOOD	С	ELEVATOR - ENTRY	ELEVATOR MANUF. SPECS
9	2'-0"	8'-0"	1 1/2"	SC	WOOD	С	LINEN	
10	2'-8"	8'-0"	1 1/2"	SC	WOOD	D	PANTRY - UNDER STAIRS	POCKET
11	2'-8"	8'-0"	1 1/2"	SC	WOOD	С	POWDER - ENTRY	
12	(4)4'-0"	10'-0"	1 1/2"	ALUMINUM/GLASS	ALUMINIUM	J	LIVING ROOM - LANAI	CENTER SGD - TEMP
13	2'-8"	8'-0"	1 1/2"	SC	WOOD	С	POOL BATH	EXTERIOR GRADE


WINDOW HEIGHT ELEV @ 9'-0" A.F.F. WINDOW HEIGHT ELEV @ 8'-0" A.F.F.	021 CZ ZZ FIXED	72 36 36 36"**24" 36"**24" TRANSOM  36"**22" 36"**72" FIXED  CU	98	36 36" * 36" * 36" * 90 * 00 * 00 * 00 * 00 * 00 * 00 * 0	108  36 36 36  36"*36" FIXED F	26 EERO 36 AZ	24 1 08 1 108 36 36 1 108 1 108	72 36 36 36" × 72" FIXED EERO EERO	36 36" × 72" FIXED	48 48" × 24" FIXED TEMP	84 84 15Mb 15Mb 15Mb 15Mb 16Mb 16Mb 17Mb 184 185 185 185 185 185 185 185 185 185 185	72 72" × 48" FIXED TEMP	408 44 84 84 84 84 84 84 84 84 84 84 84 84	92"×16" FIXED TEMP
ELEV @ 0'-0" A.F.F.	TYPE A FIXED MULLIONS	TYPE-B GASEMENT + TRANSOM (DOUBLE) MULLIONS MULLED UNIT	TYPE-C FIXED 3-WINDOW PATTERN MULLIONS	TYPE-D FIXED—TEMP MULLIONS	TYPE-E FIXED—TEMP MULLIONS MULLED UNIT	TYPE-F GASEMENT MULLIONS MULLED UNIT	TYPE-G FIXED MULLED MULLIONS	TYPE H  CASEMENT (DOUBLE)  MULLIONS  MULLED UNIT  EERO	TYPE J CASEMENT EGRESS MULLIONS	TYPE-K FIXED TEMPERED	TYPE-L FIXED TEMPERED	TYPE-M FIXED TEMPERED	<del>TYPE N</del> FIXED MULLIONS	TYPE P FIXED TRANSOM MULLIONS
	WINDOV	V ELEVATIONS	1: FOR EXACT SILL HEIGHT ABO PLANS ONLY SHOW ALPHAB WINDOW INFORMATION:	OVE FINISHED FLOOR (A.F.F.), SEE E ETICAL NOTATION. SEE WINDOW S	LEVATIONS. FLOOR CHEDULE FOR FULL									

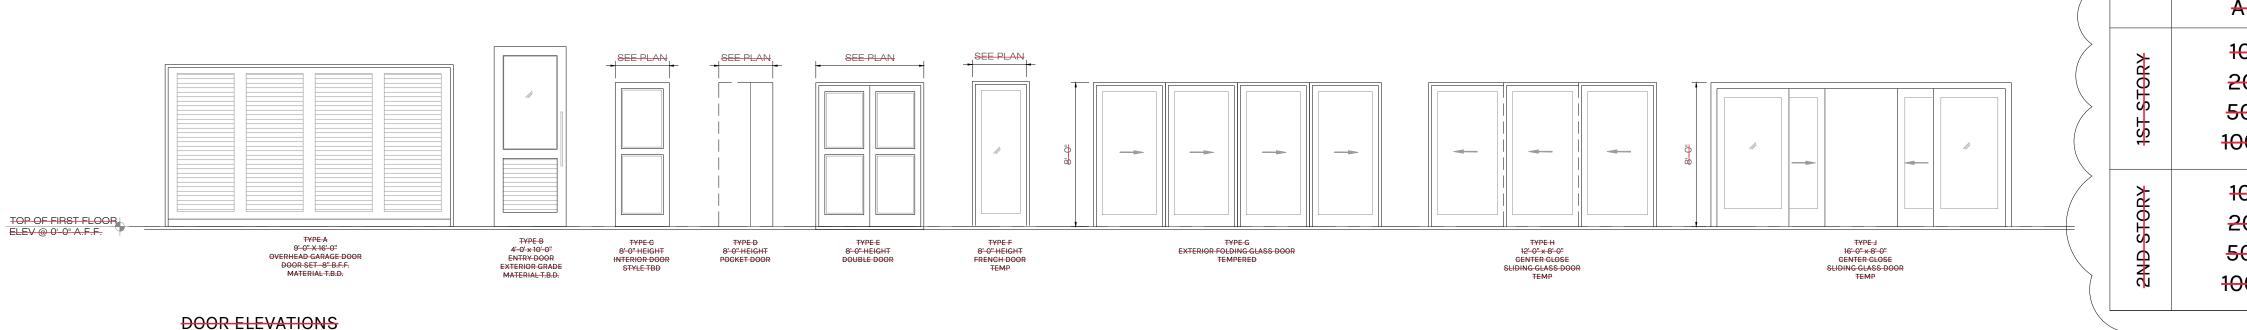


2. ALL WINDOWS THAT HAVE A SILL LOWER THAN 24 INCHES A.F.F. WILL HAVE TEMPERED

(MIAMI-DADE COUNTY) AND LOCAL ORDINANCES FOR HURRICANE REQUIREMENTS.

3. ALL WINDOWS/GLASS SHALL MEET OR EXCEED THE FLORIDA BUILDING CODE

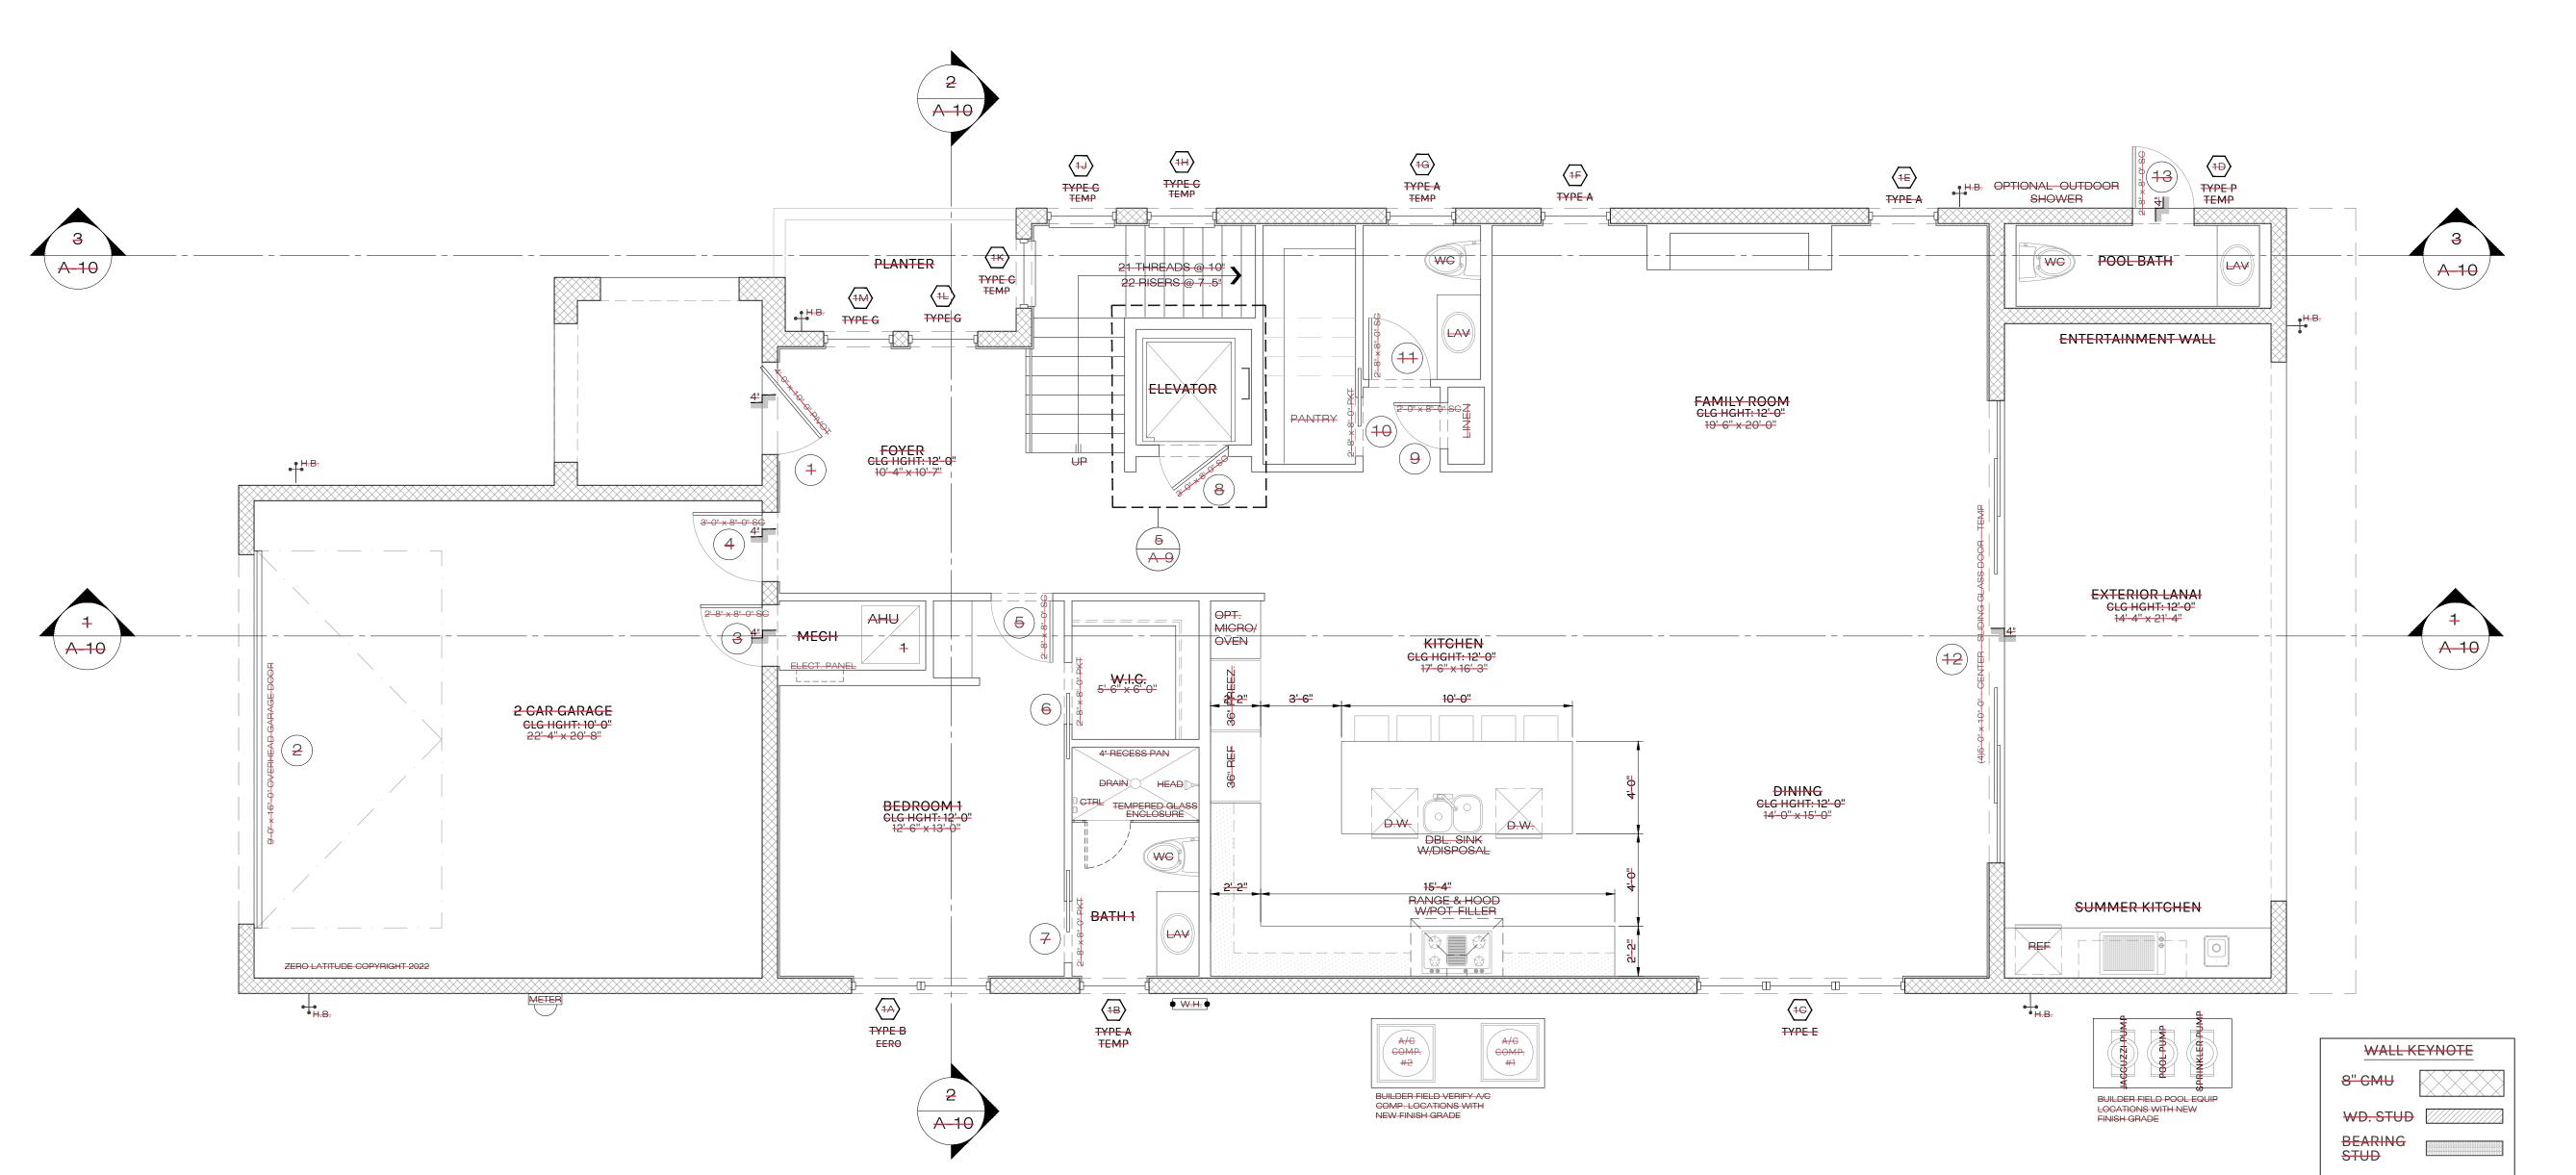



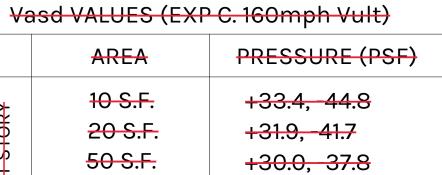

**COMPONENTS AND CLADDING** 

WINDOW AND DOOR
WIND PRESSURE SCHEDULE

100 S.F. +28.4, 34.7 10 S.F. +35.6, 47.7 20 S.F. +34.1, 44.5 50 S.F. +32.0, 40.2 100 S.F. +30.3, 37.0

#### FLOOR PLAN NOTES

- 1. DOOR BETWEEN GARAGE AND LIVING AREA OF HOUSE TO BE MINIMUM 20 MINUTE SOLID CORE DOOR WITH SELF CLOSING MECHANISM.
- 2. WALL BETWEEN GARAGE AND LIVING AREA OF HOUSE TO HAVE 1/2" FINISHED DRYWALL MINIMUM IF WALL IS NOT SOLID BLOCK.
- 3. GARAGE CEILING TO BE 1/2" FINISHED DRYWALL MINIMUM AND 5/8" TYPE X DRYWALL IF THERE IS LIVING SPACE ABOVE THE GARAGE.
- 4. ENCLOSED SPACE UNDER STAIRS THAT IS
  ACCESSED BY A DOOR OR ACCESS PANEL SHALL
  HAVE WALLS, UNDER STAIR SURFACE AND ANY
  SOFFITS PROTECTED ON THE ENCLOSED SIDE
  WITH 1/2" INCH GYPSUM BOARD. (FBCR-R302.7)
- 5. ATTIC ACCESS, MINIMUM 30"x22" OPENING.
  PROVIDE (1) OUTLET, SWITCH AND LIGHT IN ATTIC
  AT PULL DOWN STAIRS.
- 6. PULL DOWN ATTIC ACCESS LADDER, MINIMUM 54"x22" OPENING.
- 7. AT SECOND FLOOR BALCONIES: FLOORING TO BE TILES OVER PLI-DEK WATERPROOF SYSTEM.
  CONTRACTOR OPTION WITH OWNER APPROVAL TO USE DUROCK OVER 60 MIL. WATERPROOF MEMBRANE OVER 30# FELT OVER 3/4" PLYWOOD W/ FLASHING (TYP.)
- 8. CONTRACTOR AND/OR STAIR MANUFACTURER TO VERIFY ALL STAIR HEIGHTS, RISER HEIGHTS AND TREAD DEPTHS TO ENSURE THE CORRECT
- 9: CONTRACTOR TO VERIFY ALL WINDOW AND DOOR SIZES PRIOR TO ORDERING TO ENSURE ELEVATIONS PORTRAY THE CORRECT WINDOW AND DOOR HEIGHTS.

**DIMENSIONS WERE PROVIDED.** 

- 10. ALL RAILINGS ABOVE 24" A.F.F. SHALL BE 42 INCH HIGH GUARDRAILS UNLESS OTHERWISE SPECIFIED:
- 11. ALL SHOWERS TO BE 4 INCH RECESSED, WHERE APPLICABLE, IN FIRST FLOOR SLAB AND IN
- 12. ALL TRAY CEILINGS TO BE 8 INCHES DEEP UNLESS OTHERWISE NOTED ON DRAWINGS.

#### EGRESS WINDOWS

TRUSSES AT ALL OTHER FLOORS.

#### MEAN OF ESCAPE NOTE (EGRESS):

ALL EGRESS WINDOWS TO COMPLY W/F.B.C. R 310.1. AN OUTSIDE WINDOW OR DOOR OPERABLE FROM THE INSIDE WITHOUT THE USE OF TOOLS AND PROVIDING A CLEAR OPENING OF NOT LESS THAN 20" WIDE X 24" HIGH AND 5.7 SF IN AREA. THE BOTTOM OF THE OPENING SHALL NOT BE MORE THAN 44" OF THE FLOOR, THE MODE OF OPERATION MUST NOT REQUIRE THE USE OF A KEY, TOOL OR SPECIAL KNOWLEDGE OR EFFORT TO MAKE AVAILABLE THE REQUIRED CLEAR OPENING, AND NO PART OF THE OPERATION MECHANISM SHALL BE PLACED HIGHER THAN 54" ABOVE THE FINISHED FLOOR.

EVERY CLOSET DOOR LATCH SHALL BE SUCH THAT CHILDREN CAN OPEN THE DOOR FROM INSIDE THE CLOSET, EVERY BATHROOM DOOR SHALL BE DESIGNED TO ALLOW OPENING FROM THE OUTSIDE ENSURING AN EMERGENCY WHEN LOCKED.



# Date	+ 6/6/23			
Revisions	CITY COMMENTS			

HIDEAWAY SPEC LATITUDE HOMES
HIDEAWAY SPEC HOME
LOT 7 SOUTH HARBOR DR., VERO BEACH, F


DANIEL SOUTER, P.E. P.E.# 63901 P.O. BOX 547774 ORLANDO, FL 32854

### meridian

PHONE: (407) 421-4866

_		
	<del>Date</del>	02-10-23
	Project #	22-026
	<del>Drawn by</del>	FVC
	Checked by	JH/DS
	Reviewed by Interior Design & Owner	YES



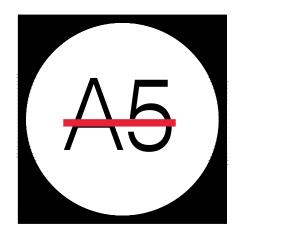




#### EGRESS WINDOWS

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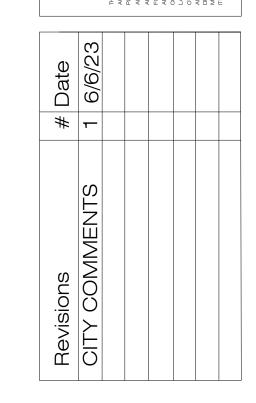
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- DOOR WITH SELF CLOSING MECHANISM. 2. WALL BETWEEN GARAGE AND LIVING AREA OF
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- 7. AT SECOND FLOOR BALCONIES: FLOORING TO BE TILES OVER PLI-DEK WATERPROOF SYSTEM. CONTRACTOR OPTION WITH OWNER APPROVAL TO USE DUROCK OVER 60 MIL. WATERPROOF MEMBRANE OVER 30# FELT OVER 3/4" PLYWOOD W/ FLASHING (TYP.)
- 8. CONTRACTOR AND/OR STAIR MANUFACTURER TO VERIFY ALL STAIR HEIGHTS, RISER HEIGHTS AND TREAD DEPTHS TO ENSURE THE CORRECT DIMENSIONS WERE PROVIDED.
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- 12. ALL TRAY CEILINGS TO BE 8 INCHES DEEP UNLESS OTHERWISE NOTED ON DRAWINGS.



1 DIM 2ND FLOOR PLAN
A6 SCALE: 1/4" = 1'-0"

FLOOR PLAN NOTES HOUSE TO BE MINIMUM 20 MINUTE SOLID CORE

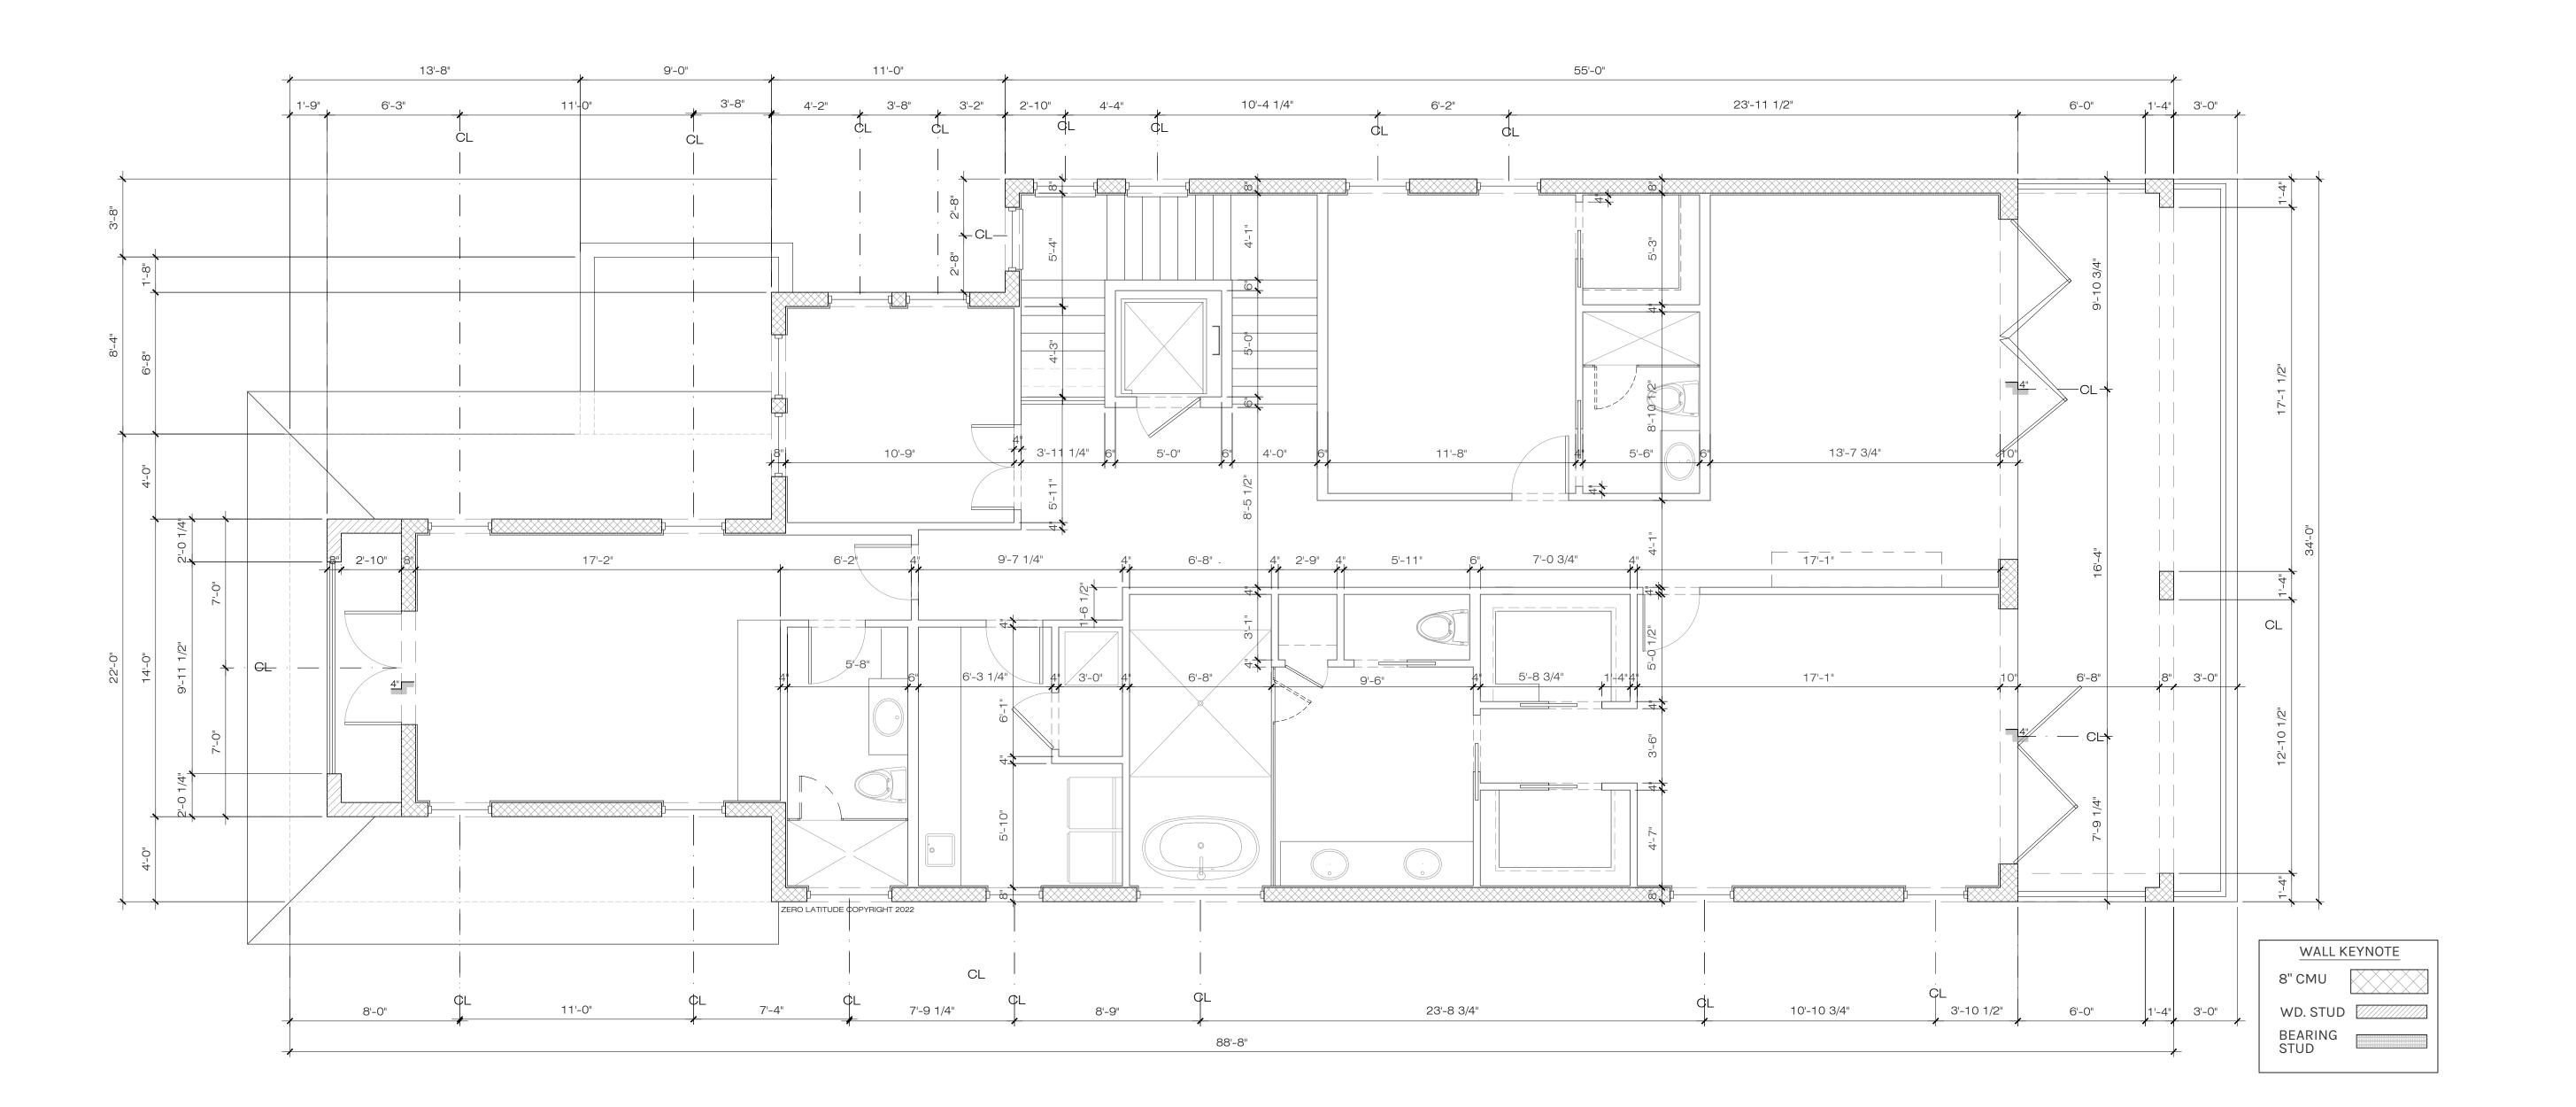




Date	02-10-23
Project #	22-026
Drawn by	FVC
Checked by	JH/DS
Reviewed by Interior Design & Owner	YES





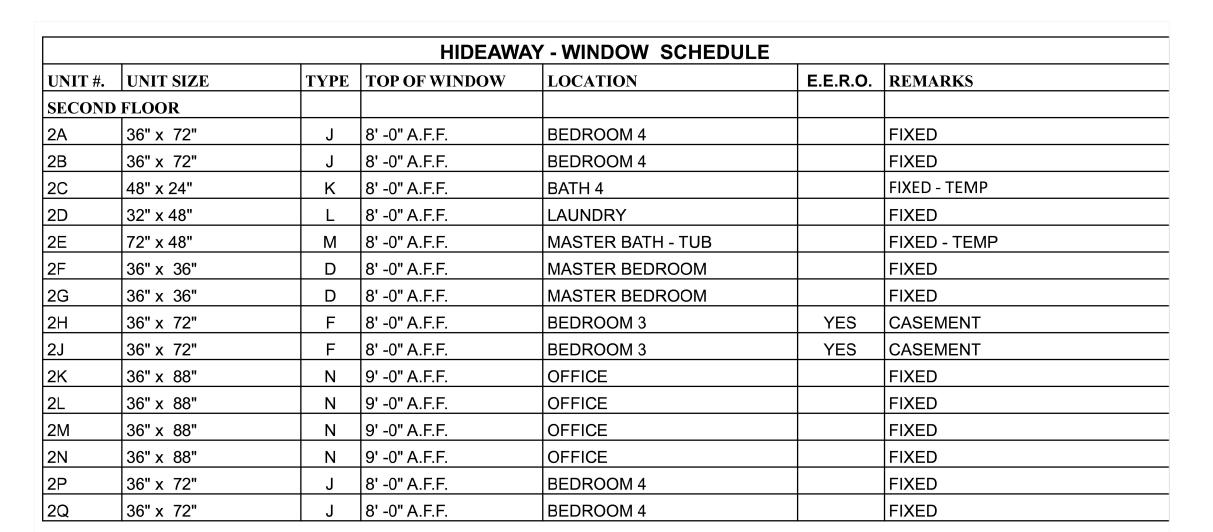

				CASTAWAY -	DOOR SCHED	ULE		
J <b>NIT</b> #.	WIDTH	HEIGHT	THKS.	MATERIALS		DOOR	LOCATION	NOTES
				DOOR	FRAME	TYPE		
SECOND	FLOOR							
14	(2)2'-0"	8'-0"	1 1/2"	WOOD/GLASS	WOOD	F	OFFICE - ENTRY	INTERIOR FRENCH DOORS
15	2'-8"	8'-0"	1 1/2"	sc	WOOD	С	BEDROOM 4 - ENTRY	
16	2'-8"	8'-0"	1 1/2"	SC	WOOD	С	BATH 4 - ENTRY	
17	2'-8"	8'-0"	1 1/2"	SC	WOOD	С	LAUNDRY - ENTRY	
18	2'-8"	8'-0"	1 1/2"	SC	WOOD	С	LAUNDRY - MECHANICAL	
19	3'-0"	8'-0"	1 1/2"	SC	WOOD	С	ELEVATOR - ENTRY	ELEVATOR MANUF. SPECS.
20	2'-8"	8'-0"	1 1/2"	SC	WOOD	D	BEDROOM 3 - ENTRY	
21	2'-8"	8'-0"	1 1/2"	SC	WOOD	С	BEDROOM 3 - WIC	POCKET DOOR
22	2'-8"	8'-0"	1 1/2"	SC	WOOD	D	BATH 3 - ENTRY	POCKET DOOR
23	2'-8"	8'-0"	1 1/2"	SC	WOOD	С	MASTER SUITE - ENTRY	
24	2'-6"	8'-0"	1 1/2"	SC	WOOD	D	MASTER SUITE - HER CLOSET	POCKET DOOR
<u>25</u>	2'-6"	8'-0"	1 1/2"	sc	WOOD	D	MASTER SUITE - HIS CLOSET	POCKET DOOR
26	2'-8"	8'-0"	1 1/2"	SC	WOOD	D	MASTER BATH - ENTRY	POCKET DOOR
27	2'-6"	8'-0"	1 1/2"	SC	WOOD	D	MASTER BATH - WC	
28	2'-0"	8'-0"	1 1/2"	SC	WOOD	С	MASTER BATH - LINEN	
29	(3)4'-0"	8'-0"	1 1/2"	ALUMINUM/GLASS	ALUMINIUM	Н	MASTER SUITE - BALCONY	FOLDING GLASS DOOR
30	(4)4'-0"	8'-0"	1 1/2"	ALUMINUM/GLASS	ALUMINIUM	G	MASTER SUITE - BALCONY	FOLDING GLASS DOOR
31	(2)2'-0"	8'-0"	1 1/2"	WOOD/GLASS	WOOD	F	BEDROOM 4 - BALCONY	FRENCH DOOR - EXTERIOR

120	WINDOW HEIGHT ELEV @ 9'-0" A.F.F.  WINDOW HEIGHT ELEV @ 8'-0" A.F.F.	TRANSOM  36" x 72" FIXED	72 36 36 36" x 24" TRANSOM TRA	36" × 83" FIXED TEMP 36" × 83" FIXED 108" 108" 108" 1090 1090	36 36" x 36" FIXED TEMP  90  00	108  36 36 36  36" x 36" FIXED FIXED FIXED TEMP  TEMP  TEMP  108  36" x 36" FIXED TEMP  TEMP	36 36" ** 72" EERO	24 108 BUT 108 BUT 108 BUT 108 BUT 108	72 36 36 36" x 72" 36" x 72" FIXED FIXED EERO EERO	36 36" x 72" FIXED 96	48 48" × 24" FIXED TEMP 00	84 84 84 84 84 84 84 84 84	72 72" x 48" FIXED TEMP	108 48 84 BIXED 36" × 84" BIXED	32 32" x 16" FIXED TEMP
	ELEV @ 0'-0" A.F.F.	TYPE A FIXED MULLIONS	TYPE B CASEMENT + TRANSOM (DOUBLE) MULLIONS MULLED UNIT	TYPE C FIXED 3 WINDOW PATTERN MULLIONS	TYPE D FIXED - TEMP MULLIONS	TYPE E FIXED - TEMP MULLIONS MULLED UNIT	TYPE F CASEMENT MULLIONS MULLED UNIT	TYPE G FIXED MULLED MULLIONS	TYPE H CASEMENT (DOUBLE) MULLIONS MULLED UNIT EERO	TYPE J CASEMENT - EGRESS MULLIONS	TYPE K FIXED TEMPERED	TYPE L FIXED TEMPERED	TYPE M FIXED TEMPERED	TYPE N FIXED MULLIONS	TYPE P FIXED TRANSOM MULLIONS
												$\wedge$			


WINDOW ELEVATIONS

1. FOR EXACT SILL HEIGHT ABOVE FINISHED FLOOR (A.F.F.), SEE ELEVATIONS. FLOOR PLANS ONLY SHOW ALPHABETICAL NOTATION. SEE WINDOW SCHEDULE FOR FULL

- 2. ALL WINDOWS THAT HAVE A SILL LOWER THAN 24 INCHES A.F.F. WILL HAVE TEMPERED GLASS
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			SEE PLAN	SEE PLAN	SEE PLAN	SEE PLAN										
							10-18						.08		4	
OP OF FIRST FLOOR LEV @ 0'-0" A.F.F.	TYPE A 9'-0" X 16'-0"  OVERHEAD GARAGE DOOR DOOR SET -8" B.F.F. MATERIAL T.B.D.	TYPE B 4'-0' x 10'-0" ENTRY DOOR EXTERIOR GRADE MATERIAL T.B.D.	TYPE C 8'-0" HEIGHT INTERIOR DOOR STYLE TBD	TYPE D 8'-0" HEIGHT POCKET DOOR	TYPE E 8'-0" HEIGHT DOUBLE DOOR	TYPE F 8'-0" HEIGHT FRENCH DOOR TEMP	,    -	TYP EXTERIOR FOLDI TEMP	PE G NG GLASS DOOR ERED		TYPE H 12'-0" x 8'-0" CENTER CLOSE SLIDING GLASS DOI TEMP	DR		TYP 16'-0" > CENTER SLIDING GL		

DOOR ELEVATIONS

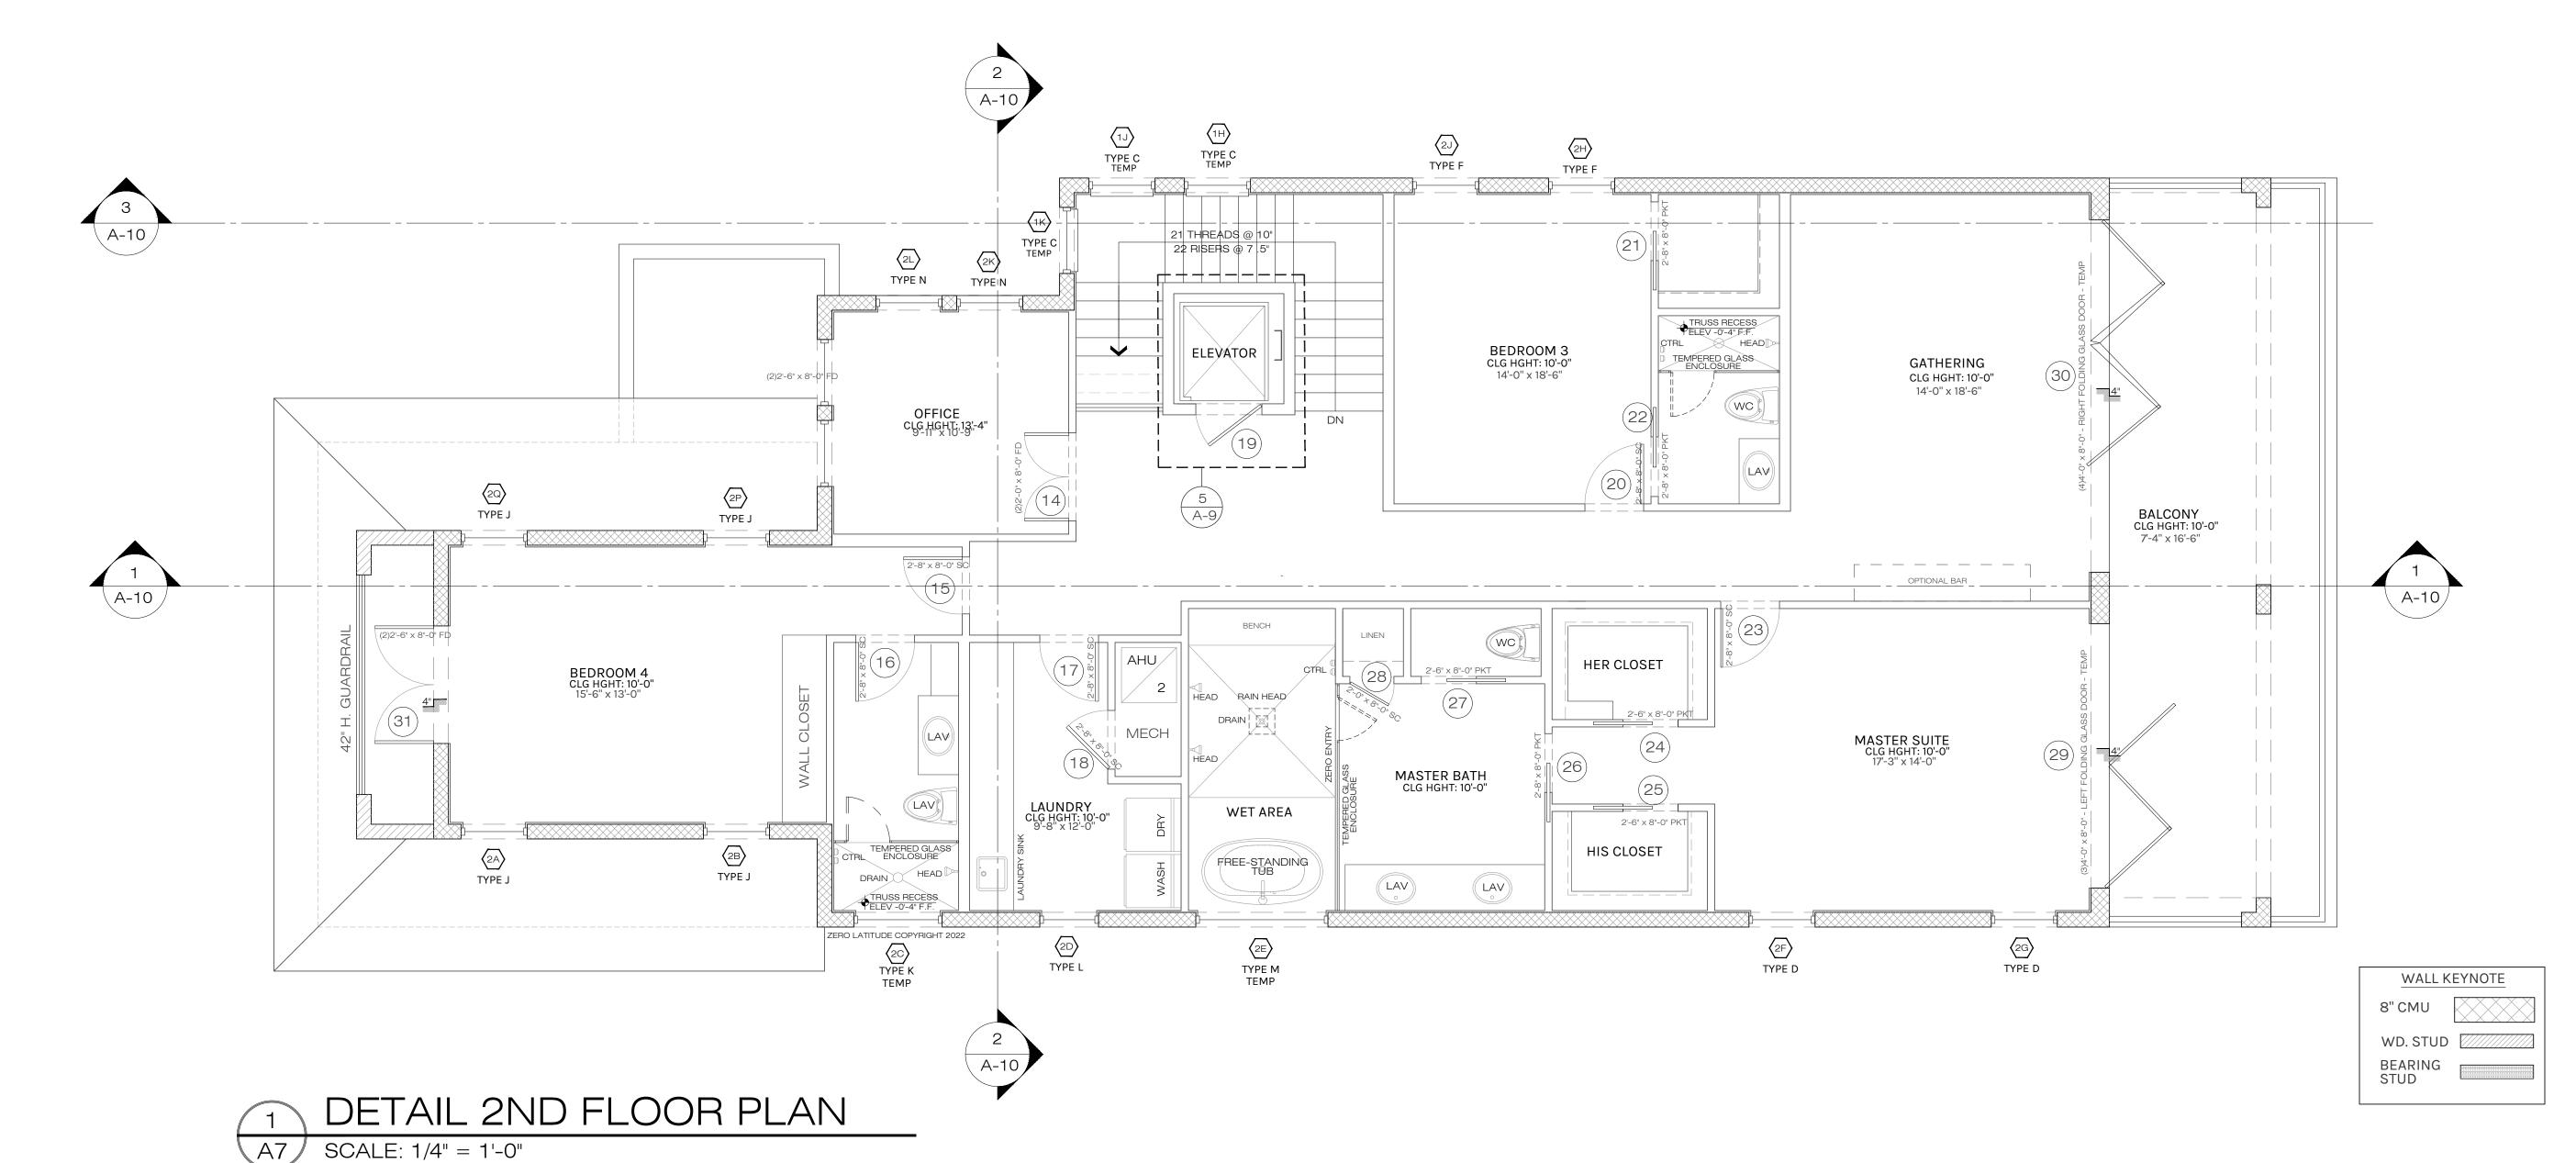

#### FLOOR PLAN NOTES

COMPONENTS AND CLADDING

WINDOW AND DOOR

WIND PRESSURE SCHEDULE Vasd VALUES (EXP C. 160mph Vult)

20 S.F.

100 S.F.

10 S.F.

20 S.F.

PRESSURE (PSF)

+33.4, -44.8

+31.9, -41.7

+30.0, -37.8

+28.4, -34.7

+35.6, -47.7

+34.1, -44.5

+32.0, -40.2

+30.3, -37.0

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	FOR USE ON, AND IN CONNECTION WITH THE SPECIFED PROJECT, NONE OF SUCH DISC ARRANGEMENTS, OR PLANS SHALL BE USED BY, OR DISCLOSED TO ANY PERSON, FIRM
	CORPORATION FOR ANY PURPOSE WHATSOEVER WITHOUT THE WRITTEN PERMISSION LATITUDE. WRITTEN DIMENSIONS ON THESE DRAWINGS SHALL HAVE PRECEDENCE
	OVER SCALE DIMENSIONS, CONTRACTORS SHALL VERIFY AND BE RESPONSIBLE FOR A
	AND CONDITIONS ON THE JOB, AND THIS OFFICE MUST BE NOTIFIED OF ANY VARIATION DIMENSIONS AND CONDITIONS SHOWN BY THESE DRAWINGS, SHOP DETAILS OF ADEC
$\neg$	MUST BE SUBMITTED TO THIS OFFICE FOR APPROVAL BEFORE PROCEEDING WITH FABI
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# Date	6/6/23			
#	_			
Revisions	CITY COMMENTS			

A NEW HOME BY ZERO LATITUDE HOMES

HIDEAWAY SPEC HOME

LOT 7 - SOUTH HARBOR DR., VERO BEACH, FI

DANIEL SOUTER, P.E. P.E.# 63901

P.O. BOX 547774


ORLANDO, FL 32854

PHONE: (407) 421-4866



D	ate	02-10-23
Pr	oject#	22-026
Dr	awn by	FVC
Cł	necked by	JH/DS
Inte	eviewed by erior Design Owner	YES



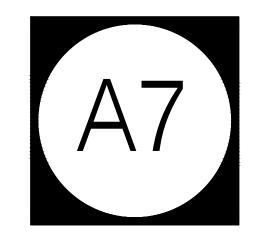

PERMIT SET FOR CONSTRUCTION

#### MAIN TRUSS BRG ELEV. @ + 24'-8" F.F. T.O. PARAPET ELEV. @ + 14'-0" F.F. MAIN TRUSS BRG ELEV. @ + 28'-8" F.F. LOW-SLOPE FLAT ROOF 5:12 SLOPE 5:12 SLOPE MAIN TRUSS BRG ELEV. @ + 24'-8" F.F. RIDGE MAIN TRUSS BRG ELEV. @ + 28'-8" F.F. 5:12 SLOPE ARCHITECTURAL METAL STANDING-SEAM ROOF INSTALLED PER MANUFACTURER SPECIFICATIONS RIDGE \$5:12 SLOPE RIDGE \$5:12 SLOPE MAIN TRUSS BRG ELEV. @ + 24'-8" F.F. MAIN TRUSS BRG ELEV. @ + 24'-8" F.F. □DS NO ROOF OR SOFFIT VENTS REQUIRED. SPRAY FOAM INSULATION TYPICAL IN ATTIC SPACE. INSTALLED AS PER ENERGY CALCULATIONS

AND THE MANUFACTURER SPECSIFICATIONS.

## 1 ROOF PLAN A8 SCALE: 1/4" = 1'-0"

#### **ROOF NOTES**

GENERAL NOTES:

COORDINATE ALL ROOF NOTES WITH ELEVATION AND FLOOR PLANS NOTES.
 REFER TO ROOFING SPECIFICATIONS 202 7TH EDITION FBC CHAPTER 9 - ROOF ASSEMBLIES FOR FURTHER INFORMATION, TYP.
 REFER TO CIVIL DRAWINGS FOR STORM DRAIN

LOCATION. COORDINATE IN FIELD.

4. PROVIDE ROOF CRICKETING AROUND ROOF ACCESSORIES AND PENETRATIONS.

5. GENERAL CONTRACTOR TO COORDINATE

5. GENERAL CONTRACTOR TO COORDINATE LOCATIONS OF DOWNSPOUT AND/OR SCUPPERS IF APPLICABLE TO BUILD.

LOW-SLOPE ROOF DRAINAGE

ALL LOW ROOFS SURROUNDED BY PARAPET WALLS TO HAVE DRAINS PIPED TO EXTERIOR OF RESIDENCE, WITH SEPARATE OVERFLOW DRAINS OR SCUPPERS LOCATED 2" ABOVE PRIMARY DRAIN ELEVATION TO COMPLY WITH FBC-R304 AND FBC-PLUMBING 1105 & 1106

#### FLASHING NOTE:

FLASHING SHALL BE INSTALLED AT ALL WALL AND ROOF INTERSECTIONS, AT ALL CHANGE IN ROOF SLOPE OR DIRECTION AND AROUND ALL ROOF OPENINGS PER FBC-R903.

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3/23	© 2022 ZERO LATITUDE
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	CONTRACTOR AND THE TOTAL STATEMENT OF THE STATEMENT OF TH
	AND CANDITIONS ON THE LOGA, AND THIS OFFICE MATER ENOTHED CARVA CARVAGARIONS IN DIMENSIONS AND CONDITIONS SHOWN BY THESE FRANKINGS SHOW FOR ADEQUAL MUST BE SUBMITTED TO THIS OFFICE FOR APPROVAL BEFORE PROCEEDING WITH FABRICA THESE OFFICE FOR APPROVALE BEFORE PROCEEDING WITH FABRICA THESE OFFICE FOR APPROVALED FOR THE STATE OF THE STATE OFFI THE STAT
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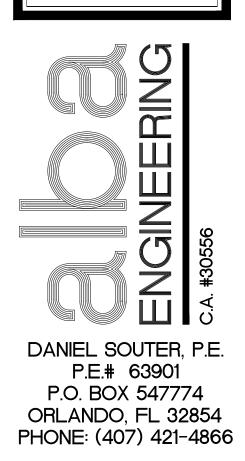
# Date	6/6/23			
#	_			
Revisions	CITY COMMENTS			

A NEW HOME BY ZERO LATITUDE HOMES

HIDEAWAY SPEC HOME

LOT 7 - SOUTH HARBOR DR., VERO BEACH, FL

MERIDIAN CLISTOM HOMES







Date	02-10-23
Project #	22-026
Drawn by	FVC
Checked by	JH/DS
Reviewed by Interior Design & Owner	YES





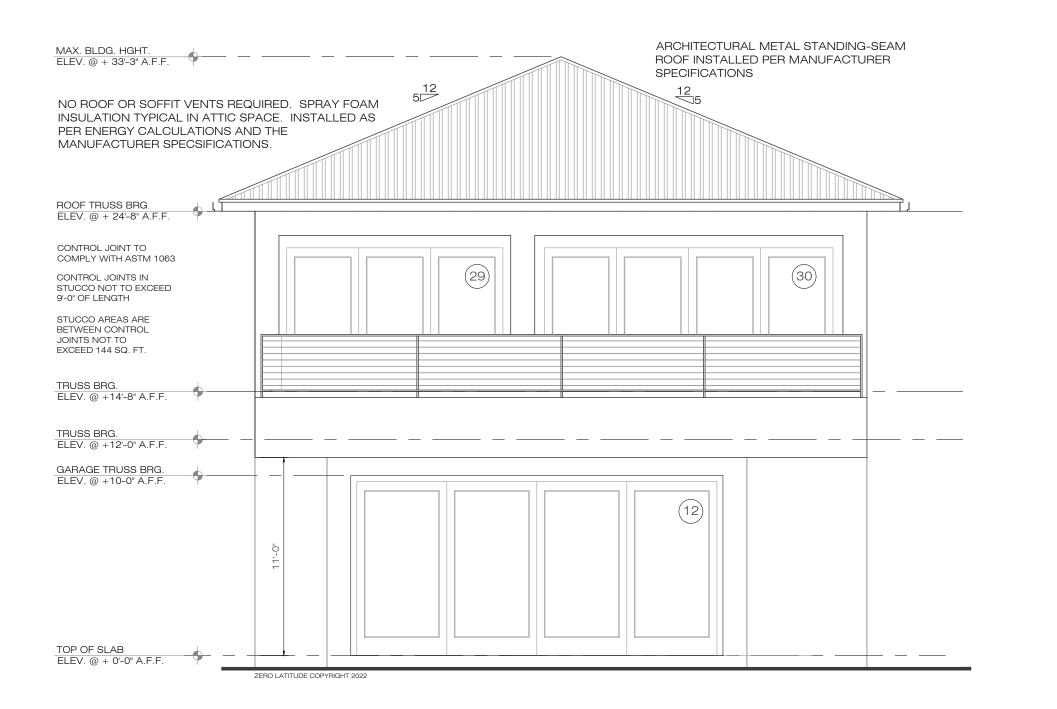




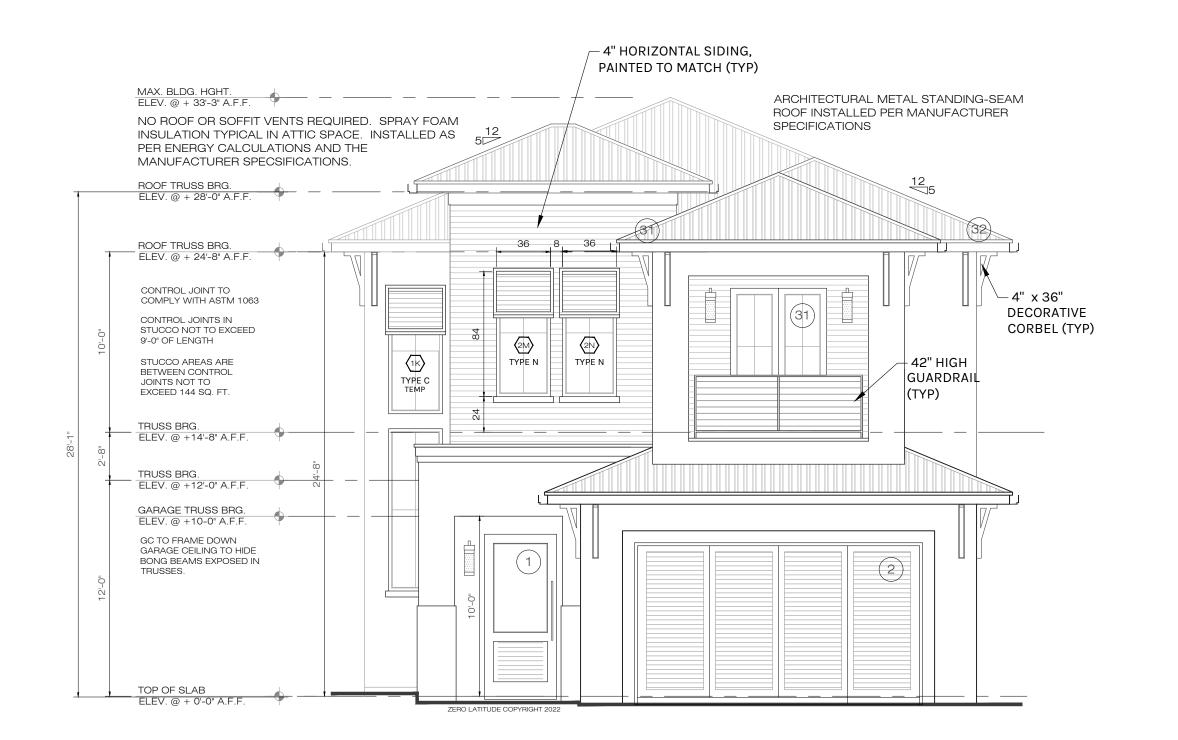

FRONT ELEVATION SCALE: 3/16" = 1'-0"

#### ARCHITECTURAL METAL STANDING-SEAM ROOF INSTALLED PER MANUFACTURER NO ROOF OR SOFFIT VENTS REQUIRED. SPRAY FOAM SPECIFICATIONS INSULATION TYPICAL IN ATTIC SPACE. INSTALLED AS PER ENERGY CALCULATIONS AND THE MANUFACTURER SPECSIFICATIONS. ROOF TRUSS BRG. ELEV. @ + 24'-8" A.F.F 5'-0" CONTROL JOINT TO COMPLY WITH ASTM 1063 STUCCO NOT TO EXCEED 9'-0" OF LENGTH STUCCO AREAS ARE BETWEEN CONTROL JOINTS NOT TO EXCEED 144 SQ. FT. - BAHAMAS SHUTTER SIZED PER WINDOW GC TO FRAME DOWN GARAGE CEILING TO HIDE BONG BEAMS EXPOSED IN TRUSSES. – 8" BAND ON 14" BAND W/ 4" TRIM CAP (TYP)

#### LEFT SIDE ELEVATION SCALE: 3/16" = 1'-0"

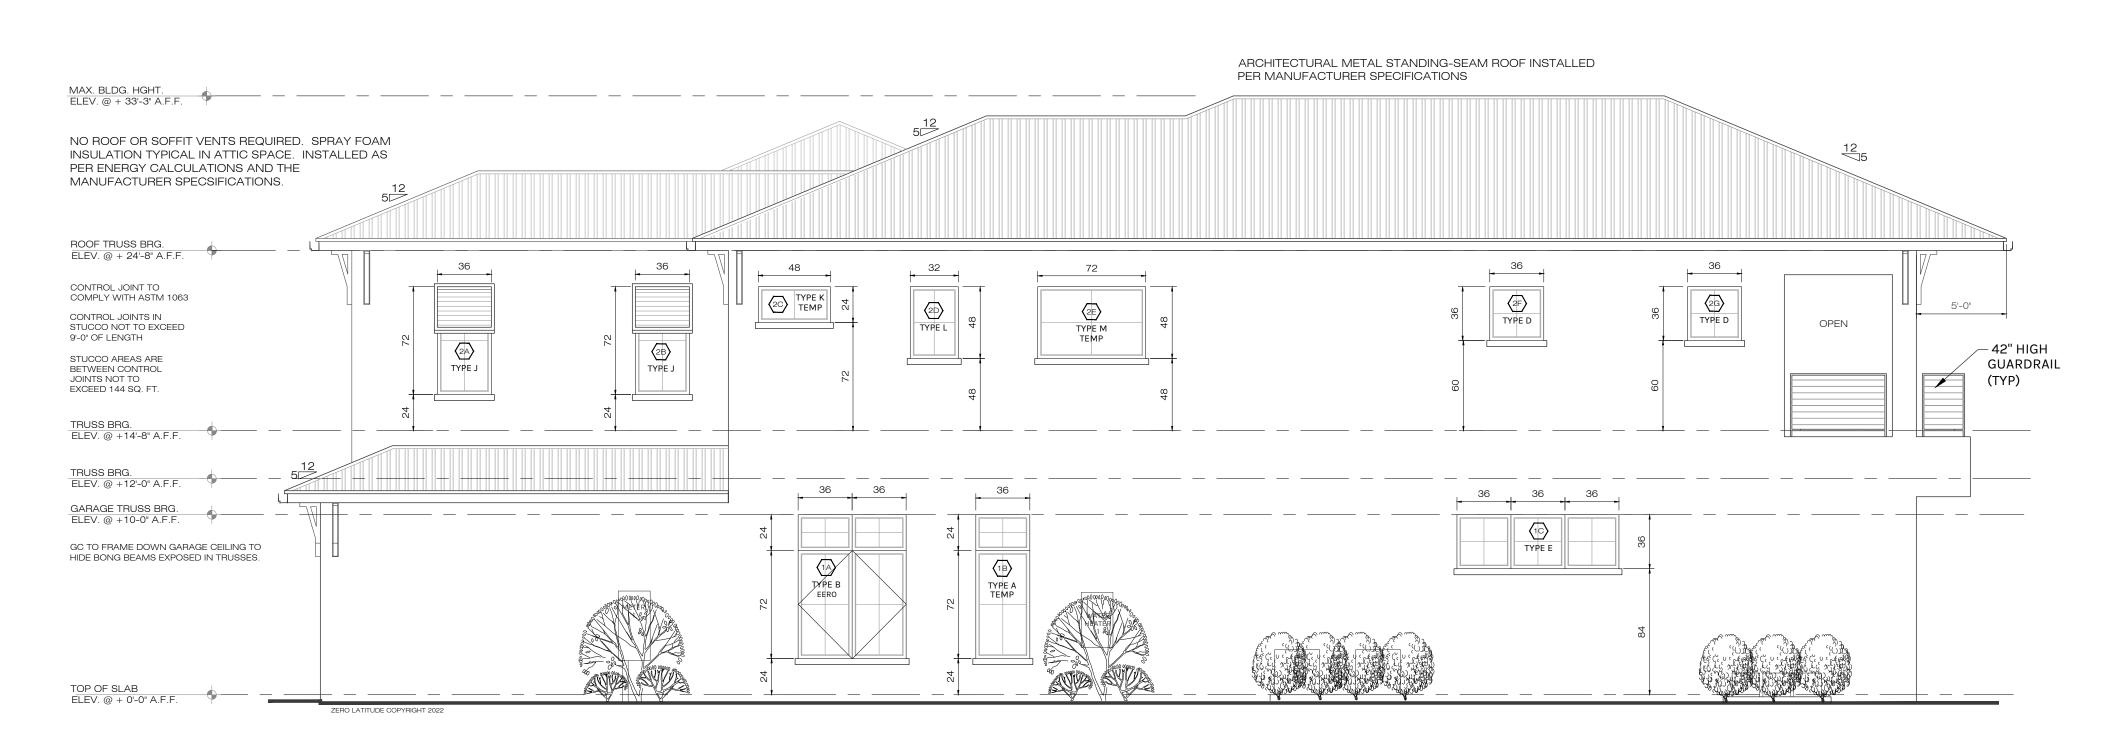

RIGHT SIDE ELEVATION SCALE: 3/16" = 1'-0"

#### **GUARD RAILS**

GUARD RAILS SHALL BE PROVIDED FOR THOSE PORTIONS OF OPEN-SIDED WALKING SURFACES, INCLUDING STAIRS, RAMPS AND LANDINGS, THAT ARE LOCATED MORE THAN 30" MEASURED VERTICALLY TO THE FLOOR OR GRADE BELOW AT ANY POINT WITHIN 24 INCHES HORIZONTALLY TO THE EDGE OF THE OPEN SIDE. INSECT SCREENING SHALL NOT BE CONSIDERED AS A GUARD. GUARDS SHALL NOT BE LESS THAN 36" IN HEIGHT. LARGEST GAPS BETWEEN HANDRAIL MEMBERS, PICKETS AND BASE SHALL NOT EXCEED 4". HANDRAIL/GUARDRAII LIVE LOADS, GUARDS AND HANDRAILS (HIGHER OF 200LB PT LOAD OR 50PLF). GUARD/PICKET INFILL COMPONENTS, 50PSF OVER A 1 SQ. FT. AREA.

#### STUCCO APPLICATION

TYPICAL 5/8" SMOOTH STUCCO FINISH @ C.M.U

 TYPICAL 7/8" SMOOTH STUCCO FINISH @ FRAME WALLS OVER EXPANDED METAL OR FIBERGLASS LATH, OVER #15 BUILDING PAPER, OVER TYVEK HOMEWRAP (OR EQUAL).

**ELEVATION NOTES** 

1. TYPICAL 5/8" SMOOTH STUCCO FINISH @ C.M.U.

2. TYPICAL 7/8" SMOOTH STUCCO FINISH @ FRAME

3. ARCHITECTURAL METAL STANDING-SEAM ROOF

5. FRONT ELEVATION WINDOW SILLS TO BE 4" x 6"

6. 6" WOOD SIDING WHERE INDICATED, STYLE AND

7. CONTROL JOINTS ON EXTERIOR STUCCO WALLS

OVER WOOD FRAME TO BE INSTALLED PER ASTM

NOTE: CONTRACTOR TO VERIFY ALL ELEVATIONS PRIOR

DESIGNER/ENGINEER WITH ANY CHANGES OR

ALL EGRESS WINDOWS TO COMPLY W/F.B.C. R 310.1. AN OUTSIDE WINDOW OR DOOR OPERABLE FROM THE INSIDE WITHOUT THE USE OF TOOLS AND PROVIDING A CLEAR OPENING OF NOT LESS THAN 20" WIDE X 24" HIGH AND 5.7 SF IN AREA. THE BOTTOM OF THE OPENING SHALL NOT BE MORE THAN 44" OF THE FLOOR, THE MODE OF OPERATION MUST NOT REQUIRE THE USE OF A KEY, TOOL OR SPECIAL KNOWLEDGE OR EFFORT TO MAKE AVAILABLE THE REQUIRED

CLEAR OPENING, AND NO PART OF THE OPERATION

MECHANISM SHALL BE PLACED HIGHER THAN 54" ABOVE THE

EVERY CLOSET DOOR LATCH SHALL BE SUCH THAT CHILDREN CAN OPEN THE DOOR FROM INSIDE THE CLOSET, EVERY BATHROOM DOOR SHALL BE DESIGNED TO ALLOW OPENING FROM THE OUTSIDE ENSURING AN EMERGENCY WHEN

STUCCO AND/OR WHERE ALSO INDICATED.

COLOR PER CONTRACTOR AND OWNER.

TO CONSTRUCTION AND CONTACT

4. NO ROOF VENTS REQUIRED, SPRAY FOAM INSULATION TO BE USED PER ENERGY

CALCULATIONS.

QUESTIONS.

MEAN OF ESCAPE NOTE (EGRESS):

**EGRESS** 

FINISHED FLOOR.

LOCKED.


INSTALLED PER MANUFACTURER SPECIFICATION.

 CONTROL JOINTS IN STUCCO SHALL NOT EXCEED 9'-0" IN LENGTH.

 STUCCO AREAS ARE BETWEEN CONTROLS JOINTS SHALL NOT EXCEED 144 SQ. FT.

HOR HP1 S 15 - 60 x 60 950#, RH RAIL, IN-LINE OPENING, SCISSOR GATE, 15 SQ. FT.

LUXURY LIFT TRACTION (LLT)

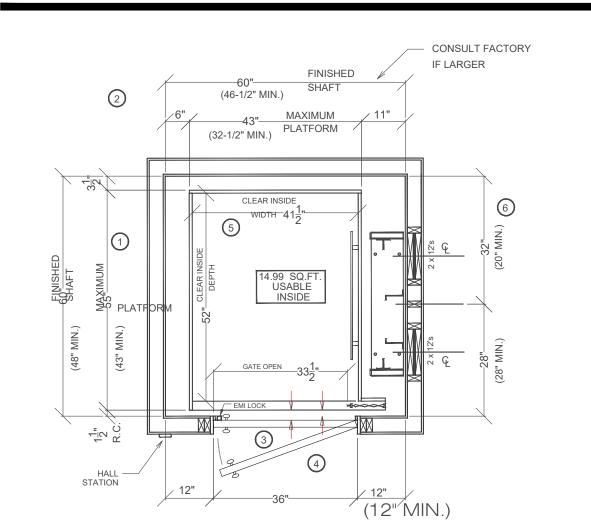

STANDARD HOISTWAY PLAN NOTE: ALL DIMENSIONS ARE APPROXIMATE OVERSIZE CAB OPTION ASSUMED

PART OR AS A WHOLE WITHOUT WRITTEN PERMISSION FROM RESIDENTIAL ELEVATORS IS STRICTLY PROHIBITE

#### NOTES: 1) IF PLATFORM SIZE IS REDUCED, THEN THE BLOCKING IS TO BE POSITIONED SUCH THAT IT IS CENTERED ON THE PLATFORM. (PLATFORM DEPTH / 2) + 2" = CENTERLINE OF RAIL BLOCKING

OFF OF INSIDE FRONT WALL. (MIN. 28" DIMENSION) (2) CAR TO WALL (CTW) DIMENSION IS 3-1/2" MIN.

(3) HOISTWAY DOORS & FRAMES MUST BE INSTALLED TO COMPLY WITH THE AUTHORITY HAVING JURISDICTION REQUIREMENTS. THESE DIMENSIONS VARY. CONSULT YOUR RESIDENTIAL ELEVATORS SALES REPRESENTATIVE FOR DETAILS PRIOR TO CONSTRUCTION.

4 HOISTWAY DOORS TO BE SOLID CORE (BY OTHERS.) (5) CLEAR CAB DIMENSIONS BASED ON A 3/4" FLAT WALL

(6) CLEAR CAB DIMENSIONS BASED ON A 3/4" FLAT WALL


All Traction Elevators require an access panel for emergency lowering. Access panel size and location must be discussed with your Residential Elevators Sales Representative prior to construction.

> Elevating Your Standard of Living ResidentialElevators.com

**5** ELEVATOR DETAIL

A9 | SCALE 1/2" = 1'

SEE MANUFACTURER'S SPECIFICATIONS AND INSTALLATIONS INSTRUCTIONS PRIOR TO FRAMING IN ORDER TO ENSURE EXACT PLACEMENT OF ELEVATOR WALLS & FRAMING.

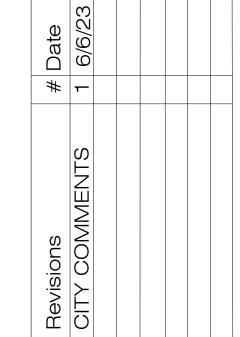

DANIEL SOUTER, P.E. P.E.# 63901 P.O. BOX 547774 ORLANDO, FL 32854 PHONE: (407) 421-4866




Date	02-10-23
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Drawn by	FVC
Checked by	JH/DS
Reviewed by Interior Design	YES

& Owner







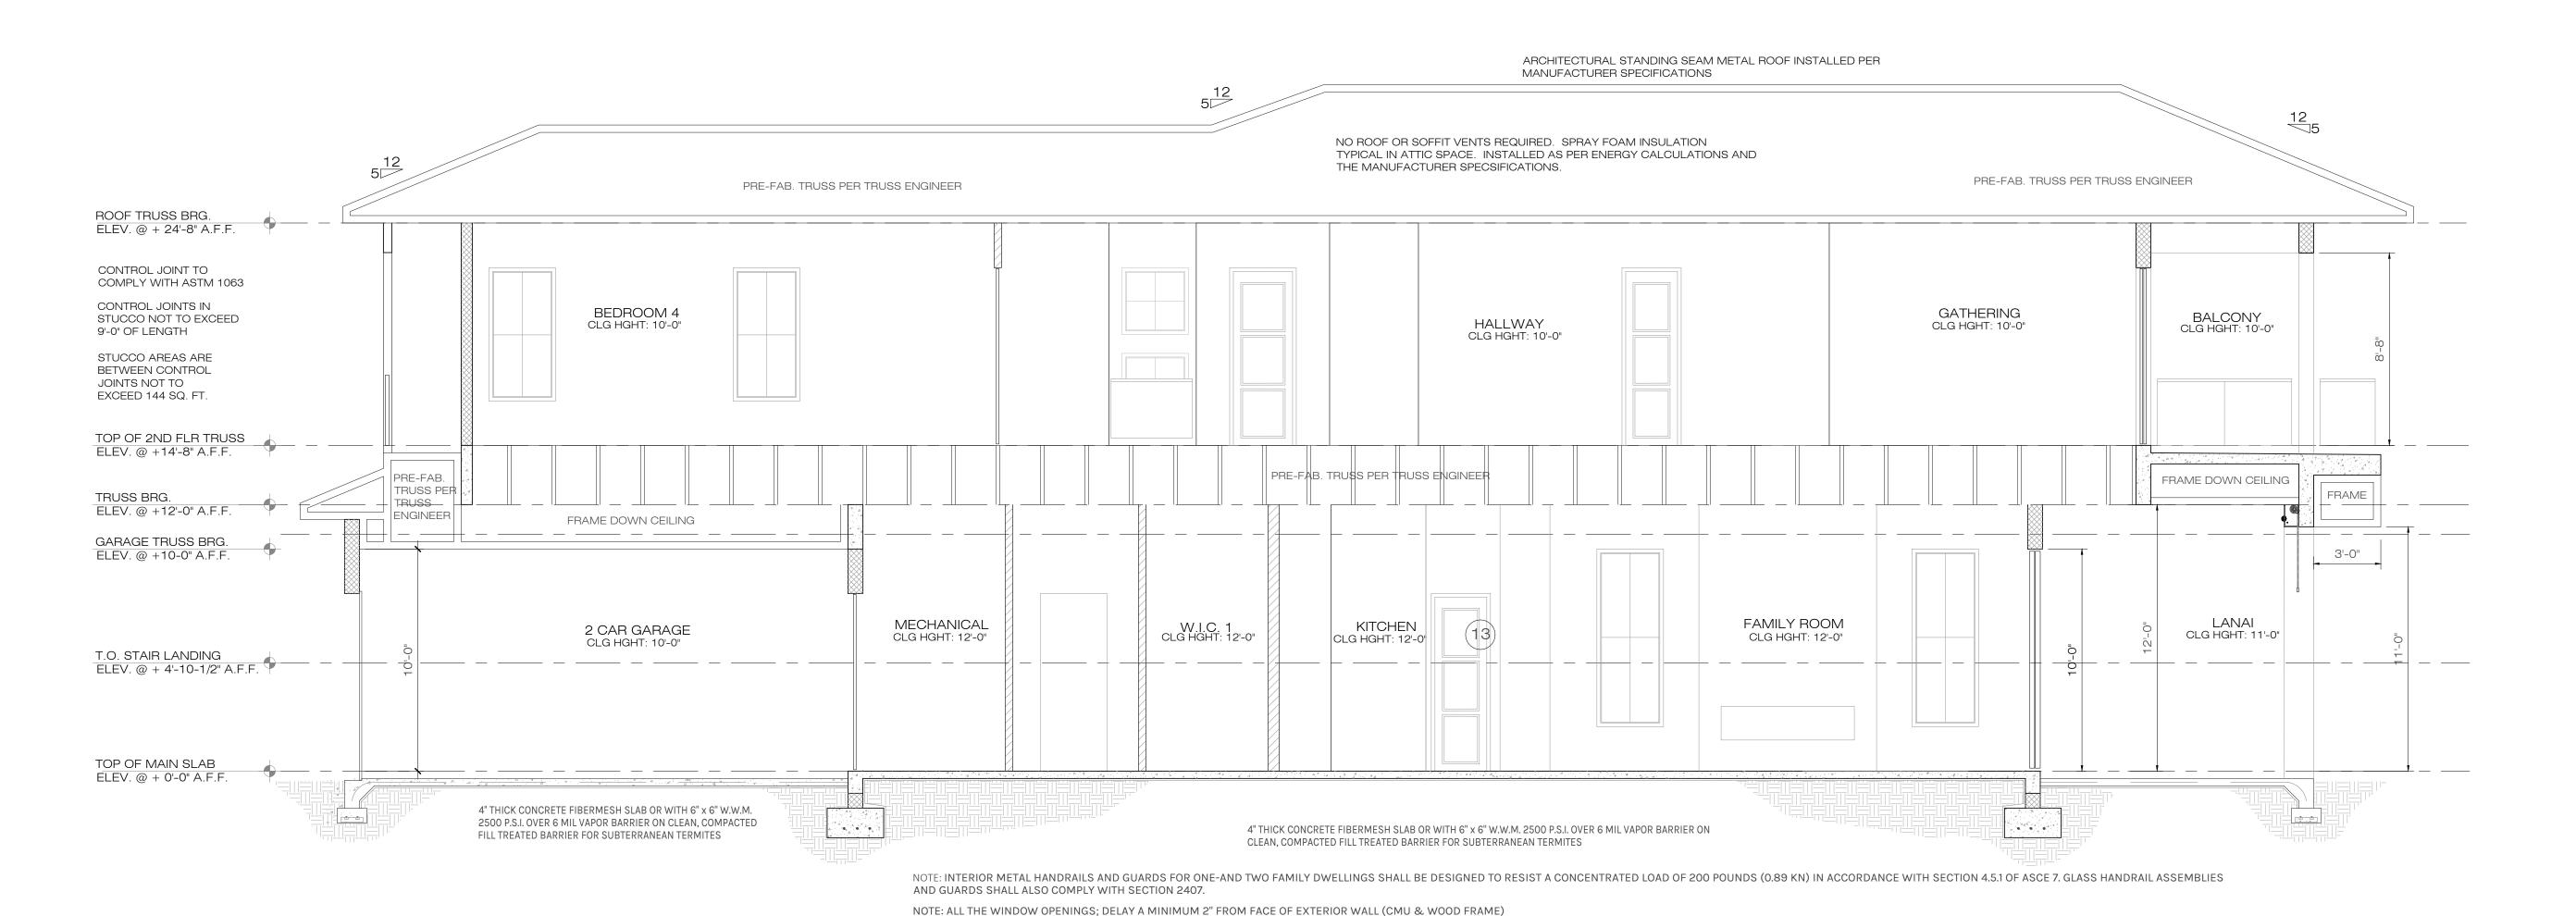


R-318 TERMITE PROTECTION SHALL BE PROVIDED BY REGISTERED TERMTICIDES, INCLUDING SOIL APPLIED PESTICIDES, BAITING SYSTEMS, AND PESTICIDES APPLIED TO WOOD,


OR OTHER APPROVED METHODS OF TERMITE PROTECTION LABELED FOR USE AS A PREVENTATIVE TREATMENT TO NEW CONSTRUCTION (SEE SECTION 202, REGISTERED TERMITICIDE). UPON COMPLETION OF THE APPLICATION OF THE TERMITE PROTECTION TREATMENT, A CERTIFICATE OF COMPLIANCE SHALL BE ISSUED TO THE BUILDING DEPARTMENT BY THE LICENSED PEST CONTROL COMPANY THAT CONTAINS THE FOLLOWING STATEMENT: "THE BUILDING HAS RECEIVED A COMPLETE

TREATMENT FOR THE PREVENTION OF SUBTERRANEAN TERMITES. TREATMENT IS IN ACCORDANCE WITH RULES AND LAWS ESTABLISHED BY FLORIDA DEPARTMENT OF AGRICULTURE AND CONSUMER SERVICES."

1 BUILDING SECTION
A10 SCALE: 1/4" = 1'-0"

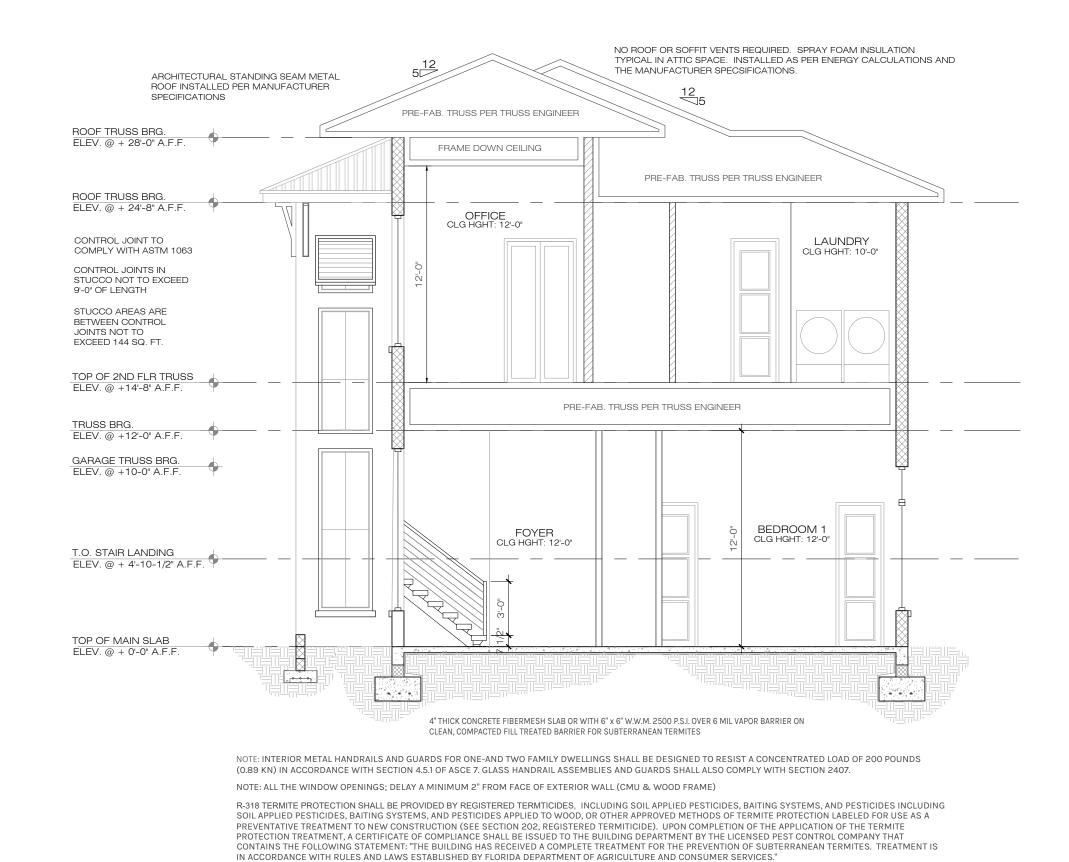



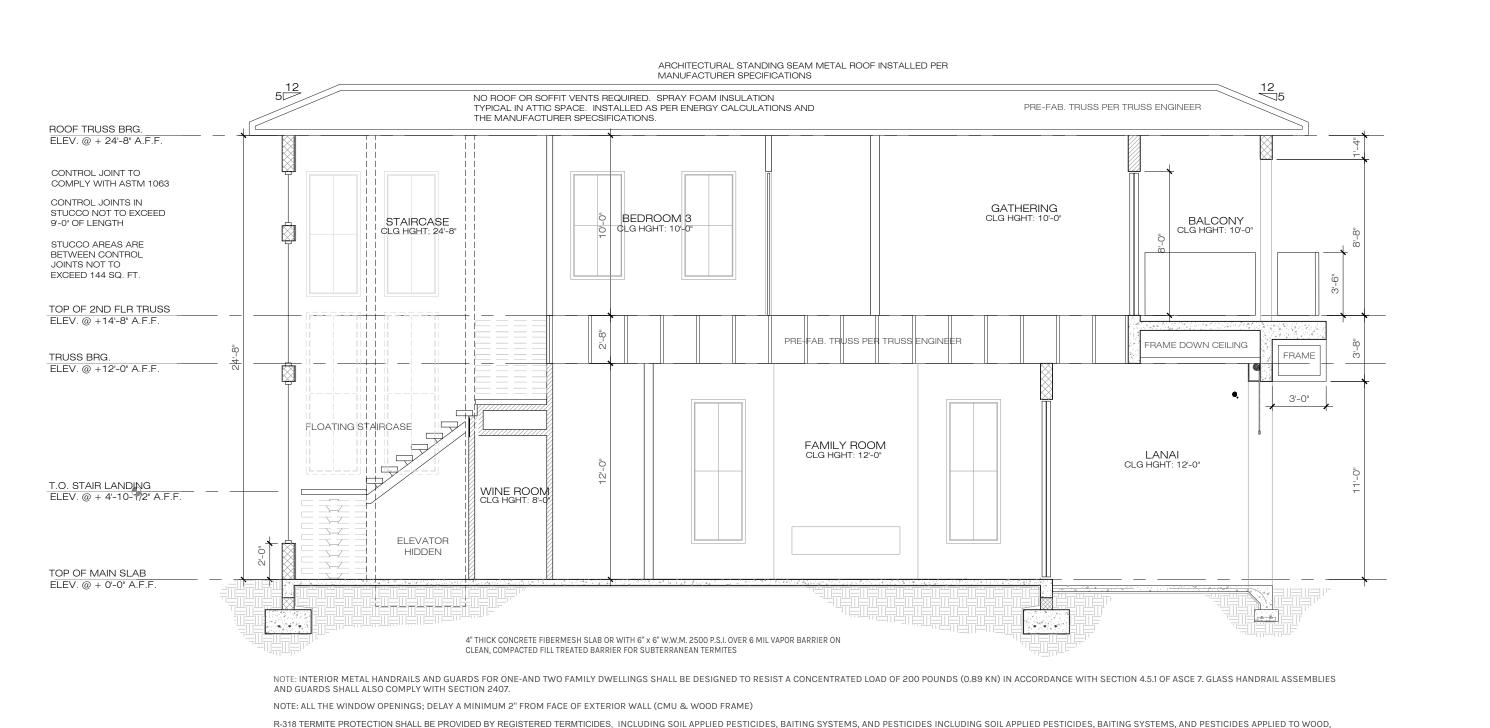

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BUIDLING SECTION A10 SCALE: 3/16" = 1'-0"

#### **ELEVATION NOTES**

- 1. TYPICAL 5/8" SMOOTH STUCCO FINISH @ C.M.U.
- 2. TYPICAL 7/8" SMOOTH STUCCO FINISH @ FRAME
- 3. ARCHITECTURAL METAL STANDING-SEAM ROOF INSTALLED PER MANUFACTURER SPECIFICATION.
- 4. NO ROOF VENTS REQUIRED, SPRAY FOAM INSULATION TO BE USED PER ENERGY
- 5. FRONT ELEVATION WINDOW SILLS TO BE 4" x 6" STUCCO AND/OR WHERE ALSO INDICATED.
- 6. 6" WOOD SIDING WHERE INDICATED, STYLE AND COLOR PER CONTRACTOR AND OWNER.
- 7. CONTROL JOINTS ON EXTERIOR STUCCO WALLS OVER WOOD FRAME TO BE INSTALLED PER ASTM
- NOTE: CONTRACTOR TO VERIFY ALL ELEVATIONS PRIOR TO CONSTRUCTION AND CONTACT DESIGNER/ENGINEER WITH ANY CHANGES OR QUESTIONS.

#### **EGRESS**

MEAN OF ESCAPE NOTE (EGRESS):

CALCULATIONS.

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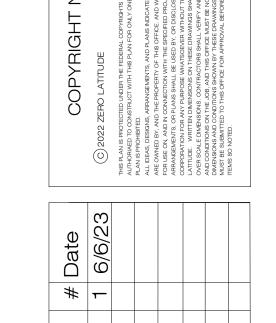
#### CONTROL JOINTS


- CONTROL JOINTS IN STUCCO SHALL NOT EXCEED 9'-0" IN LENGTH.
- STUCCO AREAS ARE BETWEEN CONTROLS JOINTS SHALL NOT EXCEED 144 SQ. FT.


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P.O. BOX 547774

ORLANDO, FL 32854

PHONE: (407) 421-4866

Date	02-10-23
Project #	22-026
Drawn by	FVC
Checked by	JH/DS
Reviewed by Interior Design & Owner	YES

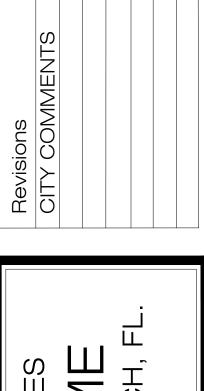

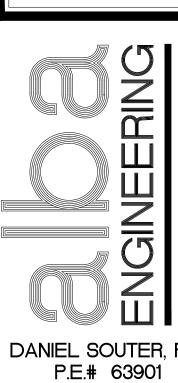

#### **ELECTRICAL NOTES**

1. DRAWINGS ARE DIAGRAMMATIC AND SHALL N OT BE SCALED. REFER TO ARCHITECTURAL PLANS AND ELEVATIONS FOR EXACT LOCATION OF ALL EQUIPMENT AND MANUFACTURER'S SPECIFICATIONS FOR CORRECT INSTALLATION. ELECT

2. ELECTRICAL CONTRACTOR SHALL FURNISH AND INSTALL ALL ITEMS REQUIRED FOR A COMPLETE AND ACCEPTABLE WORKING INSTALLATION. ALL INSTALLATIONS ARE TO BE CHECKED AS WORKING PRIOR TO OCCUPANCY CERTIFICATION.

3. ALL WORK SHALL COMPLY WITH THE LATEST EDITION OF THE NATIONAL ELECTRICAL CODE (NEC) AND WITH ALL LOCAL ORDINANCES HAVING JURISDICTION, PER 2017 NEC EDITION.

4. VERIFY LOCATION OF ALL OUTLETS, RECEPTACLES, SWITCHES, COAX CABLE, CAT 6 DATA, FIXTURES, ETC., WITH OWNER PRIOR TO ANY INSTALLATION.

5. ALL SECURITY SYSTEMS SHALL HAVE 3 PADS. VERIFY OWNER/CONTRACTOR AGREEMENT AND LOCATIONS OF PADS PRIOR TO ANY INSTALLATION.

6. ALL WORK TO BE PERFORMED BY A LICENSED ELECTRICAL CONTRACTOR.

7. ALL MATERIAL SHALL BE NEW AND BEAR THE UNDERWRITERS LABEL (U.L.) WHERE APPLICABLE.

8. THE ELECTRICAL, TELEPHONE, DATA AND CABLE TELEVISION INSTALLATIONS SHALL MEET ALL REQUIREMENTS BY THE LOCAL UTILITY COMPANIES.

9. THE ELECTRICAL SYSTEM SHALL BE COMPLETELY AND EFFECTIVELY GROUNDED AS REQUIRED IN ARTICLE 250 OF THE NATIONAL ELECTRICAL CODE (NEC).

10. ALL WORK SHALL BE COORDINATED WITH OTHER TRADES TO AVOID INTERFERENCE WITH THE PROGRESS OF CONSTRUCTION.

11. UNLESS OTHERWISE INDICATED, ALL RECEPTACLES, CABLE, DATA, AND TELEPHONE OUTLETS TO BE 18" A.F.F.

12. SMOKE DETECTORS ARE INTERCONNECTED AND TO HAVE BATTERY BACKUP, INSTALLED PER NFPA 72.29.8.3.4

13. ALL NON-GFI OUTLETS TO BE ON ARC-FAULT INTERRUPTERS

14. GFI OUTLETS LOCATION OUTDOORS ARE TO BE WATERPROOF & TAMPER-RESISTANT

15. GIF OUTLEST LOCATED IN GARAGES, KITCHENS, AND BATHROOMS, SHALL BE TAMPER-PROOF.

16. ALL DETECTORS SHALL BE SMOKE/CARBON MONOXIDE COMBO, AND SHALL BE HARDWIRED AND INTERCONNECTED WITH BATTERY BACKUP, AND SHALL BE INSTALLED PER NFPA 72.29.8.3.4 - IN NO CASE SHALL MORE THAN 18 INITIATING DEVICES BE INTERCONNECTED OF WHICH 12 CAN BE SMOKE ALARMS WHERE THE INTERCONNECTING MEANS IS NOT SUPERVISED. PER NFPA 72.29.8.2 HOMES WITH A LARGE NUMBER OF BEDROOMS WHERE MORE THAN 12 SMOKE ALARMS OR CARBON MONOXIDE ALARM COMBINATION, WILL REQUIRE A SEPARATE PERMIT FOR A FIRE ALARM SYSTEM.

17. ELECTRICAL METER AN PANEL LOCATION MAY VARY AS PER SERVICE ENTRANCE LOCATION.

18. ALL WIRING TO BE COPPER.

19. IF CHOSEN BY OWNER, CONTRACTOR TO VERIFY LOCATION OF E.C.P. 240V ELECTRIC CHARGING PORT WITH OWNER PRIOR TO INSTALLATION. ELECTRIC CAR CHARGING STATION TO BE INSTALLED PER MANUFACTURER'S SPECIFICATIONS. VERIFY CHARGING STATION SPECIFICATIONS MATCH OWNERS VEHICLES.

NOTE: THIS DIAGRAMMATIC PLAN IS INTENDED TO SHOW LIGHTING AND CONVENIENCE OUTLETS ONLY. ZERO LATITUDE INC. WILL BEAR NO RESPONSIBILITY FOR IT'S ACCURACY. IT IS THE ELECTRICAL CONTRACTOR'S RESPONSIBILITY TO VERITY THE REQUIREMENTS AND LOCATIONS OF ALL ELECTRICAL EQUIPMENT AND PROVIDE AND INSTALL COMPLETE ELECTRICAL SERVICES AS REQUIRED PRIOR TO COMMENCING WITH ANY INSTALLATION. ELECTRICAL CONTRACTOR TO SUBMIT PLAN AND PULL PERMIT.

#### FIRE-SMOKE ALARM SYSTEM

#### NFPA 72 29.5.1.3.1

All points on the ceiling shall have a smoke alarm within a distance of 30 ft (9.1 m) travel distance or shall have an equivalent of one smoke alarm per 500 ft2 (46 m2) of floor area.

29.5.1.1 - Where required by other governing laws, codes, or standards for a specific type of occupancy, approved single and multiple-station smoke alarms shall be installed as follows:

(2) In all sleeping rooms and guest rooms(2) Outside of each separate dwelling unit sleeping area, within 21 ft. of any door to a sleeping room, with the distance measured along a path of travel(3) On every level of a dwelling unit, including basements

(4) On every level of a residential board and care occupancy (small facility), including basements and excluding crawl spaces and unfinished attics
(5) In the living area(s) of a guest suite
(6) In the living area(s) of a residential board and care occupancy (small facility)

ELECTRICAL CONTRACTOR AND OR SECURITY SYSTEMS

EQUIPPED WITH AN EXIT ALARM THAT HAS A MINIMUM

SOUND PRESSURE RATING OF 85 DECIBELS AT 10 FEET,

CONTRACTOR SHALL BE RESPONSIBLE TO ENSURE

ACCESS FROM THE HOME TO THE POOL WILL BE

PER THE REQUIREMENTS DESCRIBED IN FLORIDA STATUTES SECTIONS 515.21 - 515.37, THE RESIDENTIAL

THAT ALL DOORS AND WINDOWS PROVIDING DIRECT

**SECURITY SYSTEM** 

SWIMMING POOL SAFETY ACT.

## 29.5.1.2 - Where the area addressed in 29.5.1.1(2) is separated from the adjacent living areas by a door, a smoke alarm shall be installed in the area between the door and the sleeping rooms, and additional alarms shall be installed on the living area side of the door as specified by 29.5.1.1 and 29.5.1.3.

29.5.1.3 - In addition to the requirements of 29.5.1.1(1) through (3), where the interior floor area for a given level of a dwelling unit, excluding garage areas, is greater than 1000 ft2 smoke alarms shall be installed per 29.5.1.3.1 and 29.5.1.3.2.

29.5.1.3.1 - All points on the ceiling shall have a smoke alarm within a distance of 30 ft. travel distance or shall have an equivalent of one smoke alarm per 500 ft2 of floor area. One smoke alarm per 500 ft2 is evaluated by dividing the total interior square footage of floor area per level by 500 ft2

29.5.1.3.2 - Where dwelling units include great rooms or vaulted/cathedral ceilings extending over multiple floors, smoke alarms located on the upper floor that are intended to protect the aforementioned area shall be permitted to be considered as part of the lower floor(s) protection scheme used to meet the requirements of 29.5.1.3.1.

29.5.2.1.1 - Smoke and Heat Alarms. Unless exempted by applicable laws, codes, or standards, smoke or heat alarms used to provide a fire-warning function, and when two or more alarms are installed within a dwelling unit, suite of rooms, or similar area, shall be arranged so that the operation of any smoke or heat alarm causes all alarms within these locations to sound.

NOTE: A SUPERVISED FIRE ALARM SYSTEM IS REQUIRED TO BE INSTALLED PER NFPA 72.29.8.2 - A SEPARATE FIRE ALARM PERMIT IS REQUIRED. THE SYSTEM DESIGN, PERMIT APPLICATION AND INSTALLATION IS THE RESPONSIBILITY OF THE FIRE ALARM SYSTEM COMPANY. ZERO LATITUDE INC. WILL BEAR NO RESPONSIBILITY FOR IT'S ACCURACY.

THIS DIAGRAMMATIC PLAN IS INTENDED TO SHOW LIGHTING AND CONVENIENCE OUTLETS ONLY. ZERO LATITUDE WILL BEAR NO RESPONSIBILITY FOR IT'S ACCURACY. IT IS THE ELECTRICAL CONTRACTOR'S RESPONSIBILITY TO VERIFY THE THE REQUIREMENTS AND LOCATIONS OF ALL ELECTRICAL EQUIPMENT AND PROVIDE AND INSTALL COMPLETE ELECTRICAL SERVICES AS REQUIRED. ELECTRICAL CONTRACTOR TO SUBMIT PLAN AND PULL PERMIT.


#### PLANTER LIGHTING OPTIONAL SINGLE SWITCH TO SOFFIT RECEPTACLES FOR HOLIDAY LIGHTING - TIMER OPT. FO USB 10'-9 3/4" 13'-9 3/4" 5'-7" EXT. EXTERIOR LANAI 8'-4 1/2" LED DEFORMABLE LIGHT G.F.I. 48" A.F.F. ZERO LATITUDE COPYRIGHT 2022 Ψ<sub>G.F.I.</sub> CONNECT TO \*\* SECOND FLOOR WALL KEYNOTE SMOKE DETECTORS REQUIRED - 4 PROVIDED WD. STUD BEARING STUD

#### ELECTRICAL SYMBOLS LEGEND

ELECTRIC METER

	ELECTRIC PANEL
DISP	ELECTRICAL - A/C DISCONNECT
$\overline{\bullet}$	DUPLEX OUTLET
FO	FLOOR OUTLET LOCATE PER OWNERS / BUILDER
$\overline{\bullet}$	DUPLEX OUTLET -HALF SWITCHED
	WEATHER PROOF DUPLEX OUTLET
⊖ G.F.I.	G.F.I DUPLEX OUTLET
	220 VOLT RECEPTACLE
-2	TELEVISION JACK
$\triangleleft$	CAT 6 NETWORK
V	CENTRAL VACUUM HOSE OUTLET
$\Theta$	WALL SWITCH
$\Theta_{\omega}$	3-WAY WALL SWITCH
€4	4-WAY WALL SWITCH
$\leftrightarrow^{\circ}$	DIMMER WALL SWITCH
	PUSH BUTTON WALL SWITCH
-	CEILING MOUNTED LIGHT FIXTURE
HO	WALL MOUNTED LIGHT FIXTURE
J	JUNCTION BOX
$\Box$ $\Box$ $\Box$	TRACK LIGHTING
<u>O</u>	HANGING LIGHT FIXTURE
	RECESSED LIGHT FIXTURE
<b>○</b> →	RECESSED HIGHLIGHTING LIGHT FIXTURE
V.P.	VAPOR RESISTANT RECESSED LIGHT FIXTURE
EXT.	EXTERIOR RECESSED LIGHT FIXTURE
	4' LONG FLUORESCENT LIGHT FIXTURE
	52" CEILING FAN WITH LIGHT
	FLOOD LIGHT
$\bigcirc$	THERMOSTAT
FACP	FIRE ALARM CONTROL PANEL
(SD)	SMOKE DETECTOR
ĆMD	SMOKE & CARBON MONOXIDE DETECTOR
€ <sub>E.F.</sub>	EXHAUST FAN CFM MIN 80
<b>+</b>	CEILING OUTLET
	NEMA 14-50 (220V) ELECT CAR CHARGER OUTLE
	GARAGE DOOR POWER BUTTON
•	DOORBELL BUTTON
	LED GARAGE, DEFORMABLE TRIPLE LIGHT
СН	DOORBELL CHIME

SMOKE DETECTOR GOES INSIDE BEDROOMS
SMOKE & CARBON MONOXIDE DETECTOR GOES IN COMMON AREAS

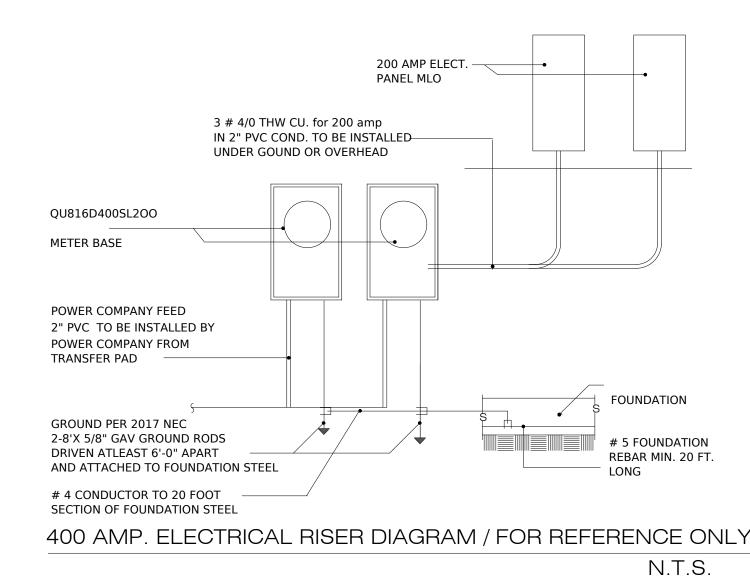

DESIGN WITH AN ELECTRICAL RISER DIAGRAM AND LOAD CALCULATIONS IS THE RESPONSIBILITY OF THE ELECTRICAL CONTRACTOR, AND SHALL VERIFY PANEL AMPERAGE IS CORRECT PRIOR

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THIS PLAN IS PROTECTED UNDER THE FEDERAL COPPRIGHTS LAWS. THE ORIGINAL PURCHASER IS AUTHORAGE TO CONSTRUCT WITH THIS PLAN EDGAL OOK TIME. RELSE OR CHANGE OF THIS PLAN IS PROHIBITED.

PLAN IS PRANCEMENTS, AND PLANS INDICATED OR REPRESENTED BY THIS DRAWING ARE OWNED BY. AND THE PROPERTY OF THIS OFFICE. AND THE DRAWING ARE OWNED BY ON CONSTRUCTOR WITH THE SPECIFED PROJECT (NOS OF SUPULDES, DESIGNA), FRAN, OR CORPORATION FOR HAVE SHALL BE USED BY, OR DISCLOGED TO ANY PERSON, FRAN, OR CORPORATION FOR HAVE DESIGNATIONS SHALL BE USED BY, OR DISCLOGED TO ANY PERSON, FRAN, OR SCALE OWNERSONS OF THE OFFICE OFFICE AND BY THE ORDER AND THE OFFICE FOR A PROPOCEEDING WITH FABRICATERON ON THE AS ON WITH THE STAN THE ORDER AND THE SON BOTH TO THIS OFFICE FOR APPROVAL BEFORE PROCEEDING WITH FABRICATERON ON THE AS ON WITH THE OFFICE FOR APPROVAL BEFORE PROCEEDING WITH FABRICATED ON WITH FABRICATED ON WITH THE DEFORM THE SOLID WITH THE SON WITH THE DEFORM THE SOLID WITH THE SON WITH THE S

Revisions # Date CITY COMMENTS 1 6/6/23

A NEW HOME BY ZERO LATITUDE HOMES

HIDEAWAY SPEC HOME

OT 7 - SOUTH HARBOR DR., VERO BEACH, I



Date	02-10-20
Project #	22-026
Drawn by	FVC
Checked by	JH/DS
Reviewed by Interior Design	YES





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14. GFI OUTLETS LOCATION OUTDOORS ARE TO BE WATERPROOF & TAMPER-RESISTANT

15. GIF OUTLEST LOCATED IN GARAGES, KITCHENS, AND BATHROOMS, SHALL BE TAMPER-PROOF.

16. ALL DETECTORS SHALL BE SMOKE/CARBON MONOXIDE COMBO, AND SHALL BE HARDWIRED AND INTERCONNECTED WITH BATTERY BACKUP, AND SHALL BE INSTALLED PER NFPA 72.29.8.3.4 - IN NO CASE SHALL MORE THAN 18 INITIATING DEVICES BE INTERCONNECTED OF WHICH 12 CAN BE SMOKE ALARMS WHERE THE INTERCONNECTING MEANS IS NOT SUPERVISED. PER NFPA 72.29.8.2 HOMES WITH A LARGE NUMBER OF BEDROOMS WHERE MORE THAN 12 SMOKE ALARMS OR CARBON MONOXIDE ALARM COMBINATION, WILL REQUIRE A SEPARATE PERMIT FOR A FIRE ALARM SYSTEM.

17. ELECTRICAL METER AN PANEL LOCATION MAY VARY AS PER SERVICE ENTRANCE LOCATION.

#### 18. ALL WIRING TO BE COPPER.

CONNECT TO GROUND

19. IF CHOSEN BY OWNER, CONTRACTOR TO VERIFY LOCATION OF E.C.P. 240V ELECTRIC TO BE INSTALLED PER MANUFACTURER'S SPECIFICATIONS. VERIFY CHARGING STATION SPECIFICATIONS MATCH OWNERS VEHICLES.

NOTE: THIS DIAGRAMMATIC PLAN IS INTENDED TO SHOW LIGHTING AND CONVENIENCE OUTLETS ONLY. ZERO LATITUDE INC. WILL BEAR NO RESPONSIBILITY FOR IT'S ACCURACY. IT IS THE ELECTRICAL CONTRACTOR'S RESPONSIBILITY TO VERITY THE REQUIREMENTS AND LOCATIONS OF ALL ELECTRICAL EQUIPMENT AND PROVIDE AND INSTALL COMPLETE ELECTRICAL SERVICES AS REQUIRED PRIOR TO COMMENCING WITH ANY INSTALLATION. ELECTRICAL CONTRACTOR TO SUBMIT PLAN AND PULL PERMIT.

#### FIRE-SMOKE ALARM SYSTEM

#### NFPA 72 29.5.1.3.1

All points on the ceiling shall have a smoke alarm within a distance of 30 ft (9.1 m) travel distance or shall have an equivalent of one smoke alarm per 500 ft2 (46 m2) of floor area.

**29.5.1**.1 - Where required by other governing laws, codes, or standards for a specific type of occupancy, approved single and multiple-station smoke alarms shall be installed as follows:

(2) In all sleeping rooms and guest rooms (2) Outside of each separate dwelling unit sleeping area, within 21 ft. of any door to a sleeping room, with the distance measured along a path of travel (3) On every level of a dwelling unit, including

(4) On every level of a residential board and care occupancy (small facility), including basements and excluding crawl spaces and unfinished attics (5) In the living area(s) of a guest suite (6) In the living area(s) of a residential board and care occupancy (small facility)

ELECTRICAL CONTRACTOR AND OR SECURITY SYSTEMS CONTRACTOR SHALL BE RESPONSIBLE TO ENSURE

EQUIPPED WITH AN EXIT ALARM THAT HAS A MINIMUM

SOUND PRESSURE RATING OF 85 DECIBELS AT 10 FEET,

STATUTES SECTIONS 515.21 - 515.37, THE RESIDENTIAL

THAT ALL DOORS AND WINDOWS PROVIDING DIRECT

ACCESS FROM THE HOME TO THE POOL WILL BE

PER THE REQUIREMENTS DESCRIBED IN FLORIDA

**SECURITY SYSTEM** 

SWIMMING POOL SAFETY ACT.

**29.5.1.2** - Where the area addressed in 29.5.1.1(2) is separated from the adjacent living areas by a door, a smoke alarm shall be installed in the area between the door and the sleeping rooms, and additional alarms shall be installed on the living area side of the door as specified by 29.5.1.1 and 29.5.1.3.

**29.5.1.3** - In addition to the requirements of 29.5.1.1(1) through (3), where the interior floor area for a given level of a dwelling unit, excluding garage areas, is greater than 1000 ft2 smoke alarms shall be installed per 29.5.1.3.1 and 29.5.1.3.2.

**29.5.1.3.1** - All points on the ceiling shall have a smoke alarm within a distance of 30 ft. travel distance or shall have an equivalent of one smoke alarm per 500 ft2 of floor area. One smoke alarm per 500 ft2 is evaluated by dividing the total interior square footage of floor area per level by 500 ft2

**29.5.1.3.2** - Where dwelling units include great rooms or vaulted/cathedral ceilings extending over multiple floors, smoke alarms located on the upper floor that are intended to protect the aforementioned area shall be permitted to be considered as part of the lower floor(s) protection scheme used to meet the requirements of 29.5.1.3.1.

29.5.2.1.1 - Smoke and Heat Alarms. Unless exempted by applicable laws, codes, or standards, smoke or heat alarms used to provide a fire-warning function, and when two or more alarms are installed within a dwelling unit, suite of rooms, or similar area, shall be arranged so that the operation of any smoke or heat alarm causes all alarms within these locations to

NOTE: A SUPERVISED FIRE ALARM SYSTEM IS REQUIRED TO BE INSTALLED PER NFPA 72.29.8.2 - A SEPARATE FIRE ALARM PERMIT IS REQUIRED. THE SYSTEM DESIGN, PERMIT APPLICATION AND INSTALLATION IS THE RESPONSIBILITY OF THE FIRE ALARM SYSTEM COMPANY. ZERO LATITUDE INC. WILL BEAR NO RESPONSIBILITY FOR IT'S ACCURACY.

WD. STUD

BEARING

STUD

THIS DIAGRAMMATIC PLAN IS INTENDED TO SHOW LIGHTING AND CONVENIENCE OUTLETS ONLY. ZERO LATITUDE WILL BEAR NO RESPONSIBILITY FOR IT'S ACCURACY. IT IS THE ELECTRICAL CONTRACTOR'S RESPONSIBILITY TO VERIFY THE THE REQUIREMENTS AND LOCATIONS OF ALL ELECTRICAL EQUIPMENT AND PROVIDE AND INSTALL COMPLETE ELECTRICAL SERVICES AS REQUIRED. ELECTRICAL CONTRACTOR TO SUBMIT PLAN AND PULL PERMIT.

# 8'-1 3/4" WALL KEYNOTE

ELECTRICAL 2ND FLOOR PLAN

NUMBER OF SMOKE DETECTORS PER CODE: 2,028 / 500 = 4


SMOKE DETECTORS REQUIRED - 7 PROVIDED

#### ELECTRICAL SYMBOLS LEGEND

ELECTRIC METER


	ELECTRIC PANEL
DISC	ELECTRICAL - A/C DISCONNECT
$\Leftrightarrow$	DUPLEX OUTLET
FO	FLOOR OUTLET LOCATE PER OWNERS / BUILDER
$\ominus$	DUPLEX OUTLET -HALF SWITCHED
⇒ WP	WEATHER PROOF DUPLEX OUTLET
⊕ G.F.I.	G.F.I DUPLEX OUTLET
<b>=</b>	220 VOLT RECEPTACLE
-[≥]	TELEVISION JACK
$\triangleleft$	CAT 6 NETWORK
V	CENTRAL VACUUM HOSE OUTLET
$\Theta$	WALL SWITCH
$\leftrightarrow^{\circ}$	3-WAY WALL SWITCH
$\Theta_4$	4-WAY WALL SWITCH
$\Theta^{\square}$	DIMMER WALL SWITCH
-•	PUSH BUTTON WALL SWITCH
-	CEILING MOUNTED LIGHT FIXTURE
$\vdash$	WALL MOUNTED LIGHT FIXTURE
J	JUNCTION BOX
$\overline{\nabla}$ $\overline{\nabla}$	TRACK LIGHTING
	HANGING LIGHT FIXTURE
	RECESSED LIGHT FIXTURE
<b>€</b> →	RECESSED HIGHLIGHTING LIGHT FIXTURE
V.P.	VAPOR RESISTANT RECESSED LIGHT FIXTURE
EXT.	EXTERIOR RECESSED LIGHT FIXTURE
	4' LONG FLUORESCENT LIGHT FIXTURE
	52" CEILING FAN WITH LIGHT
	FLOOD LIGHT
T	THERMOSTAT
FACP	FIRE ALARM CONTROL PANEL
SD	SMOKE DETECTOR
CMD	SMOKE & CARBON MONOXIDE DETECTOR
€ <sub>E.F.</sub>	EXHAUST FAN CFM MIN 80
<b>+</b>	CEILING OUTLET
-	NEMA 14-50 (220V) ELECT CAR CHARGER OUTLE
	GARAGE DOOR POWER BUTTON
	DOORBELL BUTTON
	LED GARAGE, DEFORMABLE TRIPLE LIGHT
СН	DOORBELL CHIME
● W.H. ●	INSTA-HOT EXTERIOR WATER HEATER

SMOKE DETECTOR GOES INSIDE BEDROOMS SMOKE & CARBON MONOXIDE DETECTOR GOES IN COMMON AREAS

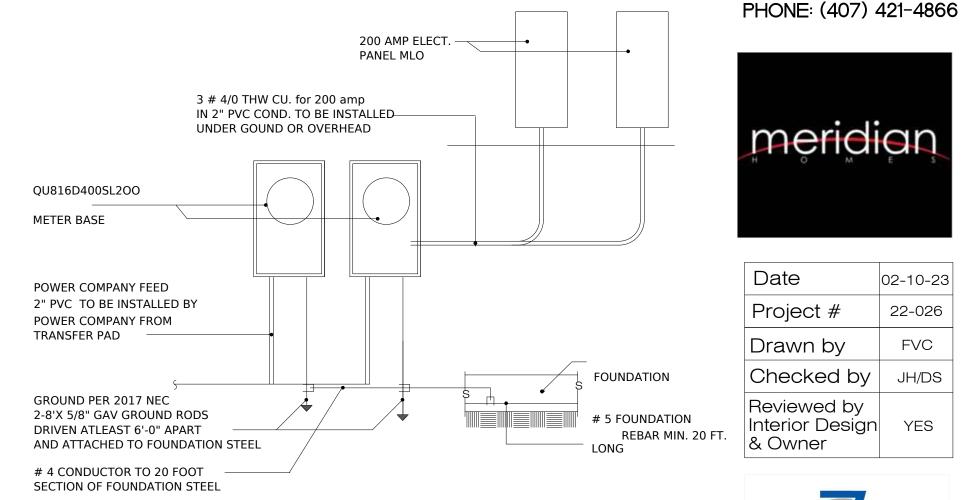

400 AMP. ELECTRICAL RISER DIAGRAM / FOR REFERENCE ONLY

DESIGN WITH AN ELECTRICAL RISER DIAGRAM AND LOAD CALCULATIONS IS THE RESPONSIBILITY OF THE ELECTRICAL CONTRACTOR, AND SHALL VERIFY PANEL AMPERAGE IS CORRECT PRIOR TO COMMENCING ANY ELECTRICAL WORK.

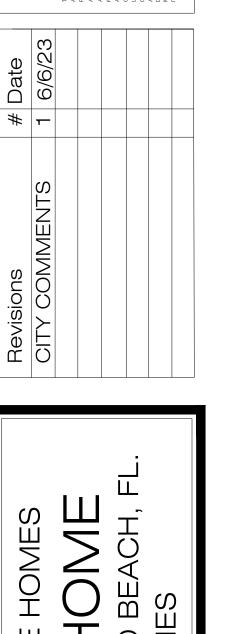

DANIEL SOUTER, P.E. P.E.# 63901 P.O. BOX 547774

ORLANDO, FL 32854

02-10-23 Project # 22-026 Drawn by Checked by JH/DS Reviewed by Interior Design YES

