



ROOF FRAMING PLAN
SCALE: 1/4" - 1'-0"

SCALE: 1/4" = 1'-0"

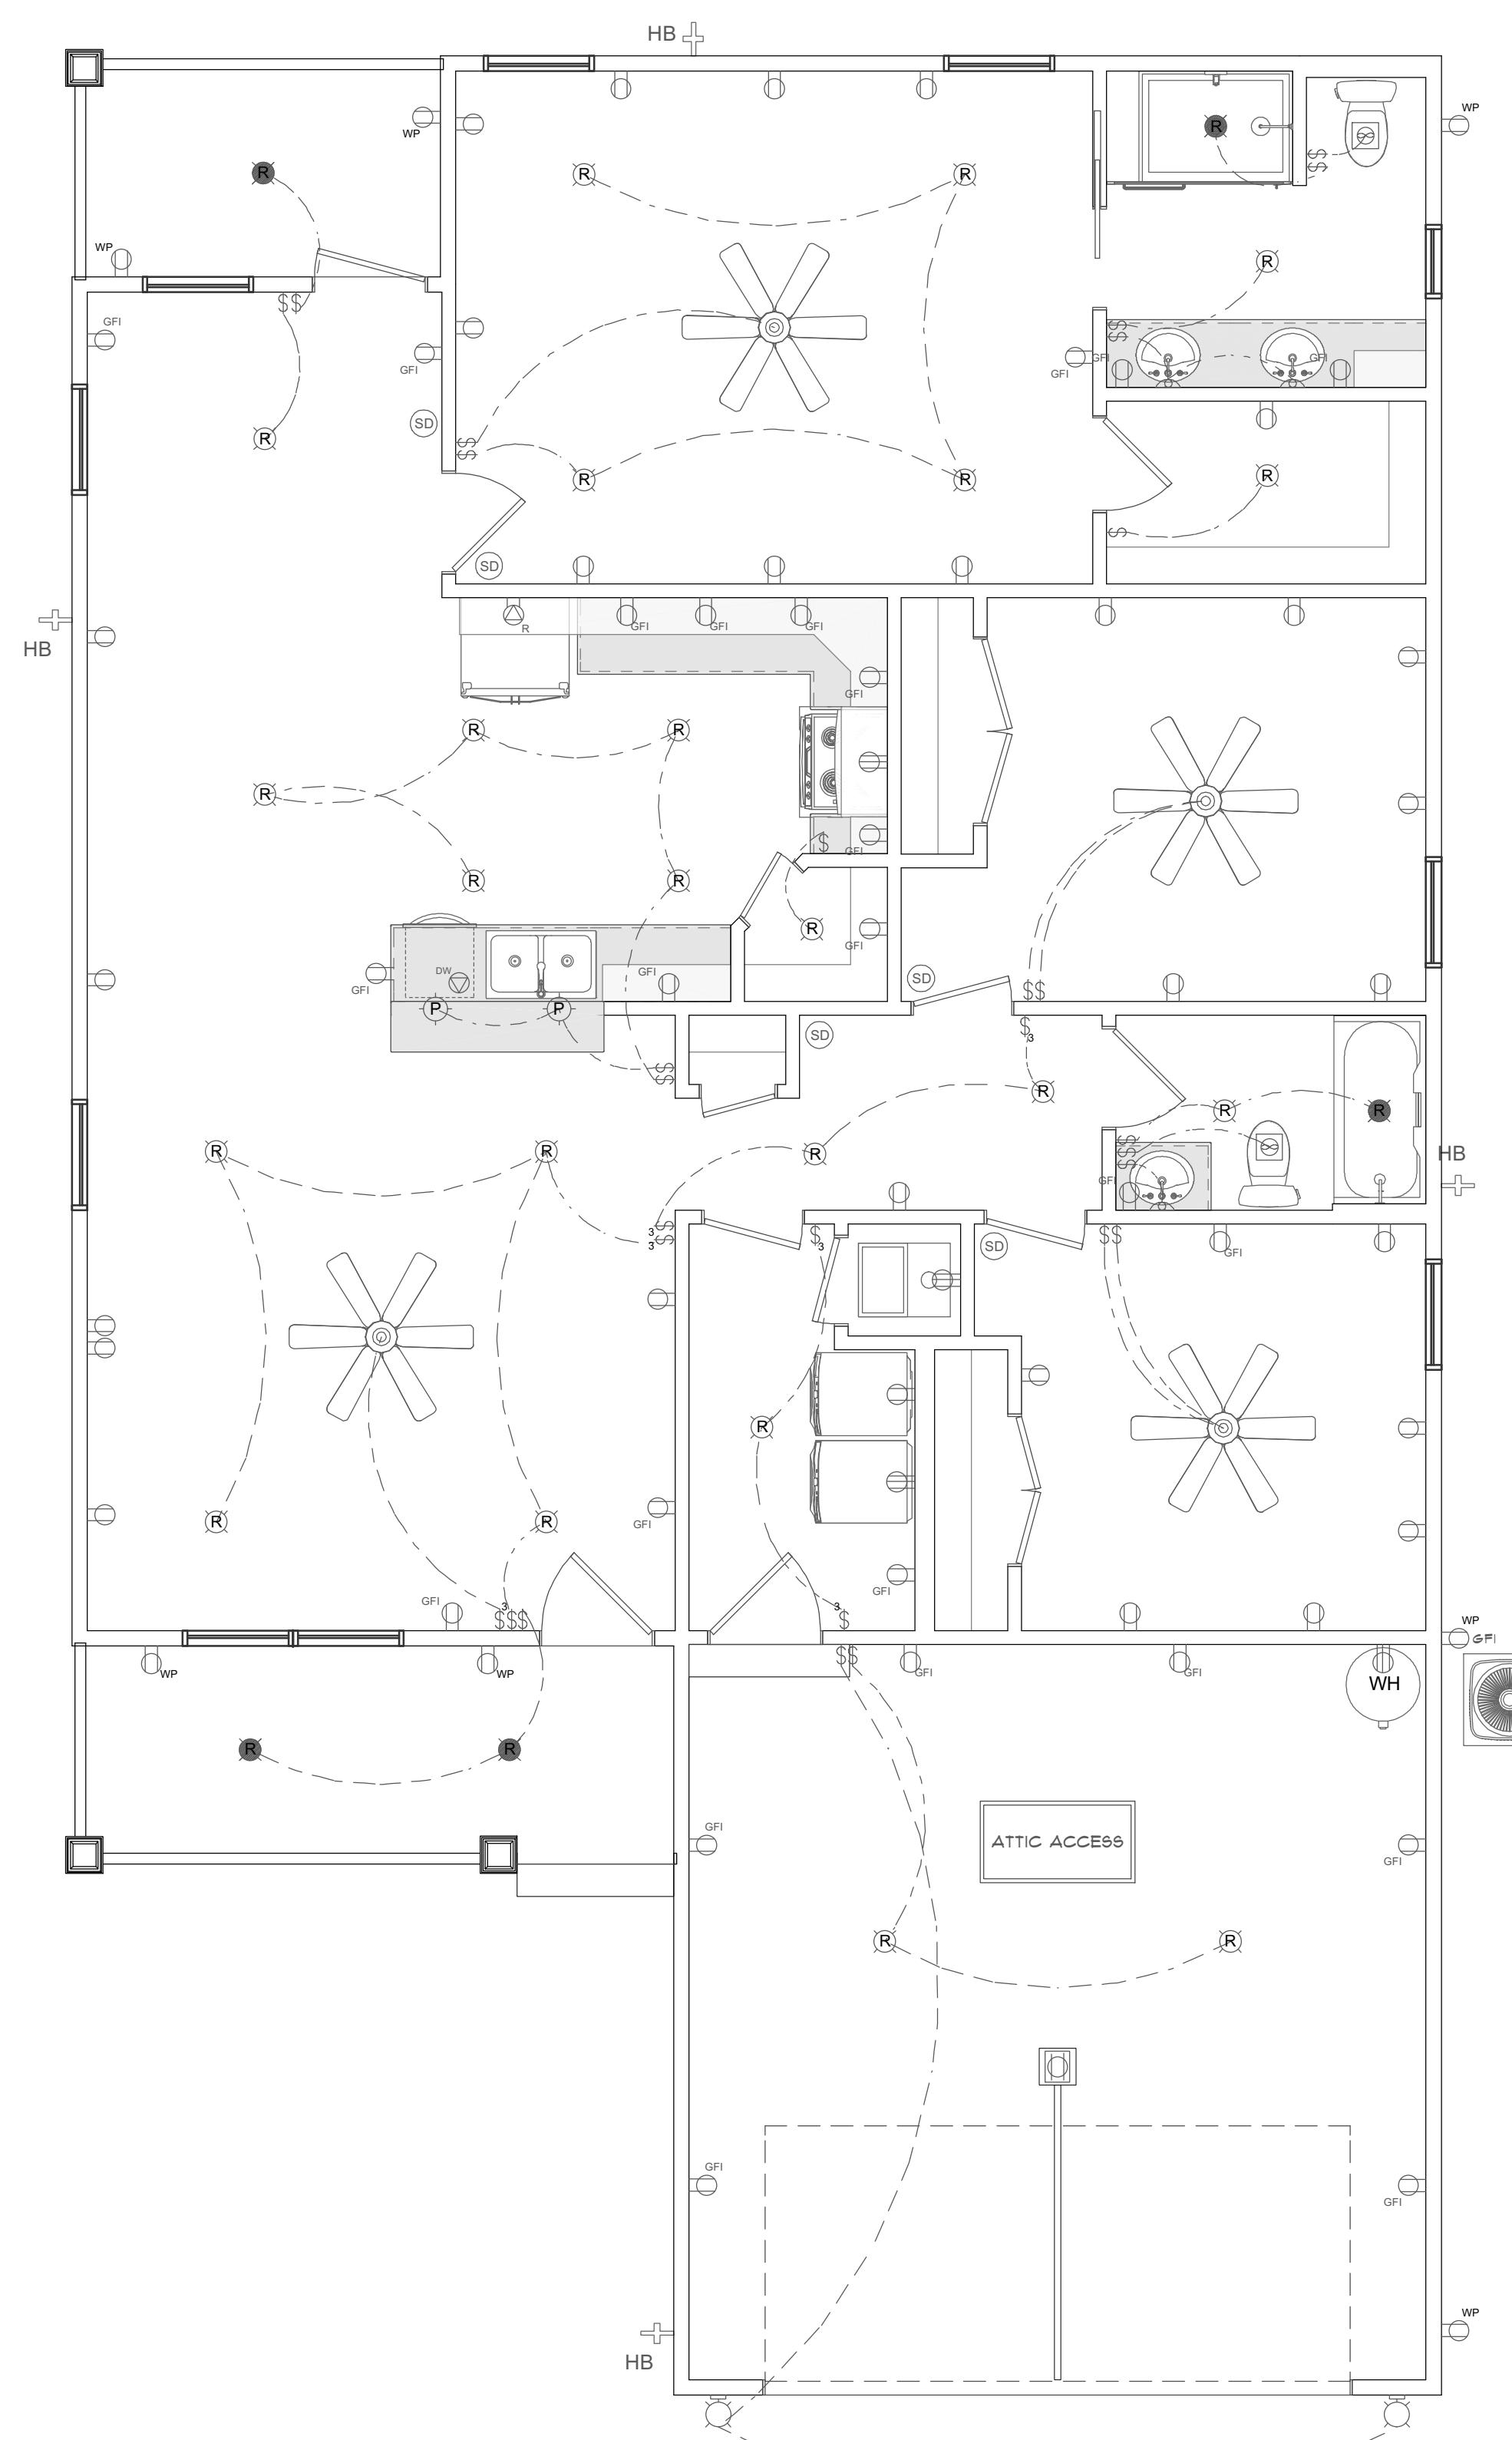


ELECTRICAL PLAN

SCALE: 1/4" = 1'-0"

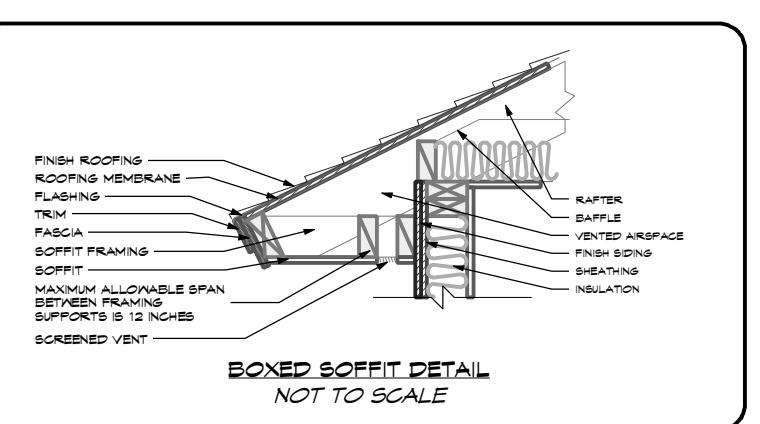

ROOF FRAMING PLAN NOTES:

1. THE ROOF SYSTEM WILL BE CONSTRUCTED WITH PRE-ENGINEERED TRUSSES. THE TRUSSES SHALL BE DESIGNED (AND THE TRUSS DRAWINGS SHALL BE SIGNED AND SEALED) BY A PROFESSIONAL ENGINEER WHO IS LICENSED IN THE STATE OF FLORIDA. THE TRUSSES SHALL BE DESIGNED FOR A 150 M.P.H. WIND SPEED (ULTIMATE).
2. THE ROOF OVERHANGS SHALL BE 16", U.N.O.

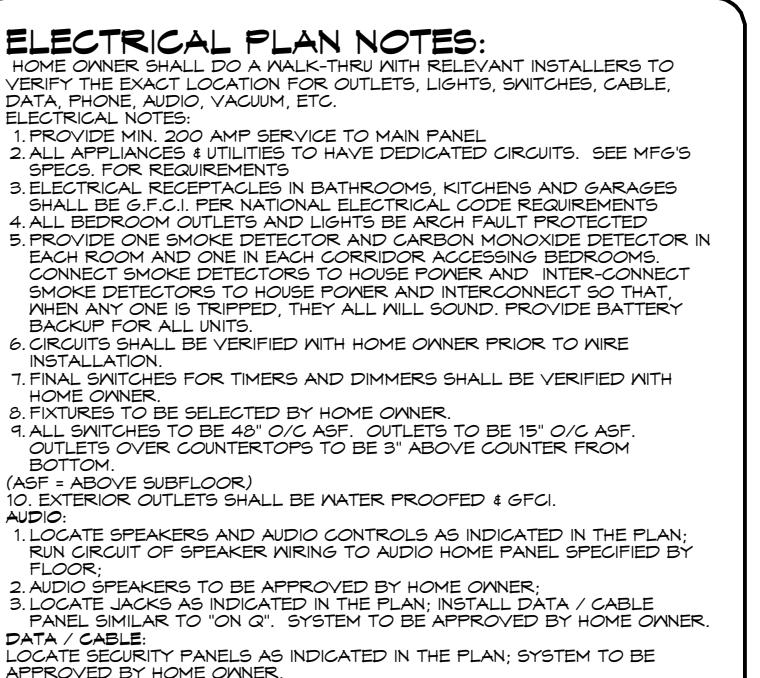

ELECTRICAL LEGEND

LIGHTING	
   	PENDANT / RECESSED / WET RATED / FLUSH MOUNT
  	DUAL SPOTLIGHT / SCONCE / WALL LAMP
  	UNDER CABINET LED PUCK / LED STRIP / CEILING LED
 	CHANDELIER / FAN W/ LIGHT
SWITCHES / OUTLETS	
  	SWITCH / 3-WAY / 4-WAY
   	OUTLETS - 120V WALL & CEILING GFCI / WATER PROOF / 220V
  	APPLIANCE SPEC.: REFRIGERATOR / DISH WASHER / GARBAGE DISPOSAL
OTHER MEP	
	SMOKE / CARBON MONOXIDE DETECTOR COMBINATION
 	CEILING MOUNTED VENTILATION FAN/ VENTILATION FAN W/ LIGHT

100

S.H.S. CONTRACTING SERVICES, LLC
LOT 35 BLOCK Q E. MICHAELANGELO RD.,
DEFUNIAK SPRINGS
ROOF FRAMING PLAN & ELECTRICAL PLAN
WALTON COUNTY, FLORIDA

SCALE:

DRAWN:

CHECKED:

PROJECT NO:
25590.20


25590.20.PLAN

DATE:

FINAL

SHEET NUMBER

A-3

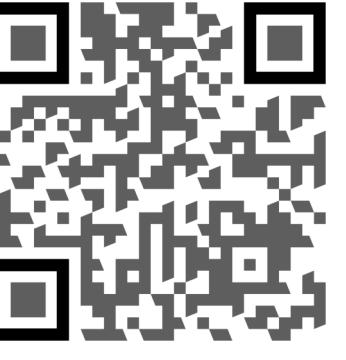

**BAYSIDE ENGINEERING
& CONSULTING, LLC**


GRANDVIEW DRIVE, SHALIMAR, FL 32574


PHONE: (850)982-7515
MAIL: JOE.BASS@BAYSIDE-ENG.COM


ENGINEERING FIRM REGISTRY NO. 34567
J.D. BASS, P.E. LICENSE NO. 78460

WHILE EVERY ATTEMPT HAS BEEN MADE IN THE PREPARATION OF THIS PLAN TO AVOID MISTAKES, THE PREPARER CANNOT GUARANTEE AGAINST HUMAN ERROR. THE CONTRACTOR ON THE JOB SITE MUST CHECK ALL DIMENSIONS AND OTHER DETAILS FOR ACCURACY BEFORE AND DURING CONSTRUCTION, AND BE RESPONSIBLE FOR THE SAME.

S.H.S. CONTRACTING SERVICES, LLC
LOT 35 BLOCK Q E. MICHAELANGELO RD.,
DEFUNIAK SPRINGS
ROOF FRAMING PLAN & ELECTRICAL PLAN
WALTON COUNTY, FLORIDA

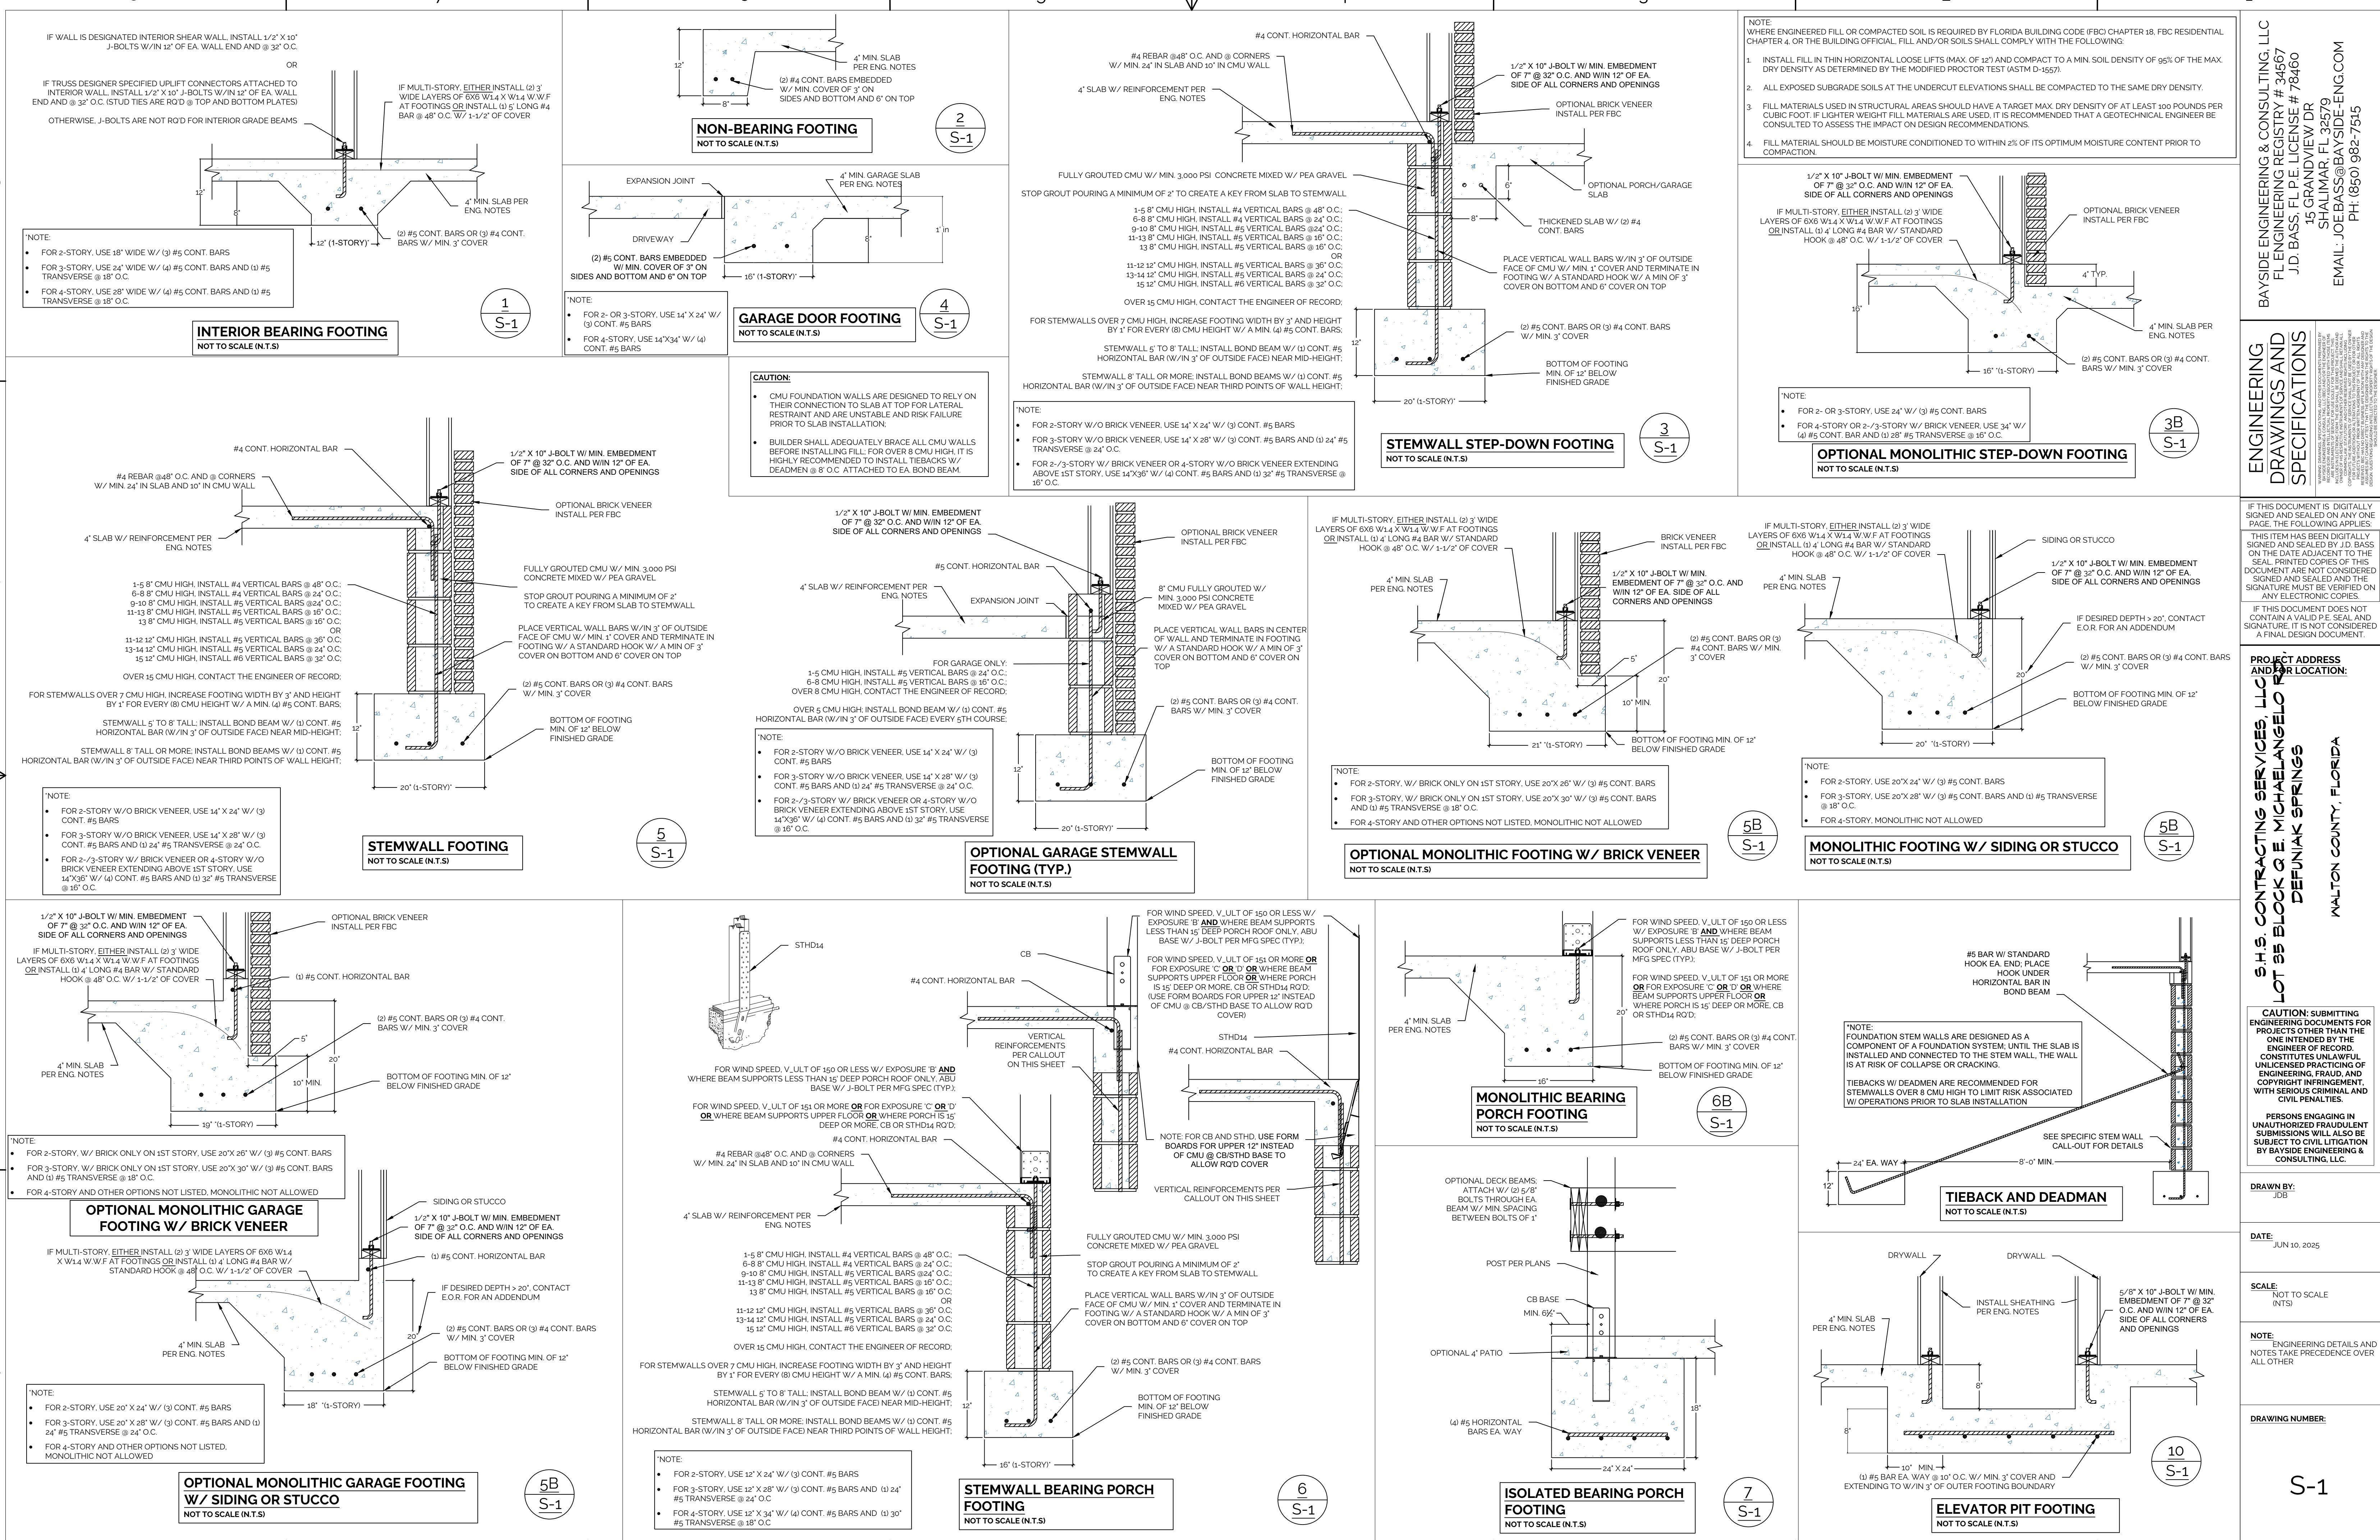

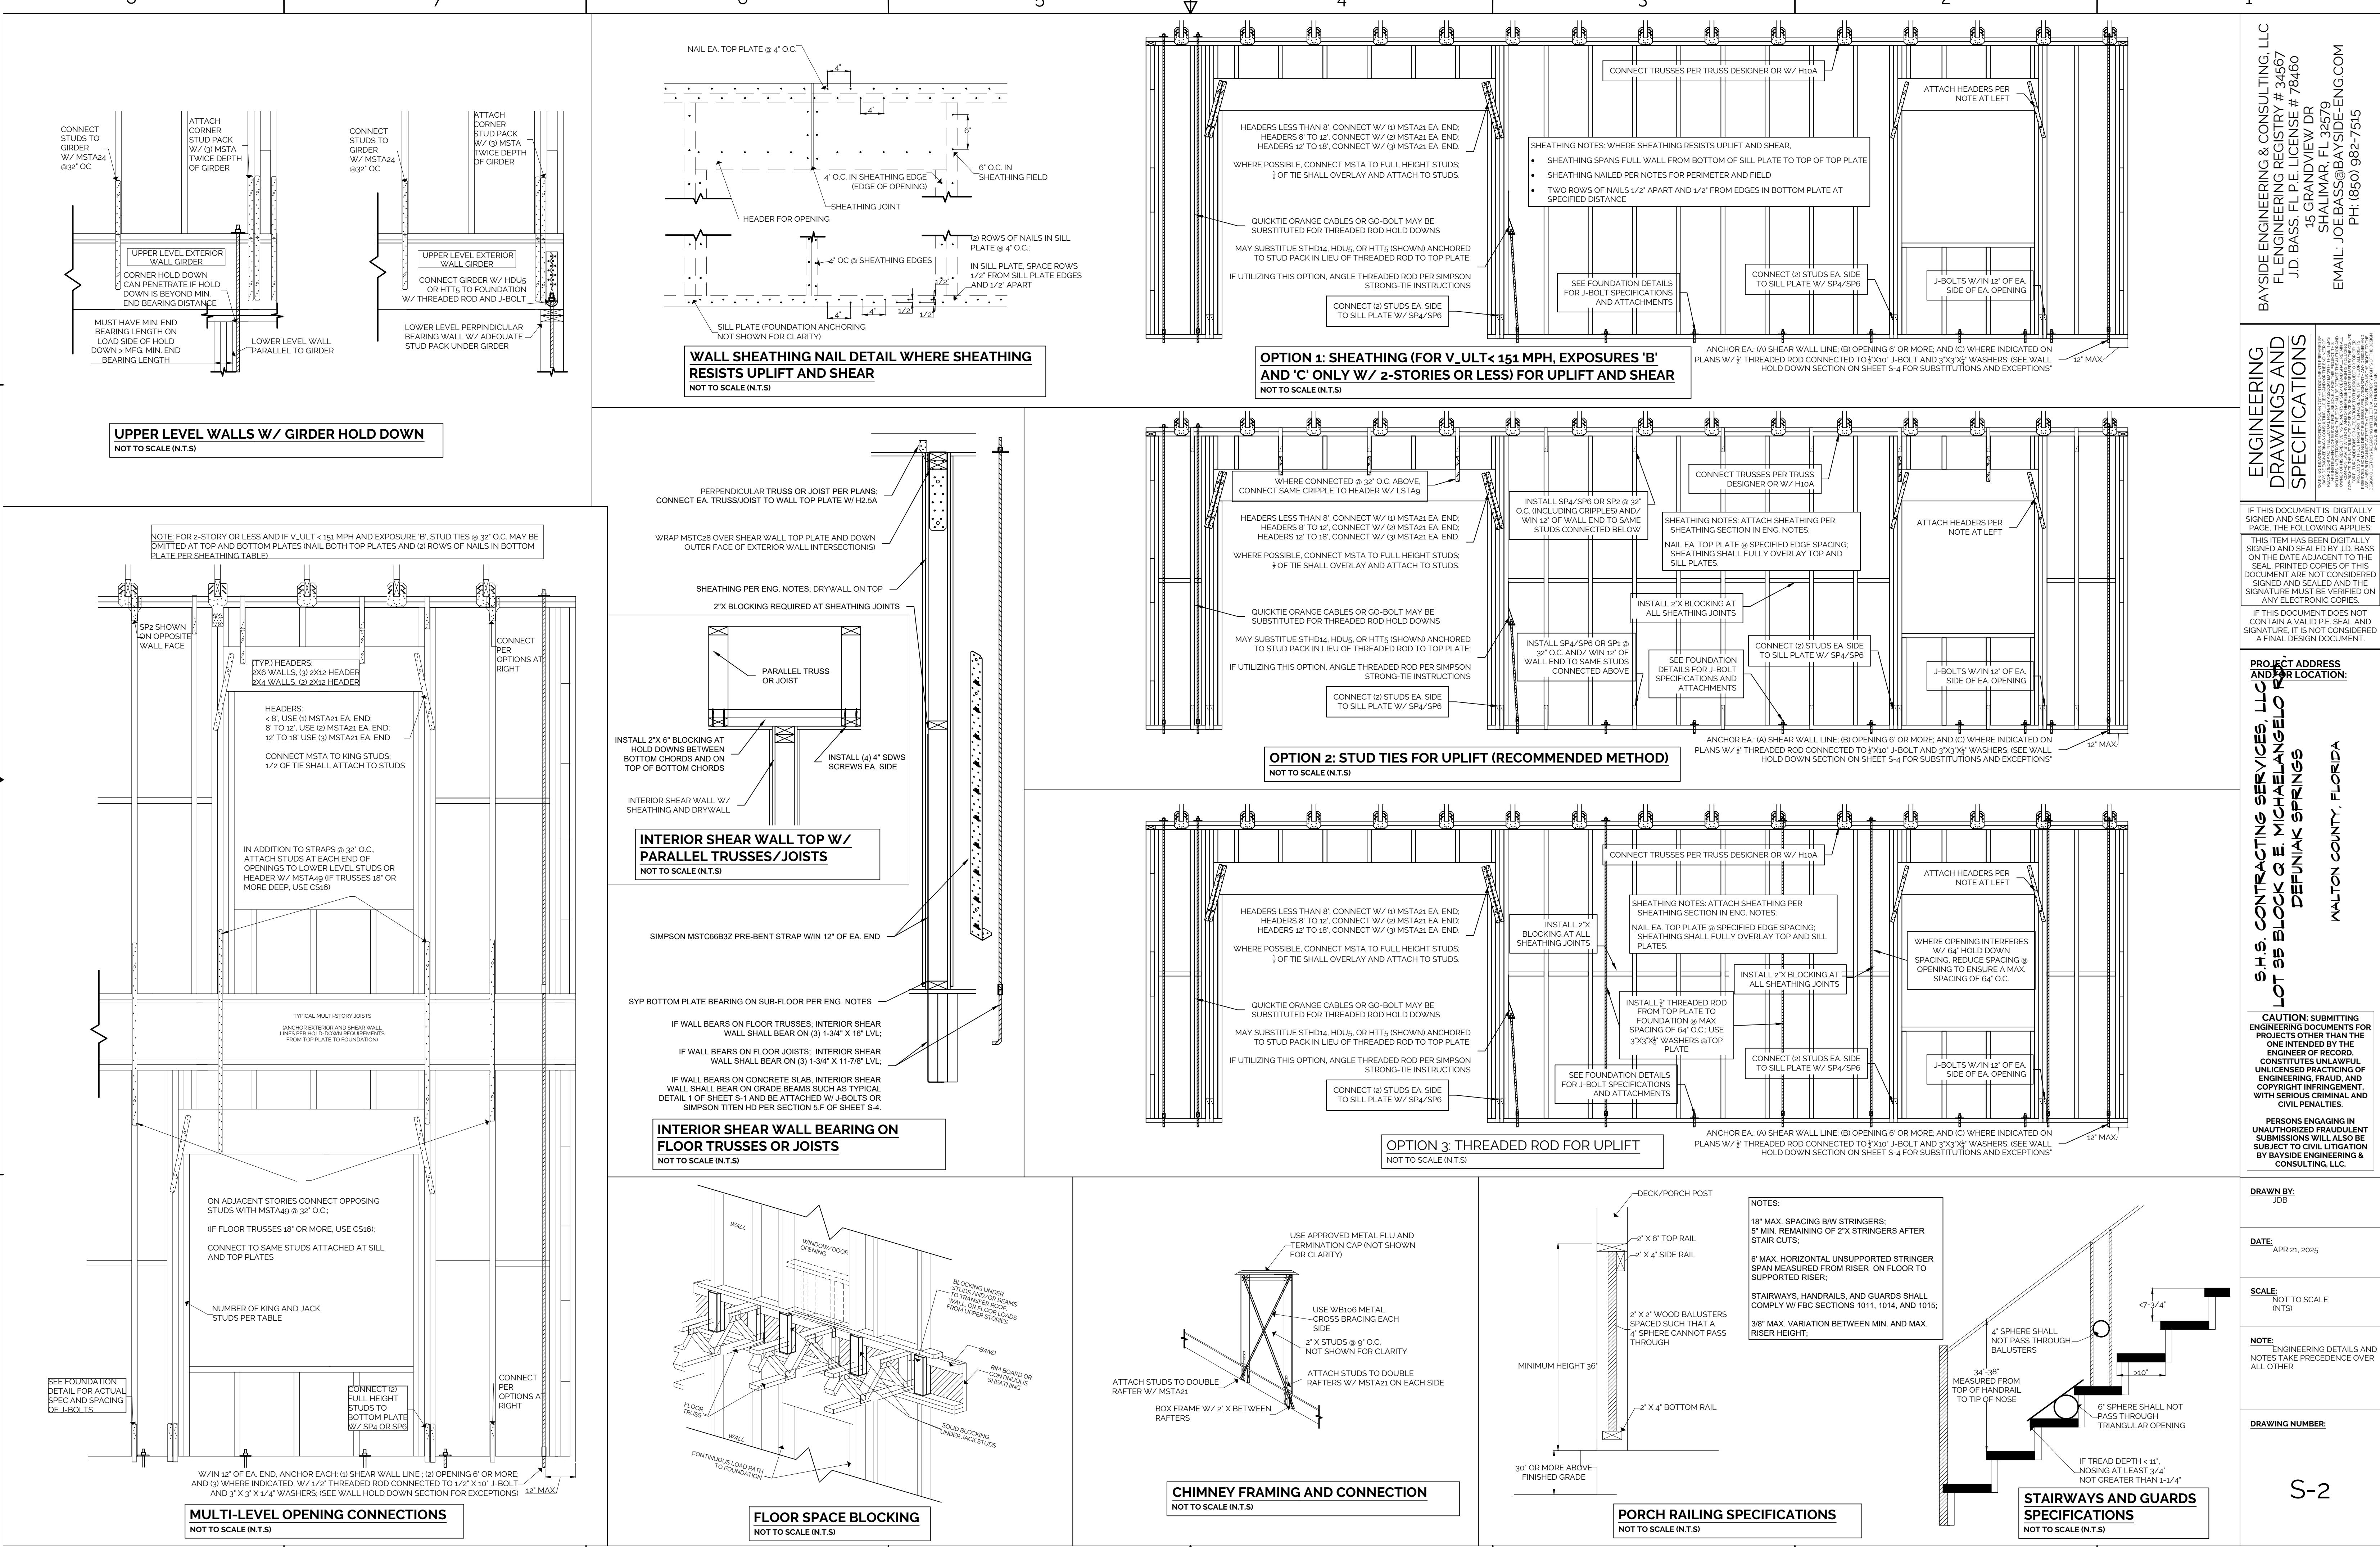

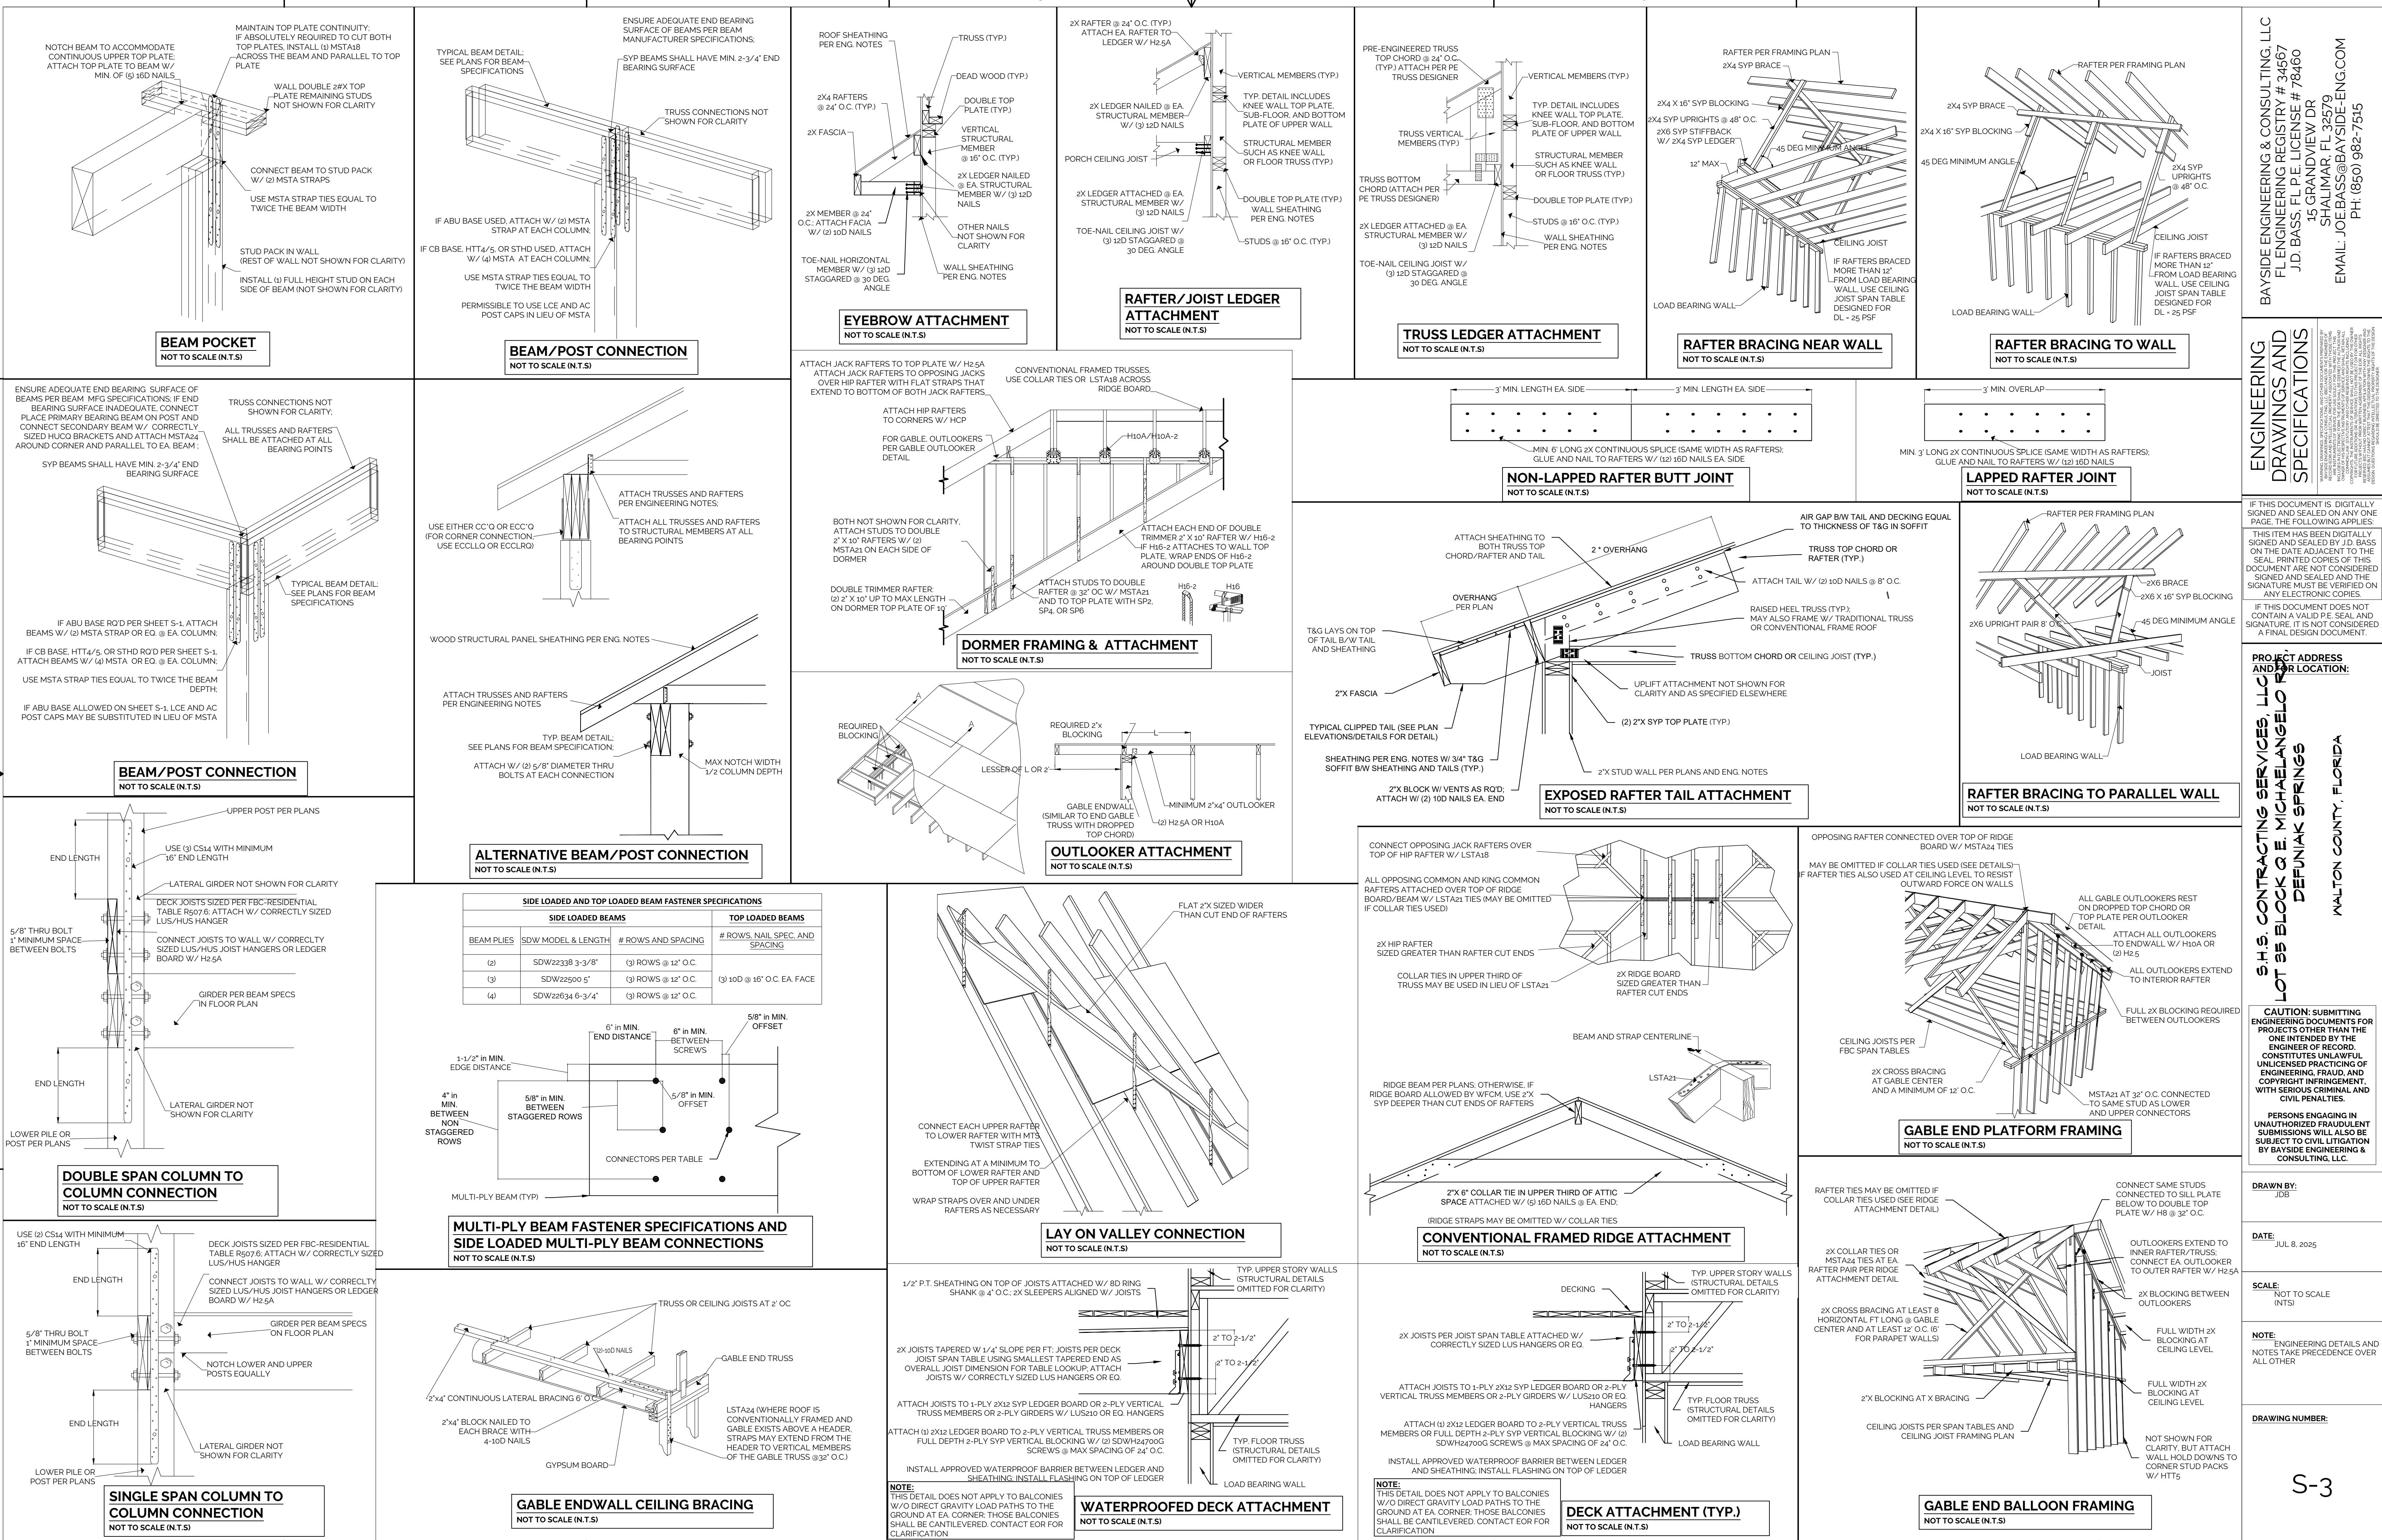

BAYSIDE ENGINEERING & CONSULTING, LLC
FL ENGINEERING REGISTRY # 3467
JD. BASS, P.E. LICENSE # 78460
15 GRANDVIEW DR
SHALIMAR, FL 32579
PH: (850) 982-7515
EMAIL: JOE.BASS@BAYSIDE-ENG.COM

ENGINEERING
DRAWINGS AND
SPECIFICATIONS

IF THIS DOCUMENT IS DIGITALLY
SIGNED AND SEALED ON ANY ONE
PAGE, THE FOLLOWING APPLIES:
THIS ITEM HAS BEEN DIGITALLY
SIGNED AND SEALED. PLEASE ACCESS
THE DATE ADJACENT TO THE
SEAL. PRINTED COPIES OF THIS
DOCUMENT ARE NOT CONSIDERED
SIGNED. THE DIGITAL SIGNATURE
MUST BE VERIFIED ON
ANY ELECTRONIC COPIES.

IF THIS DOCUMENT DOES NOT
CONTAIN A VALID P.E. SEAL AND
SIGNATURE, IT IS NOT CONSIDERED
A FINAL DESIGN DOCUMENT.

PROJECT ADDRESS
AND/or LOCATION:

SHS CONTRACTING SERVICES, LLC
LOT 35 BLOCK Q E. MICHAELANGELO
DEFUNAK SPRINGS
WALTON COUNTY, FLORIDA

CAUTION: SUBMITTING
ENGINEERED DOCUMENTS FOR
PROJECTS NOT RELATED TO THE
ONE INTENDED BY THE
ENGINEER OF RECORD,
CONSTITUTES UNLAWFUL
UNLAWFUL PRACTICE OF
ENGINEERING, FRAUD, AND
COPYRIGHT INFRINGEMENT,
WITH SERIOUS CRIMINAL
AND CIVIL PENALTIES.
PERSONS ENGAGING IN
UNAUTHORIZED SUBMISSION
WILL ALSO BE SUBJECT TO CIVIL LITIGATION
BY BAYSIDE ENGINEERING &
CONSULTING, LLC.

DRAWN BY:
JDB

DATE:
JUL 8, 2025

SCALE:
NOT TO SCALE
(N.T.S.)

NOTE:
ENGINEERING DETAILS AND
NOTES TAKE PREDENCE OVER
ALL OTHER

DRAWING NUMBER:
S-3

SECTION 1. - DESIGN CRITERIA

A. CONSTRUCTION SHALL COMPLY WITH ALL THE FOLLOWING CODES AND GUIDANCE DOCUMENTS

- 2023 FLORIDA BUILDING CODE, RESIDENTIAL (FBC-R), 8TH EDITION
- AWC WOOD FRAME CONSTRUCTION MANUAL FOR ONE- AND TWO-FAMILY DWELLINGS, LATEST EDITION
- AWC SPECIAL DESIGN PROVISIONS FOR WIND AND SEISMIC (SDPWS), LATEST EDITION
- AITC TIMBER CONSTRUCTION MANUAL, LATEST EDITION
- ACI CODE REQUIREMENTS FOR RESIDENTIAL CONCRETE, LATEST EDITION (ACI 332)
- ACI BUILDING CODE REQUIREMENTS AND SPECIFICATIONS FOR MASONRY STRUCTURES, LATEST EDITION (TMS 402/602)
- ACI BUILDING CODE REQUIREMENTS FOR STRUCTURAL CONCRETE, LATEST EDITION (ACI 318)
- CRSI PLACING REINFORCING BARS, LATEST EDITION

B. DESIGN LOADS

GENERAL		FLOOR TRUSS DESIGN LOADS		ROOF TRUSS DESIGN LOADS	
FLOOR	40 PSF	TCLL	40 PSF	TCLL	20 PSF
DECKS	40 PSF	TCDL	15 PSF	TCDL	15 PSF (SHINGLES AND METAL) 35 PSF (CLAY, TILE, ETC.)
BALCONIES	40 PSF	BCLL	0 PSF	BCLL	0 PSF (EXCEPTIONS PER FBC TABLE R301.5)
ROOF	20 PSF	BCDL	10 PSF	BCDL	10 PSF

NOTE: AS NOTED ON FLOOR PLANS, INTERIOR SHEAR WALLS BEARING ON FLOOR TRUSS SYSTEMS SHALL BEAR ON FULL LENGTH (3) 1/3-4" X 16" LVL'S

C. MAIN WIND FORCE RESISTING SYSTEM (MWFRS) DESIGN ASSUMPTIONS

ULTIMATE DESIGN WIND SPEED, V_{ULT}	149 MPH (F WALTON COUNTY, BY INTERPOLATION)
IMPORTANCE FACTOR	1
RISK CATEGORY	II
EXPOSURE CATEGORY	B
INTERNAL PRESSURE COEFFICIENT	-0.18 TO +0.18
BUILDING TYPE	ENCLOSED
MEAN ROOF HEIGHT	40'

D. MAIN WIND FORCE RESISTING SYSTEM (MWFRS) DESIGN METHOD - DIRECTIONAL PROCEDURE:

ZONE	CONDITION	SIDE	PSF
WALL	WORST CASE: (GC _W) 4 th STORY (WHERE APPLICABLE)	WINDWARD	
WALL	WORST CASE: (GC _W) 3 rd STORY (WHERE APPLICABLE)	WINDWARD	30.49
WALL	WORST CASE (GC _W) 2 nd STORY (WHERE APPLICABLE)	WINDWARD	28.11
WALL	WORST CASE (GC _W) 1 st STORY	WINDWARD	25.93
ROOF	WORST CASE: NORMAL TO RIDGE	LEEWARD	-27.02
OVERHANG	WORST CASE: NORMAL TO RIDGE	LEEWARD	-46.60

E. ALL COMPONENTS AND CLADDING SHALL COMPLY WITH THE FOLLOWING DESIGN PRESSURES CONSISTENT WITH FBC, RESIDENTIAL TABLE R301.2(2) AND FIGURE R301.2(7):

ZONES PER FIGURE R301.2(7)	EFFECTIVE WIND AREA (SQ.FT.)	LOADS (PSF)
1	ALL	17.3
2	ALL	17.3
3	ALL	17.3
188	ALL	17.3
189	ALL</td	