



**BAYSIDE ENGINEERING  
& CONSULTING, LLC**

WHILE EVERY ATTEMPT HAS BEEN MADE IN THE PREPARATION OF THIS PLAN TO AVOID MISTAKES, THE PREPARER CANNOT GUARANTEE AGAINST HUMAN ERROR. THE CONTRACTOR ON THE JOB SITE MUST CHECK ALL DIMENSIONS AND OTHER DETAILS FOR ACCURACY BEFORE AND DURING CONSTRUCTION, AND BE RESPONSIBLE FOR THE SAME.

A NEW PLAN FOR:  
**S.H.S. CONTRACTING, LLC**  
**LOTS 5 & 6 BLOCK 2 WATSON RD.,**  
**DEFUNIAK SPRINGS**  
**ELEVATIONS**  
WALTON COUNTY, FLORIDA

LOTS 5 & 6  
MIBINDED

<u>SCALE:</u> 1/4" = 1'-0"	
<u>DRAWN:</u> MDC	
<u>CHECKED:</u> JDB	
<u>PROJECT NO.:</u> 25590.21	
<u>CAD FILE:</u> 25590.21.PLAN	
<u>DATE</u>	<u>REVISION</u>

11/24/2023

**FINAL**

**SHEET NUMBER**

**A-1**

## STREET INDEX

**ELEVATIONS**  
**FLOOR PLAN & FOUNDATION PLAN**  
**ROOF FRAMING & ELECTRICAL PLAN**  
**STRUCTURAL SHEET**  
**STRUCTURAL SHEET**  
**STRUCTURAL SHEET**  
**STRUCTURAL SHEET**

## ABBREVIATIONS

ITIONG	HVAC	HEATING, VENTILATING, AND
LD UNIT	HRZ	HORIZONTAL
N WIRE GAUGE	HR	HOUR
TEVISION	LO	IN LIEU OF
HEIGHT	INT	INTERIOR
LINE	K	KIP (1,000 POUNDS)
BREAKER	LAM	LAMINATED
TE MASONRY UNIT	LTG	LIGHTING
H OR DEMOLITION	MECH	MECHANICAL
R	MIN	MINIMUM
ON	MICRO	MICROWAVE
SWITCH	NO	NUMBER
S	OC	ON CENTER
ON	OH	OVERHANG
CAL	PSF	POUNDS PER SQUARE FOOT
R	PSI	POUNDS PER SQUARE INCH
DRAIN	PT	PRESSURE TREATED
FLOOR	QTY	QUANTITY
S	REF	REFRIGERATOR
ON	SD	SMOKE DETECTOR
CAL	SPEC	SPECIFICATION
R	SYM	SYMMETRICAL
DRAIN	TELE	TELEPHONE
FLOOR	TEMP	TEMPERED
S	TSTAT	THERMOSTAT
ON	TME	TO MATCH EXISTING
CAL	T&B	TOP AND BOTTOM
R	T&G	TONGUE AND GROOVE
DRAIN	XFMR	TRANSFORMER
FLOOR	TYP	Typical
FLOOR LEVEL	UNO	UNLESS NOTED OTHERWISE
IZED	VIF	VERIFY IN FIELD
BEAM	WIC	WALK IN CLOSET
FAULT CIRCUIT	W/D	WASHER AND DRYER
R	WH	WATER HEATER
FAULT INTERRUPTER	WP	WEATHER PROOF
OOD	W/H	WATER HEATING

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**GENERAL NOTES:**

6 PLAN SET, COMBINED WITH THE BUILDING CONTRACT, PROVIDES  
7 BUILDING DETAILS FOR THE RESIDENTIAL PROJECT. THE CONTRACTOR  
8 SHALL VERIFY THAT SITE CONDITIONS ARE CONSISTENT WITH THESE PLANS  
9 BEFORE STARTING WORK. WORK NOT SPECIFICALLY DETAILED SHALL BE  
10 INSTRUCTED TO THE SAME QUALITY AS SIMILAR WORK THAT IS DETAILED.  
11 WORK SHALL BE DONE IN ACCORDANCE WITH FLORIDA BUILDING CODES  
12 AND LOCAL CODES. CONTRACTOR SHALL BE RESPONSIBLE AND BEAR ANY  
13 FINES OR PENALTIES FOR CODE, ORDINANCE, REGULATION OR BUILDING  
14 PROCESS VIOLATIONS. INSURANCES SHALL BE IN FORCE THROUGHOUT THE  
15 OPERATION OF THE BUILDING PROJECT.

CONTRACTOR SHALL DEFEND, INDEMNIFY, AND SAVE HARMLESS THE  
OWNER, ENGINEER, & THEIR PERSPECTIVE MEMBERS, REPRESENTATIVES,  
AGENTS, & EMPLOYEES, IN BOTH INDIVIDUAL & OFFICIAL CAPACITIES AGAINST  
ALL CLAIMS, DAMAGES, LOSSES & THE EXPENSES, INCLUDING ATTORNEYS'

5, DAMAGE, DEFECTS, LOSSES & THE EXPENSES, IN DEEDING, FURNISHING, 5,  
5, CAUSED BY, GROWING OUT OF, OR INCIDENTAL TO THE PERFORMANCE  
THE WORK UNDER THE CONTRACT BY THE CONTRACTOR OR ITS  
CONTRACTORS TO THE FULL EXTENT AS ALLOWED BY THE LAWS OF THE  
STATE OF FLORIDA & NOT BEYOND ANY EXTENT WHICH WOULD RENDER

SE PROVISIONS VOID OR UNENFORCEABLE, IN THE EVENT OF ANY SUCH  
TRY (INCLUDING DEATH) OR LOSS OR DAMAGE, OR CLAIMS THEREFORE,  
CONTRACTOR SHALL GIVE PROMPT NOTICE TO OWNER.

THE DIMENSIONS AND SIGHTS ARE NOT DRAWN TO SCALE. THE ENGINEER/DESIGNER SHALL CONSULTED FOR CLARIFICATION IF SITE CONDITIONS ARE ENCOUNTERED THAT ARE DIFFERENT THAN SHOWN, IF DISCREPANCIES ARE FOUND IN THE DRAWINGS OR NOTES, OR IF A QUESTION ARISES OVER THE INTENT OF THE

NS OR NOTES. CONTRACTOR SHALL VERIFY AND IS RESPONSIBLE FOR DIMENSIONS (INCLUDING ROUGH OPENINGS).

CONTRACTOR IS RESPONSIBLE FOR PROVIDING A COMPLETE SET OF DRAWINGS & SPECIFICATIONS TO EACH SUBCONTRACTOR & FOR INSURING THAT THE WORK OF EACH SUBCONTRACTOR IS COORDINATED WITH THE WORK OF ALL OTHER SUBCONTRACTORS.

TRADES SHALL MAINTAIN A CLEAN WORK SITE AT THE END OF EACH WORK DAY.

SEE ADDITIONAL NOTES CALLED OUT ON OTHER SHEETS.

**ELEVATION - FRONT**  
SCALE: 1/4" = 1'-0"

**ELEVATION - LEFT SIDE**  
SCALE: 1/4" = 1'-0"

6:12 PITCH

11'-3" ROOF PEAK

6:12 PITCH

16" O.H.

8' CEILING HEIGHT

80" HEADER

VINYL SIDING

FINISHED FLOOR

FINISHED GRADE

ARCHITECTURAL ASPHALT SHINGLES

6:12 PITCH

E-1

E-2

Detailed description: The figure contains two architectural elevation drawings of a house. The left elevation, labeled E-1, shows the front of the house with a gabled roof, a central entrance featuring a double door and sidelights, and two windows on either side. The right elevation, labeled E-2, shows the left side of the house, which is identical in design to the front. Both elevations feature vinyl siding, architectural asphalt shingles on the roof, and a 6:12 roof pitch. The roof peak is 11'-3" above the finished grade. The finished floor is at 80" header height, and the ceiling height is 8'. A 16" overhang (O.H.) is shown on the front elevation. The drawings also indicate the finished grade and the location of the finished floor.

**Elevation - Right Side (E-3)**

6:12 PITCH

11'-3" ROOF PEAK

6:12 PITCH

ARCHITECTURAL ASPHALT SHINGLES

8' CEILING HEIGHT

16" O.H.

80" HEADER

VINYL SIDING

FINISHED FLOOR

FINISHED GRADE

**Elevation - Rear (E-4)**

6:12 PITCH

ARCHITECTURAL ASPHALT SHINGLES

VINYL SIDING

FINISHED GRADE

SCALE: 1/4" - 1'-0"

SCALE: 1/4" - 1'-0"



**BAYSIDE ENGINEERING  
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**A NEW PLAN FOR:**

**S.H.S. CONTRACTING, LLC**  
**LOTS 5 & 6 BLOCK 2 WATSON RD.,**  
**DEFUNIAK SPRINGS**  
**FLOOR PLAN & FOUNDATION PLAN**  
**WALTON COUNTY, FLORIDA**

**LOTS 5 & 6  
MIBINED**

SCALE:  
1/4" = 1'-0"  
  
DRAWN:  
MDC  
  
CHECKED:  
JDB  
  
PROJECT NO.:  
25590.21


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**25590.21.PLAN**

**DATE:**  
**11/24/2025**

**FINAL**

**SHEET NUMBER**


**A-2**

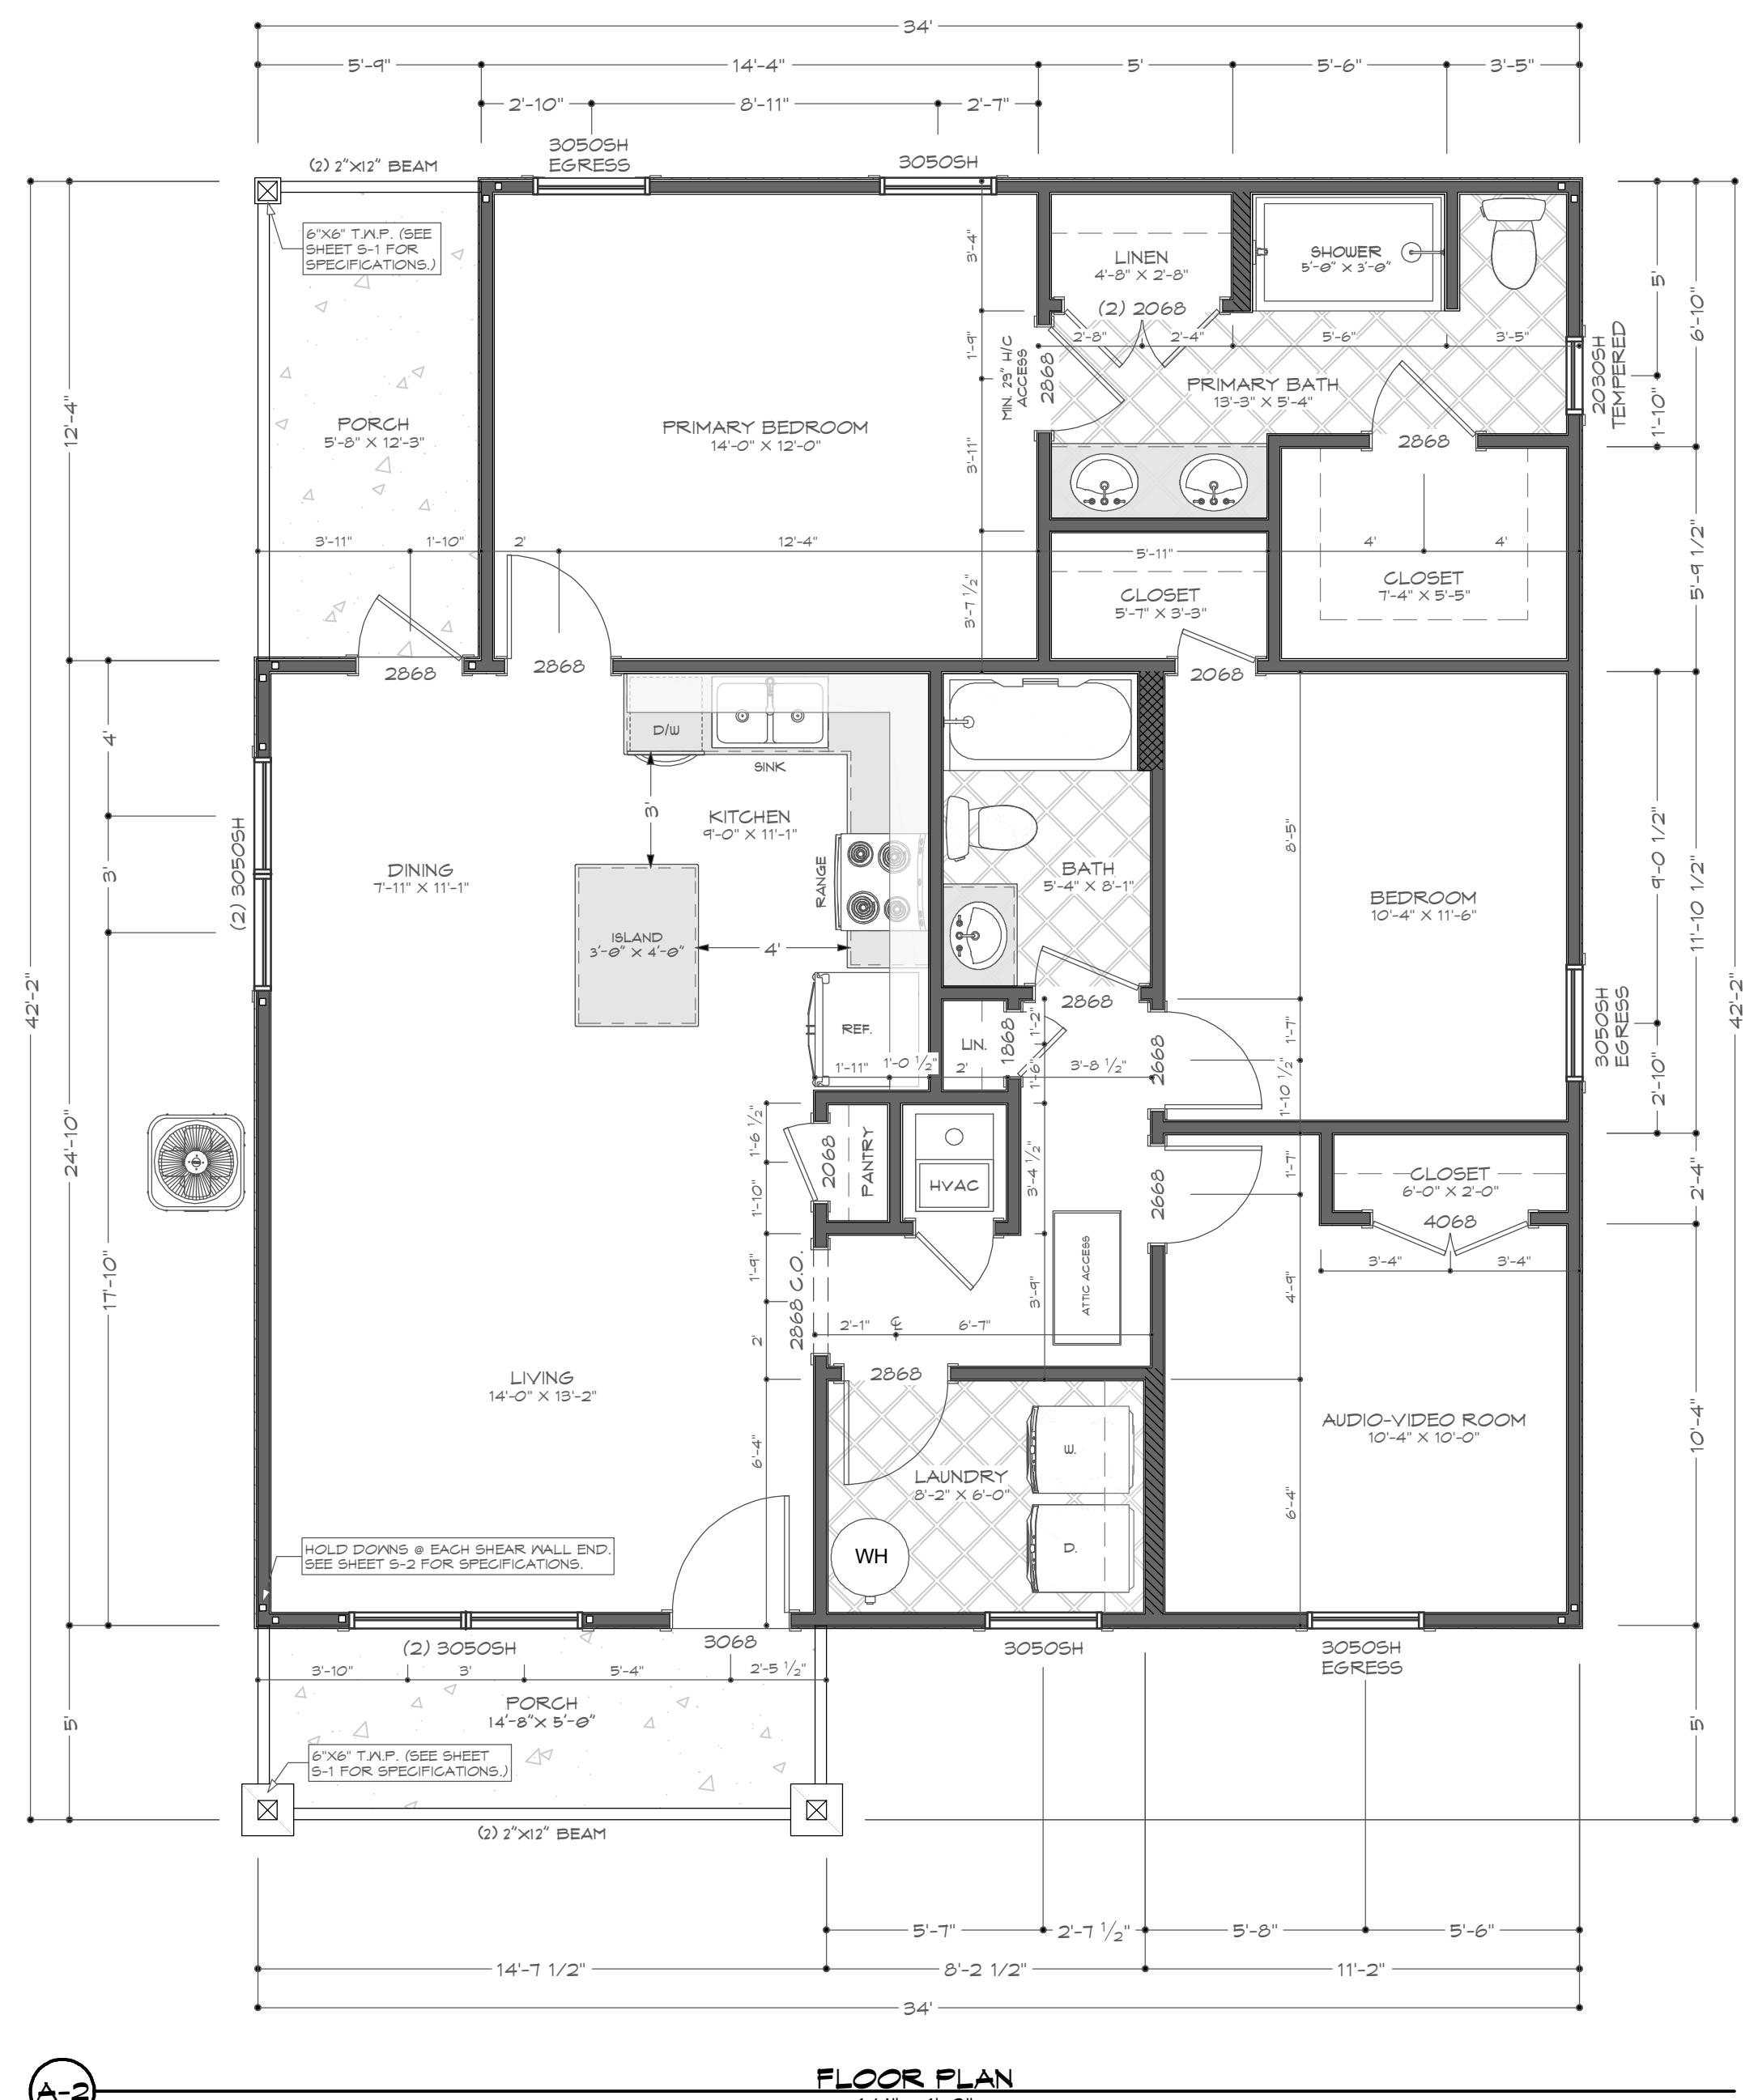

A-2

## **FLOOR PLA**

$$1/4" = 1'-0"$$

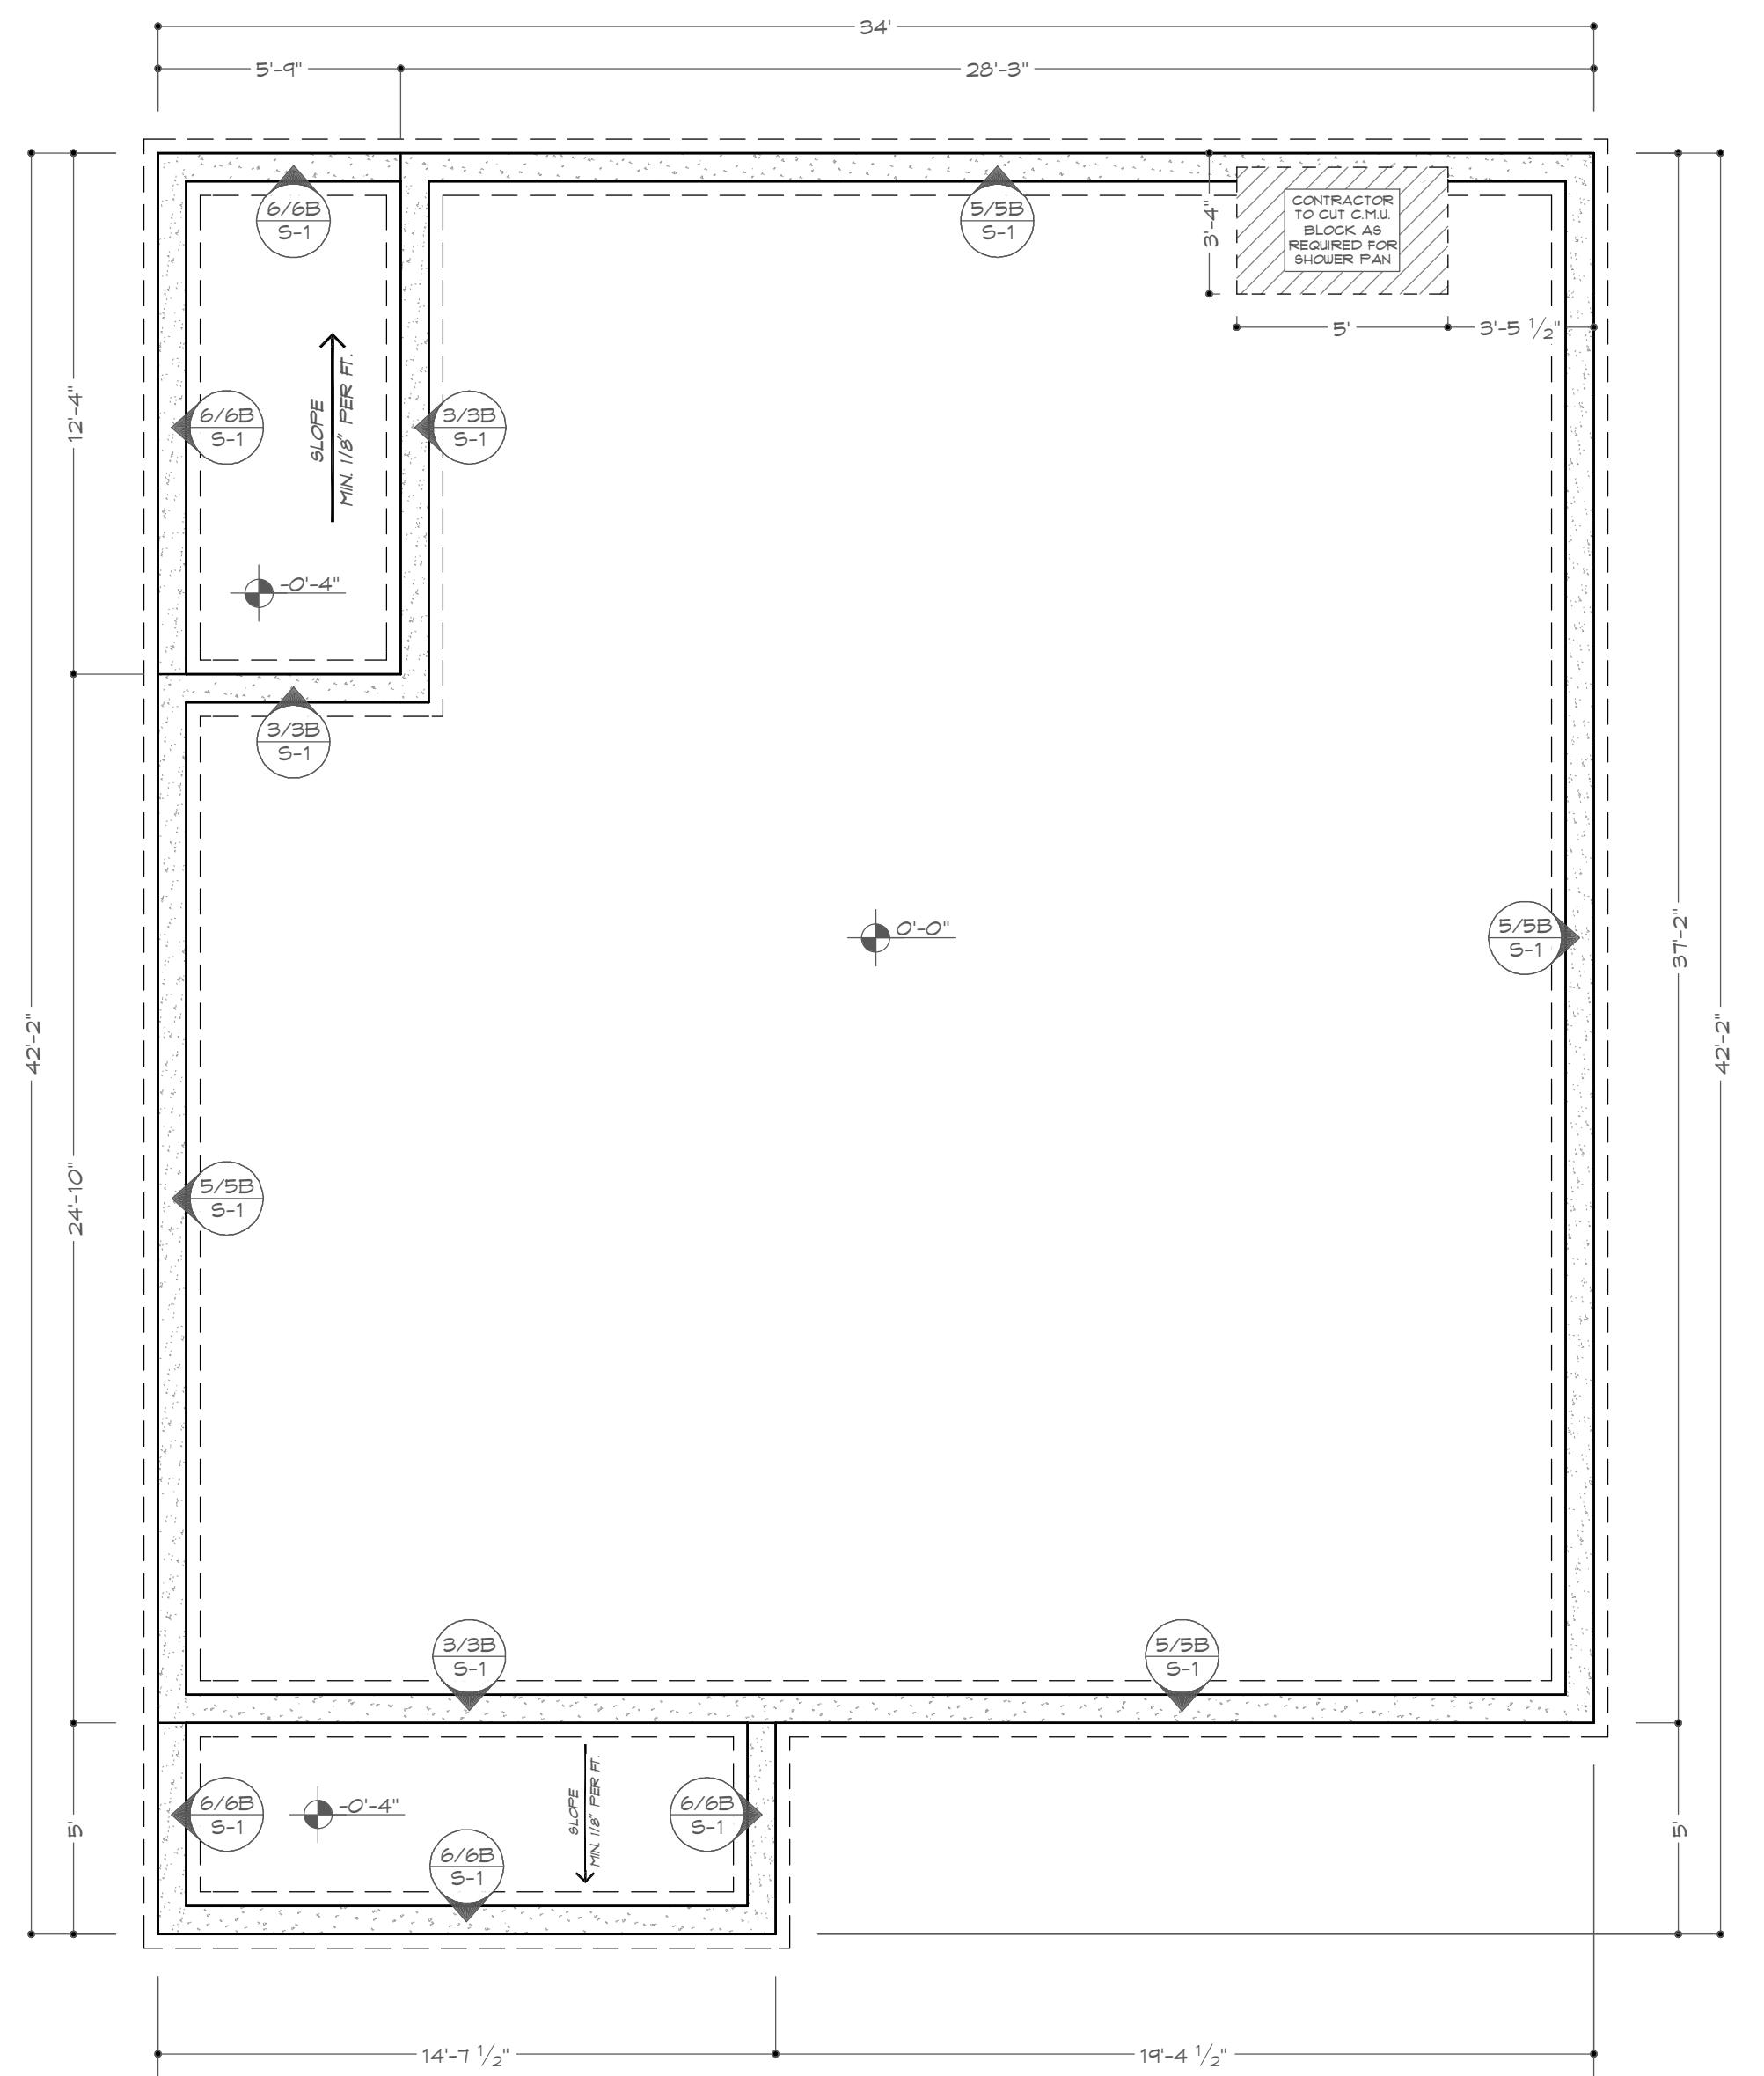

A-2

## FOUNDATION PLAN

1/4" = 1'-0"

WALL SCHEDULE	
EXTERIOR 2"X4" WALL	
INTERIOR 2"X8" WALL	
INTERNAL 2"X6" WALL	
INTERNAL 2"X4" WALL	
RAILING	


AREA CALCULATIONS	
LIVING SPACE	1,193 S.F.
FRONT PORCH	73 S.F.
REAR PORCH	71 S.F.
<b>TOTAL COVERED</b>	<b>1,337 S.F.</b>



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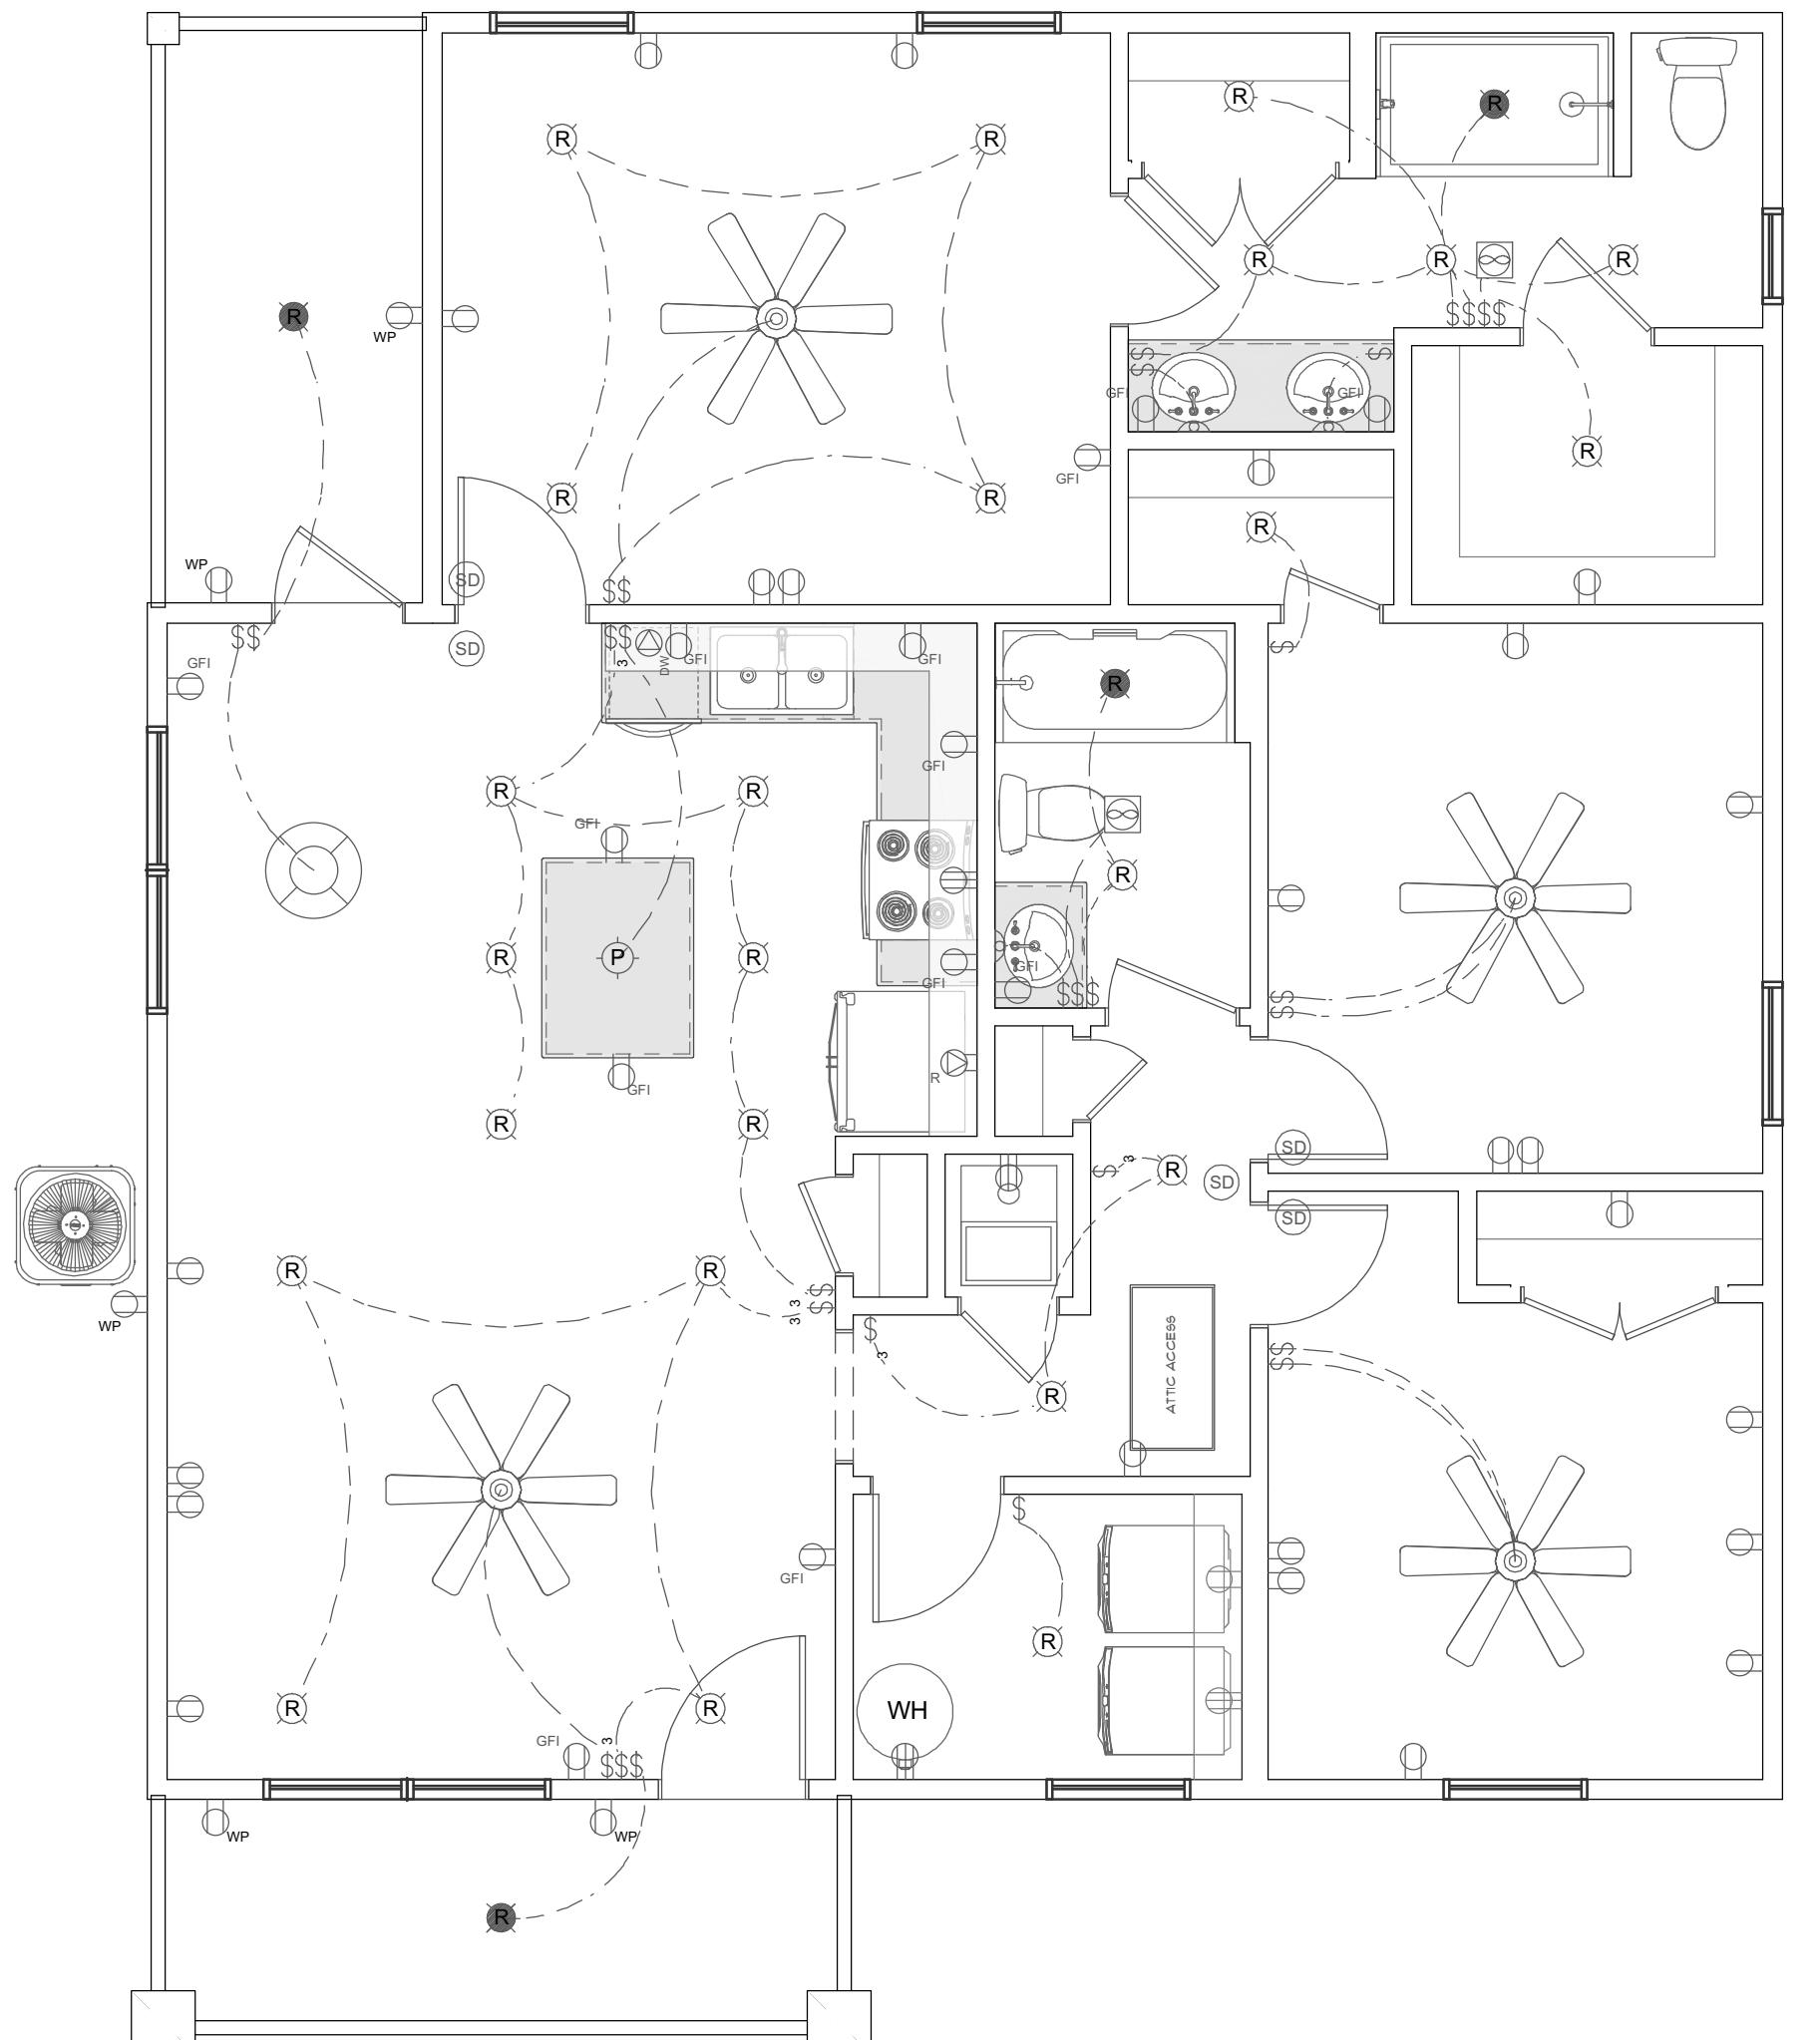
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A NEW PLAN FOR:  
S.H.S. CONTRACTING, LLC  
LOTS 5 & 6 BLOCK 2 WATSON RD.,  
DEFUNIAK SPRINGS  
ROOF FRAMING & ELECTRICAL PLAN  
(LOTS 5 & 6 COMBINED)  
WALTON COUNTY, FLORIDA




A-3

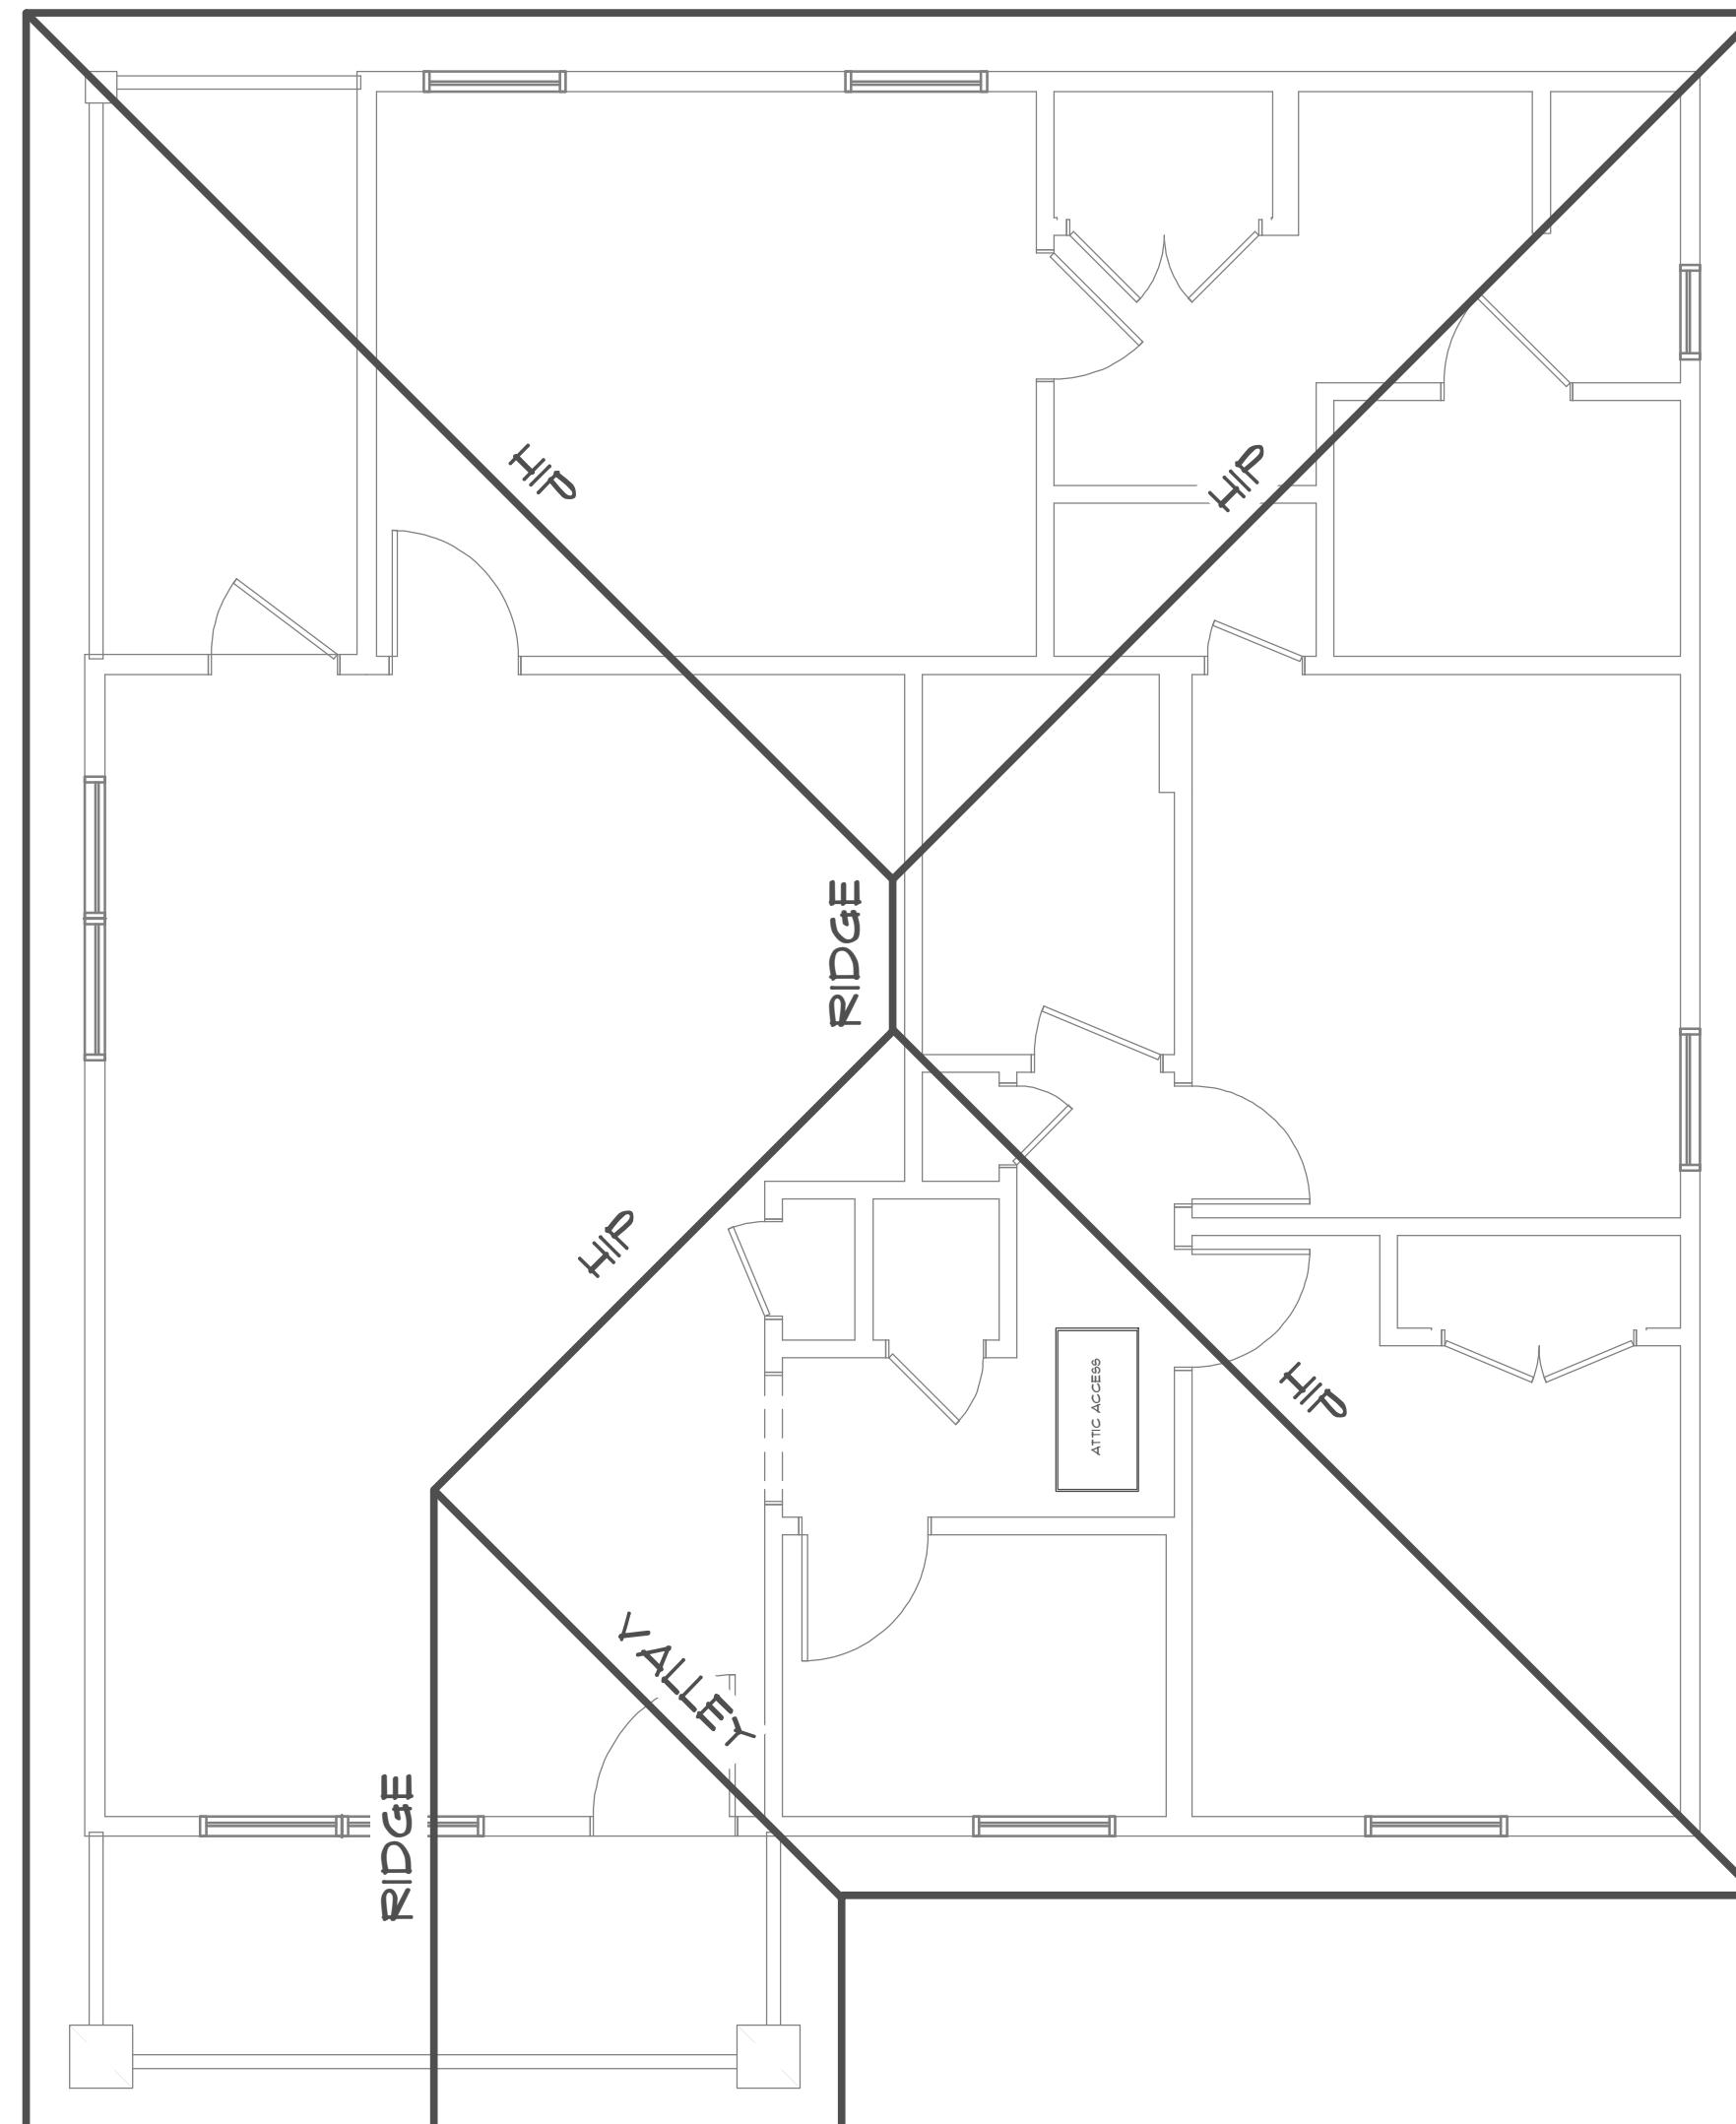ROOF FRAMING PLAN  
1/4" = 1'-0"



A-3

ELECTRICAL PLAN  
1/4" = 1'-0"

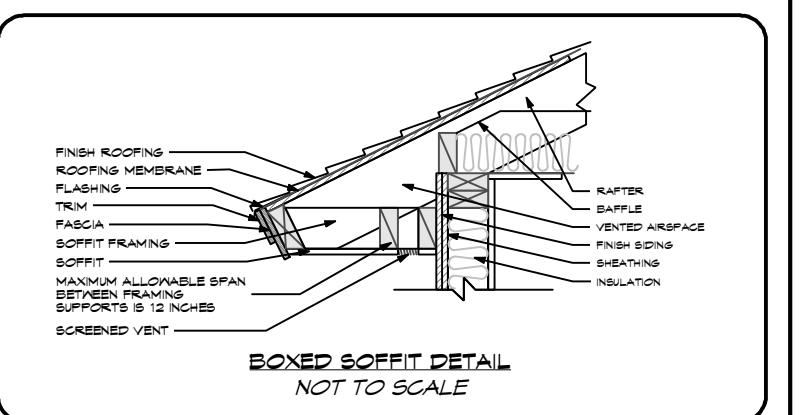

ROOF FRAMING PLAN NOTES:  
1. THE ROOF SYSTEM WILL BE CONSTRUCTED WITH PRE-ENGINEERED TRUSSES. THE TRUSSES SHALL BE DESIGNED (AND THE TRUSS DRAWINGS SHALL BE SIGNED AND SEALED BY A PROFESSIONAL ENGINEER WHO IS LICENSED TO PRACTICE IN FLORIDA). THE TRUSSES SHALL BE DESIGNED FOR A 150 M.P.H. WIND SPEED (ULTIMATE).  
2. THE ROOF OVERHANGS SHALL BE 16", U.N.O.

ELECTRICAL PLAN NOTES:  
1. HOME OWNER SHALL DO A Walk-THru WITH RELEVANT INSTALLERS TO VERIFY THE PLACEMENT OF OUTLETS, LIGHTS, SWITCHES, CABLE, DATA, PHONE, AUDIO, VACUUM, ETC.  
2. ALL OUTLETS AND LIGHTS TO HAVE DEDICATED CIRCUITS. SEE MFG'S Specs. FOR REQUIREMENTS.  
3. PROVIDE MIN. 200 AMP SERVICE TO MAIN PANEL.  
4. ALL OUTLETS AND LIGHTS TO BE GFCI PROTECTED.  
5. ALL BEDROOM OUTLETS AND LIGHTS TO BE GFCI PROTECTED.  
6. ALL OUTLETS AND LIGHTS TO BE GFCI PROTECTED.  
7. ALL BEDROOMS AND ONE IN EACH CORRIDOR ACCESSING BEDROOMS, GUEST BATH, AND BATHROOMS TO HAVE A GFCI OUTLET.  
8. GFCI OUTLETS TO HAVE GFCI PROTECTION.  
9. SMOKE DETECTORS TO HOUSE POWER AND INTERCONNECT SO THAT WHEN ONE GOES OFF, THEY ALL WILL SOUND. PROVIDE BATTERY BACKUP FOR ALL UNITS.  
10. CABLES TO BE TIGHTLY TIED DOWN.  
11. FINAL SWITCHES FOR TIMERS AND DIMMERS SHALL BE VERIFIED WITH HOME OWNER.  
12. FIXTURES TO BE SECURED BY HOME OWNER.  
13. OUTLETS OVER COUNTERTOPS TO BE 15 1/2" ASF.  
14. OUTLETS OVER SINKS AND BATHS TO BE 15 1/2" ASF.  
(ASF = ABOVE SUBLLOOR)  
AUDIO:  
1. ALL OUTLETS AND AUDIO CONTROLS AS INDICATED IN THE PLAN.  
2. RUN CIRCUIT OF SPEAKER WIRING TO AUDIO HOME PANEL IN SPECIFIED FLOOR.  
3. ALL SPEAKERS TO BE APPROVED BY HOME OWNER.  
DATA:  
1. LOCATE JACKS AS INDICATED IN THE PLAN. INSTALL DATA CABLE.  
2. CABLES FOR DATA SYSTEM TO BE APPROVED BY HOME OWNER.  
DATA / CABLE:  
1. CABLES FOR DATA SYSTEM PANELS AS INDICATED IN THE PLAN. SYSTEM TO BE APPROVED BY HOME OWNER.

ELECTRICAL LEGEND	
	LIGHTING
	PENDANT / RECESSED / WET RATED / FLUSH MOUNT
	DUAL SPOTLIGHT / SCONCE / WALL LAMP
	UNDER CABINET LED PUCK / LED STRIP / CEILING LED
	CHANDELIER / FAN W/ LIGHT
	SWITCH / 3-WAY / 4-WAY
	OUTLETS - 120V WALL & CEILING GFCI / WATER PROOF / 220V
	APPLIANCE SPEC: REFRIGERATOR / DISH WASHER / / GARBAGE DISPOSAL
	OTHER: MEP
	SMOKE / CARBON MONOXIDE DETECTOR COMBINATION
	CEILING MOUNTED VENTILATION FAN / VENTILATION FAN W/ LIGHT

SCALE:  
1/4" = 1'-0"

DRAWN:  
MDG

CHECKED:  
JDB

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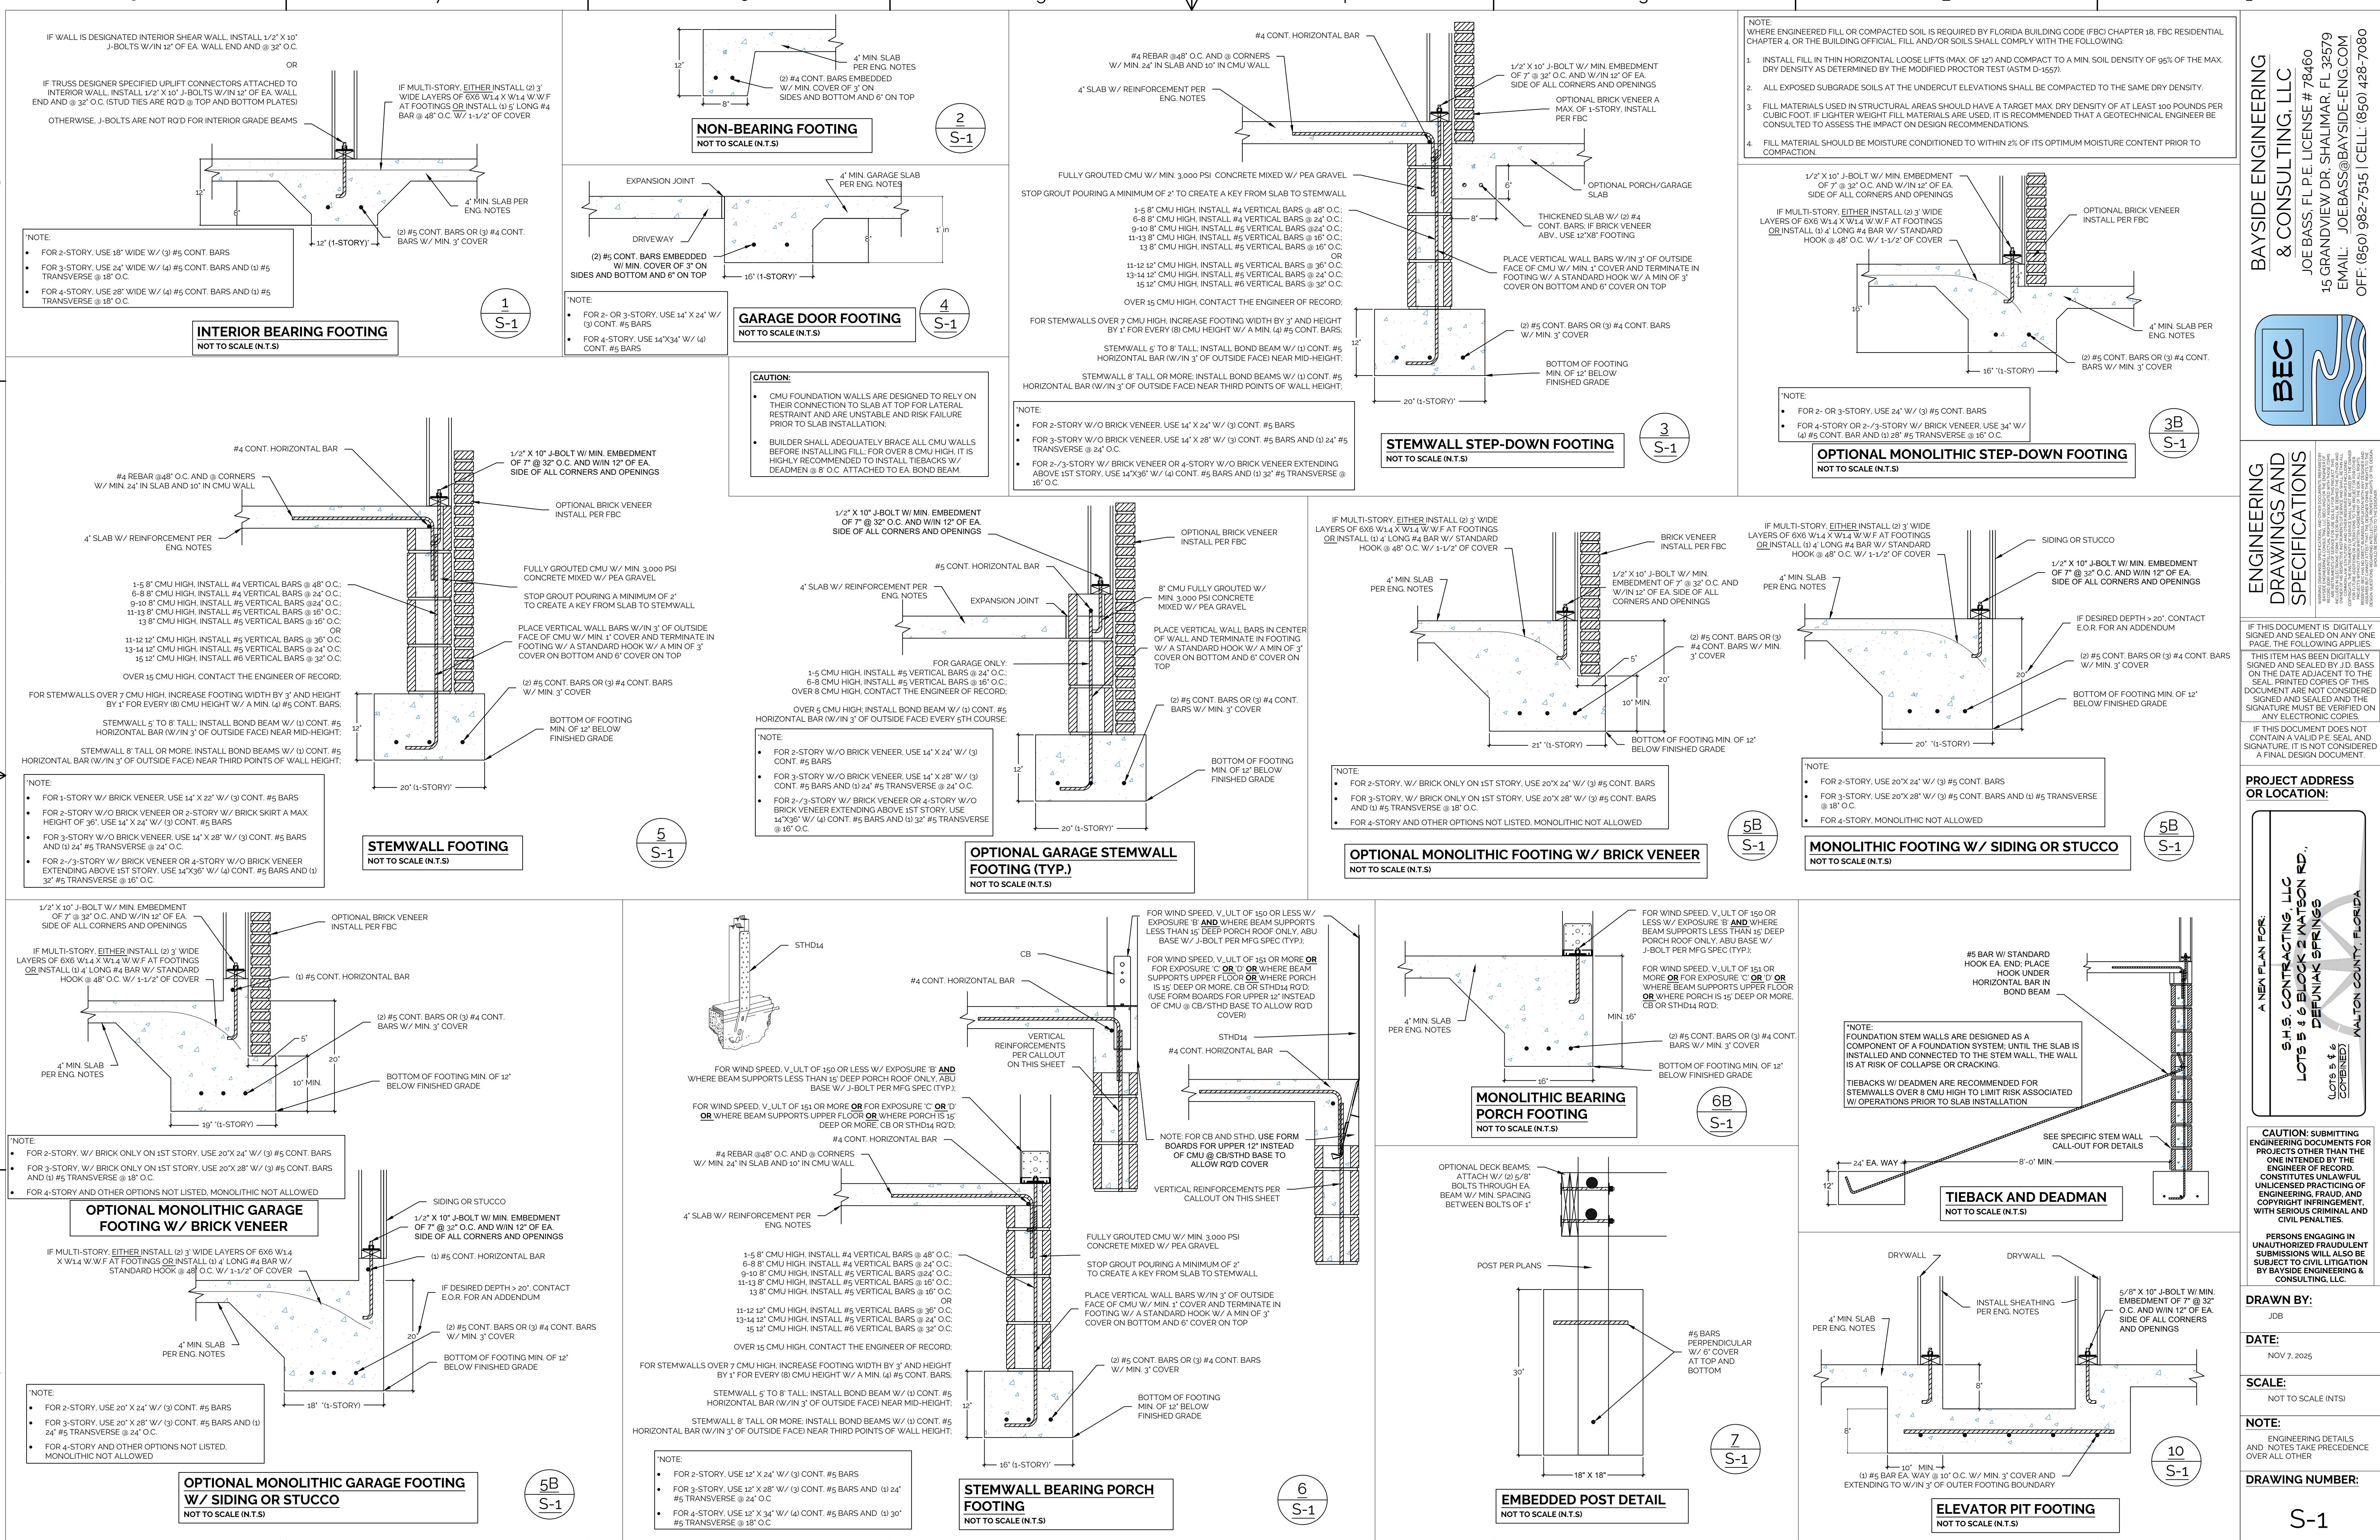
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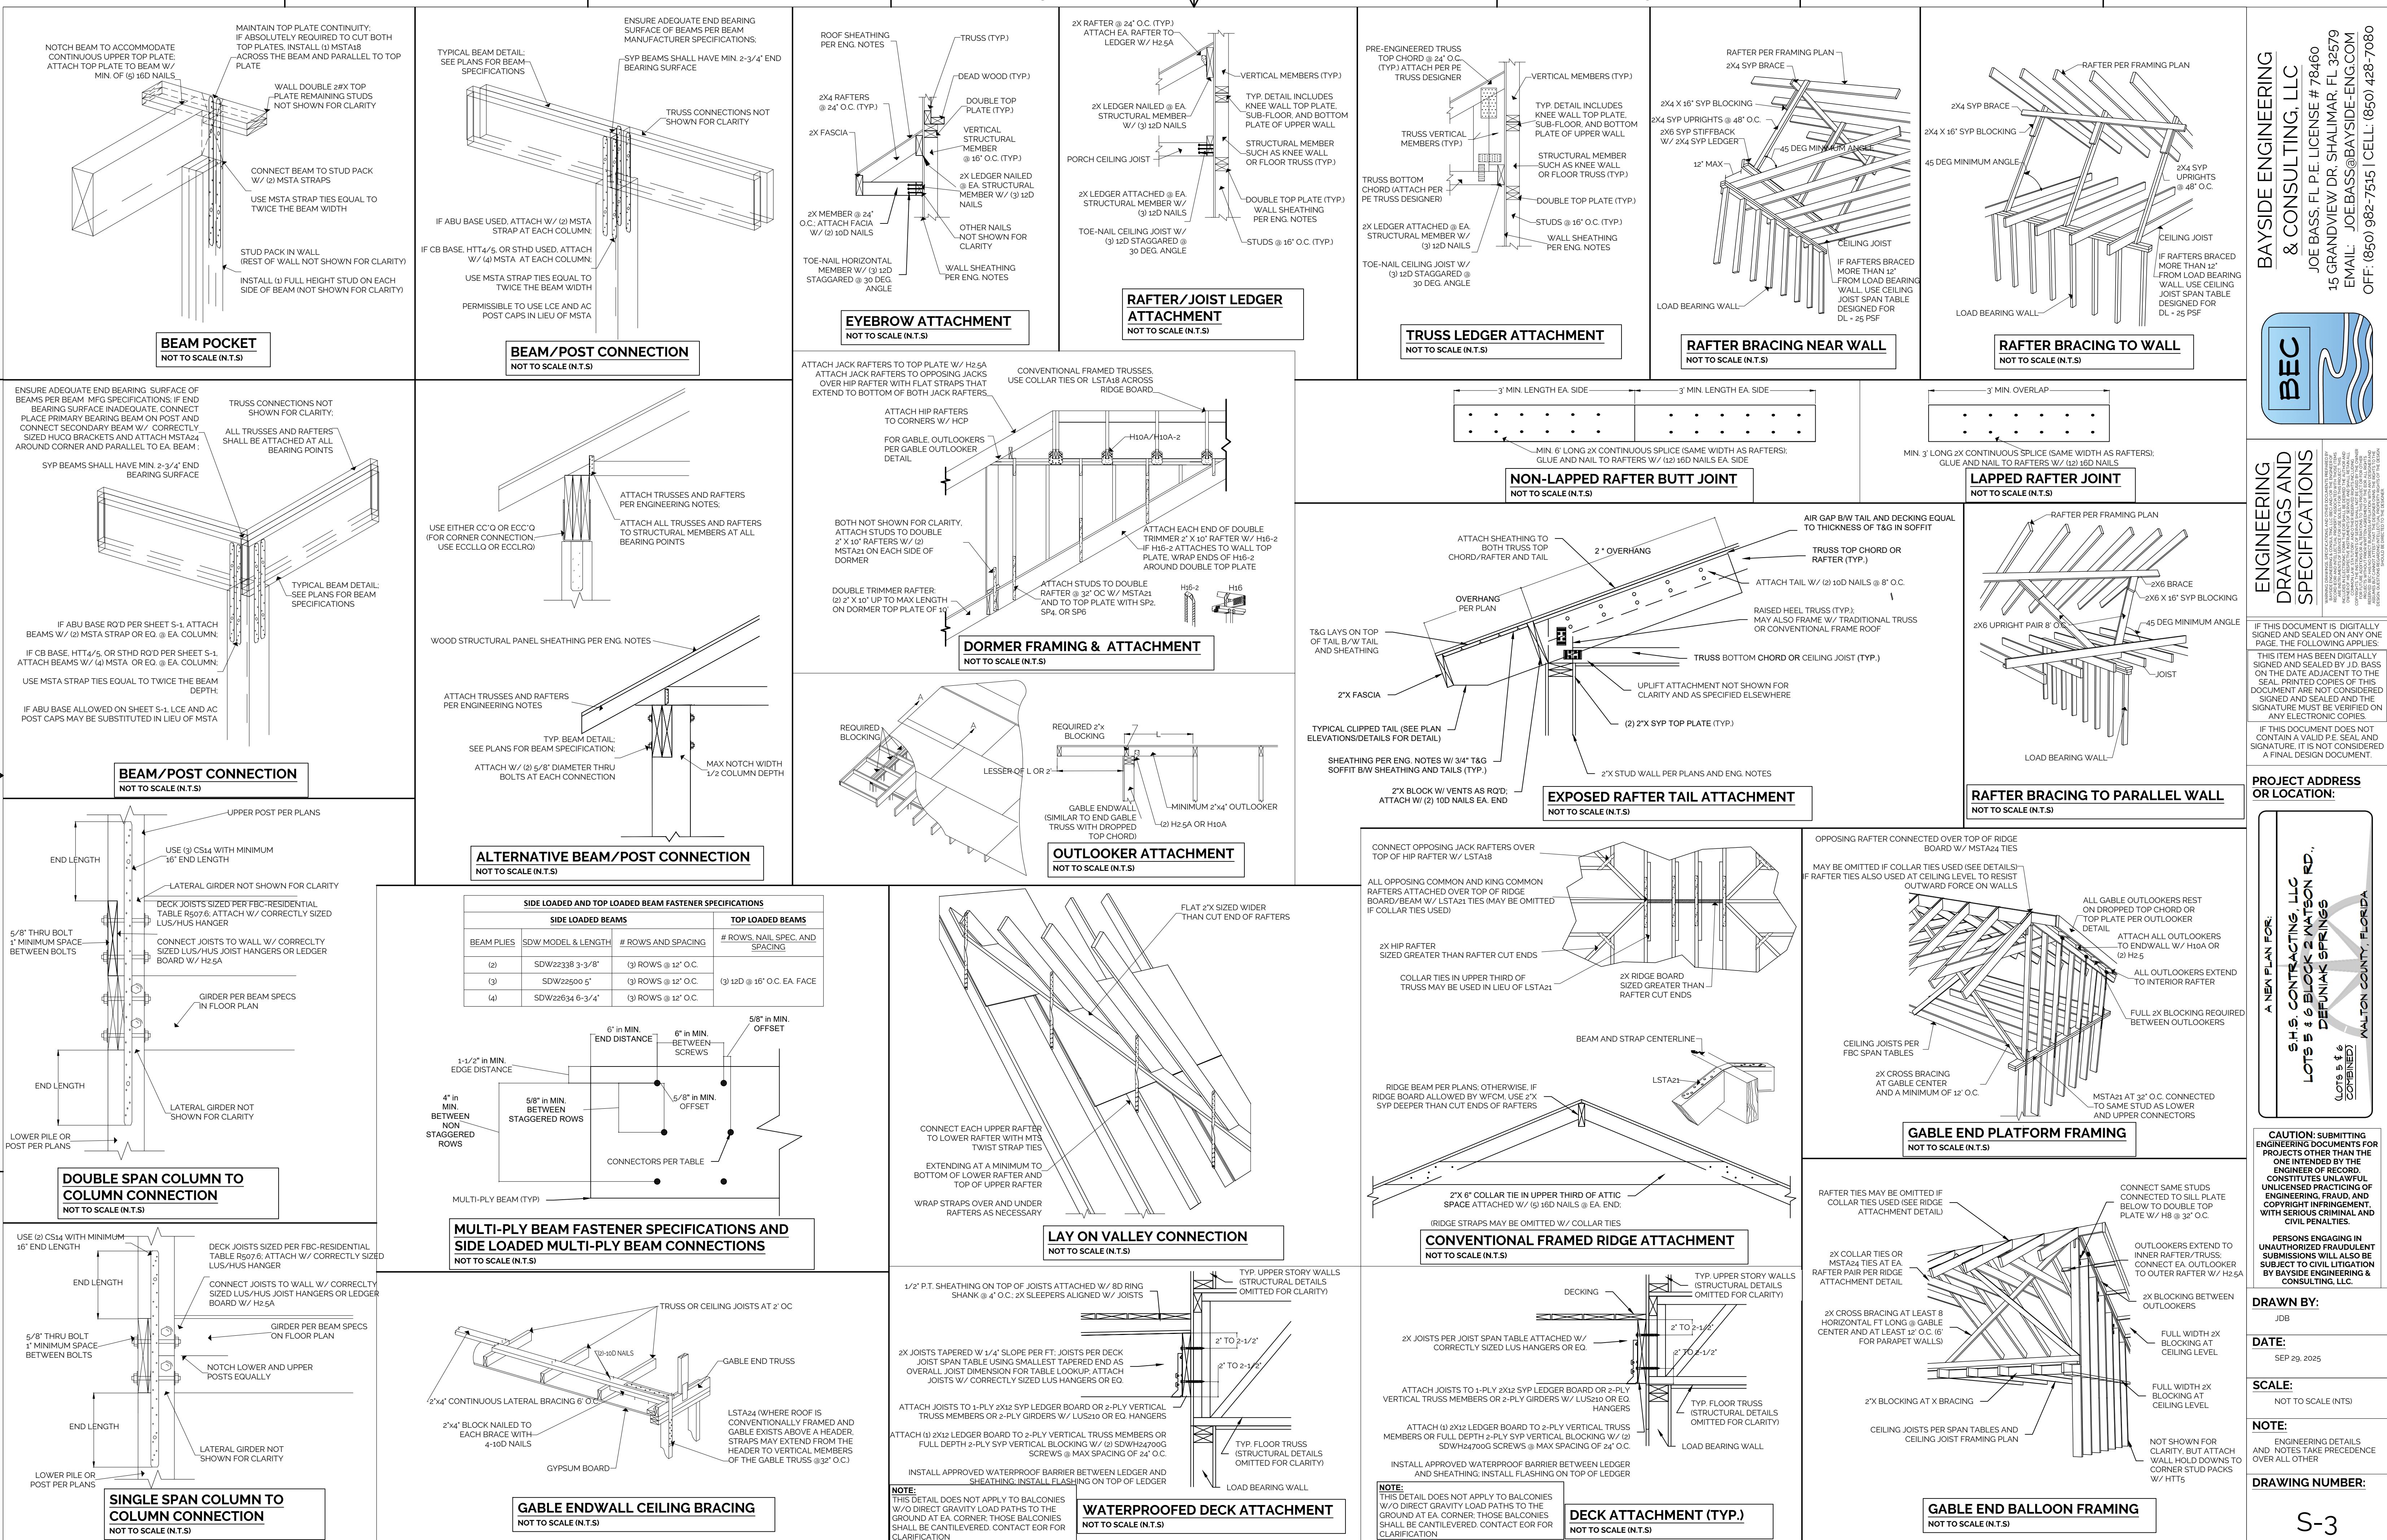
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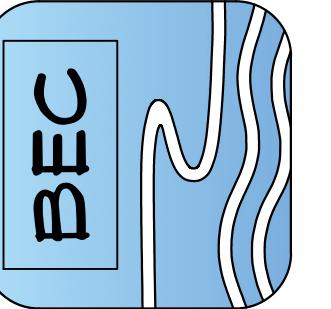
A-3








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ENGINEERING DRAWINGS AND SPECIFICATIONS

THIS DOCUMENT IS DIGITALLY SIGNED AND SEALED ON ANY ONE PAGE. THE FOLLOWING APPLIES:  
THIS ITEM HAS BEEN DIGITALLY SIGNED AND SEALED BY J.D. BASS ON THE DATE ADJACENT TO THE SEAL PRINT. THE CONTENTS OF THIS DOCUMENT ARE NOT CONSIDERED SIGNED AND SEALED AND THE SIGNATURE MUST BE VERIFIED ON ANY ELECTRONIC COPIES.  
IF THIS DOCUMENT DOES NOT CONTAIN A SIGNATURE AND SIGNATURE, IT IS NOT CONSIDERED A FINAL DESIGN DOCUMENT.

PROJECT ADDRESS OR LOCATION:



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PERSONS ENGAGING IN UNAUTHORIZED FRAUDULENT SUBMISSIONS WILL ALSO BE SUBJECT TO CIVIL LITIGATION BY BAYSIDE ENGINEERING & CONSULTING, LLC.

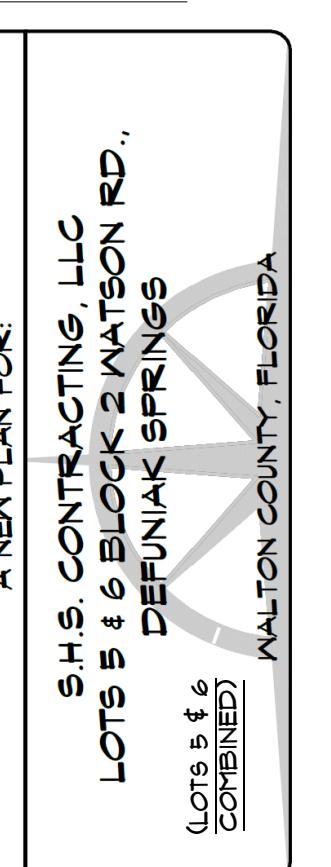DRAWN BY: JDB

DATE: SEP 29, 2025

SCALE: NOT TO SCALE (N.T.S)

NOTE: ENGINEERING DETAILS AND NOTES TAKE PRECEDENCE OVER ALL OTHER

DRAWING NUMBER: S-3

**SECTION 1. - DESIGN CRITERIA**

A. CONSTRUCTION SHALL COMPLY WITH ALL THE FOLLOWING CODES AND GUIDANCE DOCUMENTS

- 2023 FLORIDA BUILDING CODE, RESIDENTIAL (FBC-R), 8TH EDITION
- AWC WOOD FRAME CONSTRUCTION MANUAL FOR ONE- AND TWO-FAMILY DWELLINGS, LATEST EDITION
- AWC SPECIAL DESIGN PROVISIONS FOR WIND AND SEISMIC (SDPWS), LATEST EDITION
- AITC TIMBER CONSTRUCTION MANUAL, LATEST EDITION
- ACI CODE REQUIREMENTS FOR RESIDENTIAL CONCRETE, LATEST EDITION (ACI 332)
- ACI BUILDING CODE REQUIREMENTS AND SPECIFICATIONS FOR MASONRY STRUCTURES, LATEST EDITION (TMS 402/602)
- ACI BUILDING CODE REQUIREMENTS FOR STRUCTURAL CONCRETE, LATEST EDITION (ACI 318)
- CRSI PLACING REINFORCING BARS, LATEST EDITION

**B. DESIGN LOADS**

GENERAL		FLOOR TRUSS DESIGN LOADS		ROOF TRUSS DESIGN LOADS	
FLOOR	40 PSF	TCLL	40 PSF	TCLL	20 PSF
DECKS	40 PSF	TCDL	15 PSF	TCDL	15 PSF (SHINGLES AND METAL) 35 PSF (CLAY, TILE, ETC.)
BALCONIES	40 PSF	BCLL	0 PSF	BCLL	0 PSF (EXCEPTIONS PER FBC TABLE R301.5)
ROOF	20 PSF	BCDL	10 PSF	BCDL	10 PSF

NOTE: AS NOTED ON FLOOR PLANS, INTERIOR SHEAR WALLS BEARING ON FLOOR TRUSS SYSTEMS SHALL BEAR ON FULL LENGTH (3) 1/3-4" X 16" LVL'S

**C. MAIN WIND FORCE RESISTING SYSTEM (MWFRS) DESIGN ASSUMPTIONS**

ULTIMATE DESIGN WIND SPEED, $V_{ULT}$	149 MPH (F. WALTON COUNTY, BY INTERPOLATION)
IMPORTANCE FACTOR	1
RISK CATEGORY	II
EXPOSURE CATEGORY	B
INTERNAL PRESSURE COEFFICIENT	-0.18 TO +0.18
BUILDING TYPE	ENCLOSED
MEAN ROOF HEIGHT	40'

**D. MAIN WIND FORCE RESISTING SYSTEM (MWFRS) DESIGN METHOD - DIRECTIONAL PROCEDURE:**

ZONE	CONDITION	SIDE	PSF
WALL	WORST CASE: (GC <sub>W</sub> ) 4 <sup>th</sup> STORY (WHERE APPLICABLE)	WINDWARD	
WALL	WORST CASE: (GC <sub>W</sub> ) 3 <sup>rd</sup> STORY (WHERE APPLICABLE)	WINDWARD	30.49
WALL	WORST CASE: (GC <sub>W</sub> ) 1 <sup>st</sup> STORY (WHERE APPLICABLE)	WINDWARD	28.11
ROOF	WORST CASE: NORMAL TO RIDGE	LEEWARD	-27.02
OVERHANG	WORST CASE: NORMAL TO RIDGE	LEEWARD	-46.60

**E. ALL COMPONENTS AND CLADDING SHALL COMPLY WITH THE FOLLOWING DESIGN PRESSURES CONSISTENT WITH FBC, RESIDENTIAL TABLE R301.2(2) AND FIGURE R301.2(7):**

ZONES PER FIGURE R301.2(7)	EFFECTIVE WIND AREA (SQ.FT.)	LOADS (PSF)
(+)	(-)	
1	ALL	17.3
2	ALL	17.3
3	ALL	17.3
4	ALL	17.3
5	ALL	17.3
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